## RANCHO SANTIAGO COMMUNITY COLLEGE DISTRICT



## **ADDENDUM NO. 02**

## Bid #1434 at CAMPUS ENTRANCE IMPROVEMENT – PHASE 1 PROJECT

Santiago Canyon College 8045 East Chapman Avenue, Orange, CA 92869

Project ID #3739, DSA #04-121029

**January 19, 2023** 

#### Owner:

Rancho Santiago Community College District 2323 North Broadway, Room 112 Santa Ana, California 92706

# RECEIPT OF THIS ADDENDUM MUST BE ACKNOWLEDGED ON BID FORM WHEN SUBMITTED

The following changes, additions, deletions or corrections shall become a part of the Contract Documents for the project named on the previous page and all other conditions shall remain the same. The Bidders shall be responsible for transmitting this information to all affected Subcontractors and Suppliers, prior to the closing of Bids. Prospective Bidders shall acknowledge receipt of all Addenda in the space provided on the Bid Proposal Form by the number (list every addenda). Failure to do so shall deem the Bid Proposal as non-responsive and subject the Bidder to disqualification.

### Item No. AD 2-1 Additional Question Deadline

The District has established an additional question deadline to allow contractors to review new information in Addendum No. 2. Pre-Bid Questions and requests for clarifications must be submitted to the District by Wednesday, 5:00 P.M. January 25, 2023 on the District's Pre-Bid Clarification Form provided within. Bidders are solely responsible for submission of Pre-Bid Questions prior to such time/date; the District will not respond to Pre-Bid Questions submitted after such time/date. Responses to timely submitted Pre-Bid Questions will be in the form of Addenda posted on the District's Purchasing Department webpage. Bidders are solely responsible for review of the District's Purchasing Department webpage to obtain Addenda issued during the bidding process. No person is authorized to: (i) render an oral interpretation, correction or modification of any portion of the Contract Documents; or (ii) provide oral responses to Pre-Bid Questions. No Bidder may rely on any such oral interpretation, correction, modification or response.

### Item No. AD 2-2 Clarification regarding District Allowance

The allowance amount, established by the District, will be published as part of the Bid Results. The bidders should not include an allowance amount in their bid.

#### Item No. AD 2-3 Responses to Questions

The following provides a response to the Bidder's Request for Pre-Bid Information submitted on the Pre-Bid Clarification Form. See attached for a total of (4) RFI Response(s).

#### Item No. AD 2-4 Specifications (DSA Addendum 1, approved)

The following provides the DSA approved specifications. See attached DSA Addendum 1.

## Item No. AD 2-5 Drawings (DSA Addendum 2, approved)

Revisions have been made to Civil, Electrical, and Landscaping sheets. See attached DSA Addendum 2.

### Item No. AD 2-6 Drawings (DSA Addendum 3, pending DSA approval)

The following provides revisions made to DSA specifications, and Architectural, Civil, Electrical, and Landscaping sheets. See attached DSA Addendum 3 (pending DSA approval).

### Item No. AD 2-7 Drawings (Construction Logistics & Phasing)

Construction logistics and phasing plans. See attached Phasing and Logistical Drawings.

Enclosure: PBC (4 pages)

Specifications, DSA Addendum 1 (31 pages)

Drawings, DSA Addendum 2 (9 pages)

Drawings, DSA Addendum 3 (pending DSA approval). (36 pages)

Phasing and Logistical Drawings (3 pages)

This is the end of Addendum No. 02

(Email this completed form to FacilitiesBid@rsccd.edu. See Instructions to Bidders.)

PROJECT NAME:	Campus Entrance Improvements - P	hase 1 at Santiago Canyon College
PROJECT NUMBER:	3739	BID NUMBER: 1434
EMAIL TO: facilitiesbi	l@rsccd.edu	
DATE:		
FROM:		EMAIL:
SPEC		RAWING
SECTION:		UMBER:
REQUESTED CLARIFIC	CATION:	
RESPONSE TO CLARIF	ICATION:	

Attach additional numbered sheets as necessary; however, only one (1) request shall be contained on each submitted form.

END OF DOCUMENT

(Email this completed form to FacilitiesBid@rsccd.edu. See Instructions to Bidders.)

PROJECT N	AME:	Campus Entrance Improvements	s - Phase 1 a	t Santiago Canyo	n College
PROJECT N	UMBER:	3739	Е	ID NUMBER:	1434
EMAIL TO	: facilitiesbid@1	rsccd.edu	•		
DATE:	12/20/2022				
FROM:	Marina Landsca	ape	EMAII	: Estimator@ma	arinaco.com
SPEC			DRAWIN	7	
SECTION:			NUMBER	11 / 01	
REQUESTE	D CLARIFICAT	TION: Irrigation Trenching			
		et L-4.01, the trenching depth app	ly for main I	ne is 18" depth, b	out the specs and the
legend of it	tem show 24" de	epth. Please clarify.			
RESPONSE	TO CLARIFICA	ATION:			
Contrac	ctor shall follo	w the Legend and the Speci	fications,	and install the	pipe at 24" depth.
-Chris (	Curry, Glasir [	Design - 12/22/2022			

Attach additional numbered sheets as necessary; however, only one (1) request shall be contained on each submitted form.

END OF DOCUMENT

(Email this completed form to FacilitiesBid@rsccd.edu. See Instructions to Bidders.)

PROJECT N	ROJECT NAME: Campus Entrance Improvements - Phase 1 at Santiago Canyon College					
PROJECT N	UMBER:	3739	BII	NUMBER:	1434	
EMAIL TO	: facilitiesbid@	rsccd.edu				
DATE:	12/20/2022					
FROM:	Marina Landsca	ape	EMAIL:	Estimator@ma	arinaco.com	
CDEC			DB AUDIG			
SPEC SECTION:			DRAWING NUMBER:	L-4.01		
		FION. Mainline Fittings	TVOTVIBER:	l .		
		ΓΙΟΝ: Mainline Fittings		10 had the energy		
require sch	ce to detail I snee n80. Please clari	et L-4.01, the fitting use for main lify.	ne snown sch	40, but the spec	s and legend of items	
·						
RESPONSE	TO CLARIFICA	ATION:				
Contrac	stor shall insta	Il Sch.80 fittings for the mair	olina nartha	Legend		
-Chris C	Curry, Glasir D	Design - 12/22/2022	illie, per trie	Legena.		
		•				

Attach additional numbered sheets as necessary; however, only one (1) request shall be contained on each submitted form.

END OF DOCUMENT

(Email this completed form to FacilitiesBid@rsccd.edu. See Instructions to Bidders.)

PROJECT N	NAME: Campus Entrance Improvements - Phase 1 at Santiago Canyon College						
PROJECT N	UMBER:	3739   BID NUMBER: 1434					
EMAIL TO	: facilitiesbid@	rsccd.edu					
DATE:	12/20/2022		T	I	-		
FROM:	Marina Landsca	ape	EMAIL:	Estimator@m	arinaco.com		
SPEC			DRAWING				
SECTION:			NUMBER:	L-5.01 / L-6.01			
REQUESTE	D CLARIFICAT	ΓΙΟΝ: Root Barrier					
located a r on sheet L	minimum of 15' for	on sheet L5.01 require root barri eet away from all vertical element that all trees planted with 8' feet of	. However, the	specs and plai	nting note 23		
RESPONSE	TO CLARIFICA	ATION:					
of 15' from Standards paving, etc	all vertical elem Root barriers a Both notes a address a bed as part of bid	placement of trees in relationship nents per the Rancho Santiago Co re required when trees are within are correct, but the root barrier not package.	ommunity Colle 8' of horizonta	ege District Fac Il hardscape ele	ility Design ements (sidewalks,		

Attach additional numbered sheets as necessary; however, only one (1) request shall be contained on each submitted form.

END OF DOCUMENT

(Email this completed form to FacilitiesBid@rsccd.edu. See Instructions to Bidders.)

PROJECT N	AME:	Campus Entrance Improvements	s - Phase 1 at S	Santiago Canyoi	n College			
PROJECT N	UMBER:	3739 BID NUMBER: 1434						
EMAIL TO: facilitiesbid@rsccd.edu								
DATE:	12/20/2022							
FROM:	Marina Landsca	аре	EMAIL:	Estimator@ma	arinaco.com			
CDEC			DD AUDIG					
SPEC SECTION:			DRAWING NUMBER:	L-5.01 / L-6.01				
REQUESTED CLARIFICATION: Mulch at Groundcover								
`								
		on sheet L-5.01 point out the multithe detail 2 and 3 on sheet L-6.0						
ground co	ver and 2" for sh	rubs. Please clarify.	i iliulcateu tiid	at the match dep	pui siiaii be 3 ioi			
		,						
RESPONSE	TO CLARIFICA	ATION:						
Note Con	L F O1 in normani	t All moules leure ve in planting and	a aball ba 4" is	aiminarraa Haiale sa	ar Danaha			
		t. All mulch layers in planting area ege District Facility Design Standa						
		tion details). District standards an						
		all be corrected for clarity and re-is						
B IM Dooi	an Croun							
RJM Desi 12/21/22	gii Gioup							
12,21,22								

Attach additional numbered sheets as necessary; however, only one (1) request shall be contained on each submitted form.

END OF DOCUMENT



## APPLICATION FOR SUBMITTAL OF POST-APPROVAL DOCUMENT

This application is for submittal of documents, after the initial approval of the project (post-approval documents), that require Division of the State Architect (DSA) review and approval. This form shall be completed by the Design Professional in General Responsible Charge of the project, in accordance with California Code of Regulations, Title 24, Part 1, Sections 4-317, 4-323 and 4-338 and in compliance with DSA IR A-6: Construction Change Document Submittal and Approval Process.

DSA documents referenced within this form are available on the DSA Forms or DSA Publications webpages.

\_\_Date\_\_\_\_\_ □Approved □Disapproved XNot Required

Date\_\_\_\_\_ □Approved □Disapproved ☒Not Required

1. SUBMITTAL TYPE:	(Is this a resubmittal? Yes ✓ No				
Deferred Submittal □	Addendum Number: 1	Revision Number:	CCD Nur	nber:	Category A or B
2. PROJECT INFORMA	ATION:				
School District/Owner:	RANCHO SANTIAGO COMMUNITY	COLLEGE DISTRICT		DSA File Numbe	er: 30 C2
Project Name/School: S	ANTIAGO CANYON COLLEGE CAN	IPUS ENTRANCE IMP	ROVEMENTS - PHASE	DSA Application	Number 04 121029
3. APPLICANT INFORM	MATION:				
Date Submitted: 12/02/2	22	Attached Pa	ges? No ☐ Yes ✔ Num	ber of pages? 3	0
Firm Name: SVA Archite	ects, Inc.	Contact Nan	ne: Robert Simons		
Work Email: BSimons@s	sva-architects.com	Work Phone	(949) 809-3380		
Firm Address: 6 Hutton	Centre Drive, Suite 1150	City: Santa	Ana	State: CA	Zip Code: 92707
4. REASON FOR SUBM	MITTAL: (Check applicable boxes)				
☑ For revision or addeno	dum prior to construction.		☐ For a	project currently ι	under construction.
☐ For a project that has a 90-Day Letter issued	a form <i>DSA 301-N: Notification of Re</i> I.	equirement for Certificat	ion, DSA 301-P: Posted	Notification of Re	equirement for Certification or
☐ To obtain DSA approv	val of an existing uncertified building	or buildings.			
☐ For Category B CCD to	his is: a voluntary submittal, a D	SA required submittal (	attach DSA notice requ	iring submission).	
5. DESIGN PROFESSION	ONAL IN GENERAL RESPONSIBLE	CHARGE:			
Name of the Design Prof	essional In General Responsible Cha	arge: Robert Simons			
Professional License Nur	mber: C-18301	Discipline:	Architecture		
	General Responsible Charge State appropriate requirements of Title 24, astruction of the project.  Research	California Code of Reg			
	DESIGN PROFESSIONAL II	N GENERAL RESPONSIBL	E CHARGE		
6. CONFIRMATION, DE	ESCRIPTION AND LISTING OF DO	CUMENTS:			
Design Professional liste Use of Construction Doc	or CCDs: CHECK THIS BOX verto co d on form DSA 1: Application for App uments Prepared by Other Profession able, for signature and seal requirem	proval of Plans and Spe nals, and IR A-19: Des	cifications for this project	ct. (For <i>Deferred</i> S	Submittals, refer to IR A-18:
Making updates to Divisio 'Allowances' items 1.04 (E	n of construction scope for this post- n 1 specifications only. The 'calenda B), 3.01 (A) and 3.01(B). A new form for Payment and (B) - Change Order	ar days' for construction (P) - 'Contractor Payme	in Section 01 12 16 havent Checklist' was added	ve been updated. d in section 01 32	29. Lastly, in section 01 32
List of DSA-approved dra	awings affected by this post-approval	document:			
Project Manual Specificat	ions Division 1 Section(s): 01 12 16 -	'Phasing of the Work',	01 21 00 - 'Allowances	', and 01 32 29 - '	'Project Forms'
		DSA USE ONL'	/		
		DOA USE UNL	Returned		DSA STAMP
SSS_LRDa	ate_ <u>12/06/2022</u> <b>X</b> Approved □Disapp	oroved □Not Required	Date:	Δ	PPROVED
Comments:			12/12/2022		E STATE ARCHITECT

Comments:

Comments:

12/06/2022

ACS |

APP: 04-121029 INC:

SS 🗹

DATE:

REVIEWED FOR

FLS

DP

#### **SECTION 01 12 16**

#### PHASING OF THE WORK

#### PART 1 – GENERAL

#### 1.01 SECTION INCLUDES

Requirements for phasing of the Work include logistics, phasing, and completion of designated phases prior to commencement of subsequent phases.

#### 1.02 RELATED SECTIONS

- A. Section 01 11 00: Summary of Work.
- Section 01 31 13: Project Coordination. B.
- C. Section 01 32 13: Construction Schedule.
- D. Section 01 33 00: Submittal Procedures.
- E. Section 01 50 00: Construction Facilities and Temporary Controls.
- F. Section 01 77 00: Contract Closeout.

#### 1.03 **SUBMITTALS**

A. Contractor shall submit a Project site logistics plan in accordance with and as required by this Section.

#### PART 2 – PRODUCTS (Not applicable)

#### PART 3 - EXECUTION

#### 3.01 LOGISTICS

- A. Prior to commencement of the Work, Contractor shall prepare and submit to the District Representative, a detailed Project site logistic plan, in the same size and scale of the Drawings, setting forth Contractor plan of the Work relative to the following, but not limited to, items:
  - 1. In accordance with local ordinances a truck access route to and from the Project site.
  - The identification of any overhead wire restrictions for power, street lighting, signal, and/or cable.
  - 3. Local sidewalk access and street closure requirements.
  - 4. Protection of sidewalk pedestrians and vehicular traffic.
  - 5. Project site fencing and access gate locations.
  - 6. Construction parking.
  - 7. Material staging and/or delivery areas.
  - Material storage areas.
  - Temporary trailer locations.
  - 10. Temporary service location and proposed routing of all temporary utilities.

- 11. Location of temporary and/or accessible fire protection
- 12. Trash removal and location of dumpsters.
- 13. Concrete pumping locations.
- 14. Crane locations.
- 15. Location of portable sanitary facilities.
- 16. Mixer truck wash out locations.
- 17. Traffic control signage.
- 18. Perimeter and site lighting.
- 19. Stockpile and/or lay down areas.
- 20. Emergency Vehicle Access Routes.
- B. A revised Project site logistic plan may be required by the District Representative for separately identified phases of the Work as set forth in this Section.
- C. Contractor is responsible for securing and obtaining all approvals and permits from authorities having jurisdiction relative to logistic plan activities.

#### 3.03 PHASING OF THE WORK

- A. Project will be constructed in separate Milestone increments, as identified, or as described in this Section and/or the Contract Documents. Phasing will also delineate Work to be completed in each designated phase. Unless otherwise approved or directed by the District Representative, each phase shall be completed according to the approved Construction Schedule prior to the commencement of the next subsequent phase. Contractor shall incorporate and coordinate the Work of Separate Work Contracts relative to this Project into the Phasing and Construction Schedule.
- B. Contractor shall install all necessary Work for phased Work before completion of the designated phase.

#### 3.04 PHASING OF THE WORK – GENERAL

- A. Contractor shall prepare the Milestone Schedule in order to complete the Work and related activities in accordance with the phasing plan. Contractor shall include all costs to complete all Work within the Milestones and Contract Time.
- B. Owner will be seriously damaged by not having all Work completed within the Milestones and/or Contract Time. It is mandatory the Work be complete within the Milestones and Contract Time.

#### 3.05 PHASING OF THE WORK – SPECIFIC

A. Contractor shall prepare the Construction Schedule, and shall complete the following Milestones, but not limited to, within the designated phases in accordance with the following:

- 1. Submittal 35 calendar days from NTP.
- 2. Mobilization 10 calendar days from NTP.
- 3. Substantial Completion (Construction Phase 1) 155 calendar days from NTP.
- 4. Substantial Completion (Construction Phase 2) 296 calendar days from NTP.
- 5. The Final Completion Date 323 calendar days from NTP.
- 6. Punch List Correction 30 calendar days.

### RANCHO SANTIAGO COMMUNITY COLLEGE DISTRICT SANTIAGO CANYON COLLEGE – CAMPUS ENTRANCE IMPROVEMENTS – PHASE 1

B.	Owner will be seriously damaged by not having all Work completed within the Milestones and/or
	Contract Time. It is mandatory the Work be complete within the Milestones and Contract Time.

END OF SECTION 01 12 16

#### **SECTION 01 21 00**

#### **ALLOWANCES**

#### PART 1 – GENERAL

#### 1.01 SECTION INCLUDES

- A. This Section specifies administrative and procedural requirements governing Contract allowances.
  - 1. Allowances as set forth in the Specifications are to be used as compensation for items as set forth in this Section. The amounts listed in the schedule or Specifications are to be included in the base bid and shall be listed separately in the Schedule of Values and Application for Payment.

#### 1.02 RELATED SECTIONS

- A. Section 01 29 73: Schedule of Values Procedures.
- B. Section 01 29 76: Progress Payment Procedures.
- C. Section 01 32 13: Construction Schedule.
- D. Section 01 50 00: Construction Facilities and Temporary Controls.

#### 1.03 ALLOWANCES

- A. Use the allowances only as authorized for Owner purposes and only by submitting a form that indicates the amounts to be charged to the respective allowance amount to the District Representative.
- B. District Representative and Architect will review Contractor's basis for its use of any Allowance costs included in Contract Sum as required, and prior to the execution of Work described in Allowances.
- C. At Substantial Completion of the Work or at any time designated by the District Representative, credit unused amounts remaining in the allowances to the Owner via Change Order.

#### 1.04 ALLOWANCE DISBURSEMENT

- A. Contractor shall submit a request for allowance disbursement to the District Representative.

  Include all substantiating and/or required data along with the request.
- B. The request shall have the requested amount listed as an allowance disbursement. The allowance expenditure shall include overhead and mark-ups in the same amount and the same format as identified in Section 17.1, Work Modifications, under the Procurement and Contract Provisions (Part 2).

PART 2 – PRODUCTS (Not Applicable)

#### PART 3 - EXECUTION

#### 3.01 SCHEDULE OF ALLOWANCES

A. Include in the base bid the following allowances in the following amounts:

To Be Determined.

Description of Allowance: The allowance shall be used solely for the District to address unforeseen repairs or improvements related to electrical, structural, water, sewer, storm drain or other unforeseen, hidden, or unanticipated site conditions, and necessary for completing work, but are unknown at the time of bid. The allowances will be added to the final contract amount for award once the District determines the lowest, responsive bidder.

END OF SECTION 01 21 00

#### SECTION 01 32 29

#### PROJECT FORMS

#### PART 1 – GENERAL

#### 1.01 SECTION INCLUDES

- A. The following, but not limited to, District administrative forms and documents listed in this Section to be utilized in the administration of the Work.
- B. Electronic versions of these forms are available if requested from the District Representative.
- C. From time to time, Owner may release new revisions and new Project Forms. At any time during the Project, if requested by District Representative, Contractor shall use the newly released Project Form(s).

#### 1.02 RELATED DOCUMENTS

- A. Procurement and Contract Provisions (PARTS 1 and 2).
- B. Division 01.

#### PART 2 – PRODUCTS (Not applicable)

#### PART 3 – EXECUTION

- 3.01 FORMS: Contractor to utilize the following District standard forms (refer to Appendix A for a copy of the forms listed below)
  - A. Application for Payment / Schedule of Values
  - B. Change Order
  - C. Conditional Waiver and Release Final Payment
  - D. Conditional Waiver and Release Progress Payment
  - E. Immediate Change Directive
  - F. Unconditional Waiver and Release Final Payment
  - G. Unconditional Waiver and Release Progress Payment
  - H. Construction Waste Management Plan
  - I. Construction Waste Management Progress Report
  - J. Request for Export Material Testing
  - K. Request for Import Material Testing
  - L. Certificate of Substantial Completion
  - M. Warranty Guarantee Form
  - N. Allowance Disbursement Form
  - O. Substitution Request Form (Post Award)
    P. Contractor Payment Checklist

#### 3.02.1 PROCEDURES

- A. <u>Application for Payment/Schedule of Values</u>: This form is used in requesting a progress payment and to establish the basis of the certified application for payment.
- B. <u>Change Order</u>: This form is used to adjust the Contract Amount, Milestones and/or the Contract Time.
- C. <u>Conditional Waiver and Release</u>: Use this form when the claimant is required to execute a waiver and release in exchange for or in order to induce the payment of a progress payment and the claimant has not been paid.
- D. <u>Immediate Change Directive</u>: This form is used to issue an Immediate Change Directive.
- E. <u>Unconditional Waiver and Release</u>: Use this form when the claimant is required to execute a waiver and release in exchange for or in order to induce payment of a progress payment and the claimant asserts in the waiver that he or she has in fact been paid the progress payment.
- F. Request for Export Material Testing: This form is to be completed and provided to District Representative in accordance with Specification 01 45 24.
- G. <u>Construction Waste Management Plan</u>: This form is used to provide a Waste Management Plan, submitted in accordance with Specification Section 01 74 19 and prior to any waste removal.
- H. <u>Construction Waste Management Progress Report</u>: This form is used to provide a Waste Management Monthly Progress Report, summarizing waste generated by Project and submitted monthly with Application for Payment.
- I. <u>Core Employee List</u>: This form is to be completed by All Prime Contractors/Consultants, Subcontractor/Sub-consultants intending to employ core workers. Complete this list and then forward to the District's Labor Compliance Consultant.
- J. <u>Monthly Employee Utilization Form</u>: This form is to be completed monthly and then to be forwarded to the District's Labor Compliance Consultant.
- K. <u>Modified Certified Payroll Form</u>: This form is to be completed monthly and then to be forwarded to the District's Labor Compliance Consultant in addition to the electronic Certified Payroll.
- L. <u>Checklist of Labor Law Requirements</u>: This is to be completed by all Contractors, acknowledging and understanding the Federal and State Labor Law.
- M. <u>Request for Import Material Testing</u>: This form is the be completed and provided to District Representative in accordance with Specification Section 01 45 24.
- N. <u>Certificate of Substantial Completion</u>: This form is to be completed and signed by all parties once project has been determined to be substantially complete.
- O. <u>Warranty Guarantee Form</u>: This form shall be filled out and signed by Contractor and Subcontractors prior to completion of closeout activities.
- P. <u>Construction Contingency Work Authorization</u>: This form shall be filled out and signed by Contractor then issued to District Representative for review and approval.
- Q. <u>Substitution Request Form</u>: This form shall be provided for any substitution requests after award as further described in Specification Sections 01 60 00, 01 62 11, and the Procurement and Contract Provisions (General Conditions).
- R. Contractor Payment Checklist: This form shall be completed and signed by the Contractor as part of progress payments, Substantial Completion and/or Final Payment procedure.

END OF SECTION 01 32 29

## 01 32 29 - PROJECT FORMS

## **APPENDIX A**

# RANCHO SANTIAGO Community College District

## **Rancho Santiago Community College District**

2323 North Broadway Santa Ana, CA 92706

1. Original contract amount 2. Change made from Approved Change Order 3. Adjusted contract amount to date  B. COMPUTATION OF PAYMENT DUE  1. Work completed to date on original contract 2. Change Order work performed to date 3. Total work performed to date 4. Less: 5% retained 5. Net amount earned to date 6. Amount to be withheld because of: 7. Balance 8. Less: Amount of previous payments 9. Amount due this payment 10. Unpaid balance on RSCCD amount of cont  C. CERTIFICATION OF CONTRACTOR OR HIS DULY A  To the best of my knowledge and belief, I certify that all items and prices been performed and materials supplied in full accordance with the terms indicated contract, and all change orders approved by the Board of Trus	\$  (B1 + B2 + B3)   (B1 + B.2)  (B.3 x 5%)  (B.3 - B.4)  \$  (B.5 - B.6)  (B.9 from previous application)  (B.7 - B.8)  \$  \$  tract  \$ \$ \$ \$ \$ \$ \$ \$ \$ \$ \$ \$ \$ \$ \$ \$ \$ \$	- - - - - - - - -
Contractor: Address: Phone:  A. ANALYSIS OF ADJUSTED CONTRACT AMOUNT TO  1. Original contract amount 2. Change made from Approved Change Order 3. Adjusted contract amount to date  B. COMPUTATION OF PAYMENT DUE  1. Work completed to date on original contract 2. Change Order work performed to date 3. Total work performed to date 4. Less: 5% retained 5. Net amount earned to date 6. Amount to be withheld because of: 7. Balance 8. Less: Amount of previous payments 9. Amount due this payment 10. Unpaid balance on RSCCD amount of cont  C. CERTIFICATION OF CONTRACTOR OR HIS DULY A  To the best of my knowledge and belief, I certify that all items and prices been performed and materials supplied in full accordance with the terms indicated contract, and all change orders approved by the Board of Trus	Project Name P.O. No.  State of the state of	- - - - - - - - - -
A. ANALYSIS OF ADJUSTED CONTRACT AMOUNT TO  1. Original contract amount 2. Change made from Approved Change Order 3. Adjusted contract amount to date  B. COMPUTATION OF PAYMENT DUE  1. Work completed to date on original contract 2. Change Order work performed to date 3. Total work performed to date 4. Less: 5% retained 5. Net amount earned to date 6. Amount to be withheld because of: 7. Balance 8. Less: Amount of previous payments 9. Amount due this payment 10. Unpaid balance on RSCCD amount of cont  C. CERTIFICATION OF CONTRACTOR OR HIS DULY A  To the best of my knowledge and belief, I certify that all items and prices been performed and materials supplied in full accordance with the terms indicated contract, and all change orders approved by the Board of Trus	P.O. No	- - - - - - - - - -
A. ANALYSIS OF ADJUSTED CONTRACT AMOUNT TO  1. Original contract amount 2. Change made from Approved Change Orde 3. Adjusted contract amount to date  B. COMPUTATION OF PAYMENT DUE  1. Work completed to date on original contract 2. Change Order work performed to date 3. Total work performed to date 4. Less: 5% retained 5. Net amount earned to date 6. Amount to be withheld because of: 7. Balance 8. Less: Amount of previous payments 9. Amount due this payment 10. Unpaid balance on RSCCD amount of cont  C. CERTIFICATION OF CONTRACTOR OR HIS DULY A  To the best of my knowledge and belief, I certify that all items and prices been performed and materials supplied in full accordance with the terms indicated contract, and all change orders approved by the Board of Trus	\$  (B1 + B2 + B3)   (B1 + B.2)  (B.3 x 5%)  (B.3 - B.4)  \$  (B.5 - B.6)  (B.9 from previous application)  (B.7 - B.8)  \$  \$  tract  \$ \$ \$ \$ \$ \$ \$ \$ \$ \$ \$ \$ \$ \$ \$ \$ \$ \$	- - - - - - - - -
A. ANALYSIS OF ADJUSTED CONTRACT AMOUNT TO  1. Original contract amount 2. Change made from Approved Change Order 3. Adjusted contract amount to date  B. COMPUTATION OF PAYMENT DUE  1. Work completed to date on original contract 2. Change Order work performed to date 3. Total work performed to date 4. Less: 5% retained 5. Net amount earned to date 6. Amount to be withheld because of: 7. Balance 8. Less: Amount of previous payments 9. Amount due this payment 10. Unpaid balance on RSCCD amount of cont  C. CERTIFICATION OF CONTRACTOR OR HIS DULY A  To the best of my knowledge and belief, I certify that all items and prices been performed and materials supplied in full accordance with the terms indicated contract, and all change orders approved by the Board of Trus	\$  (B1 + B2 + B3)   (B1 + B.2)  (B.3 x 5%)  (B.3 - B.4)  \$  (B.5 - B.6)  (B.9 from previous application)  (B.7 - B.8)  \$  \$  tract  \$ \$ \$ \$ \$ \$ \$ \$ \$ \$ \$ \$ \$ \$ \$ \$ \$ \$	- - - - - - - - -
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I further certify that this payment will be used to pay all just and lawful bil the performance of the indicated contract.  Contractor Signature  Print Name:	stees; that this is a true and correct statement of the contract acc part of the amount "Amount Due This Payment" has been receive	count up to and ed.
Project Inspector Signature Date	RSCCD Director Facilities Planning Signature	Date
Print Name:	Print Name: Joe Melendez	
Architect Signature Date	RSCCD Asst. Vice Chancellor Signature	Date
Print Name:	Print Name: Carri M. Matsumoto	
Construction Mngr Signature Date	RSCCD Vice Chancellor Signature	Date
Print Name:	Print Name: Iris I. Ingram 入人	
Time reality.		
D. CERTIFICATE OF PAYMENT	- ADD	
D. CERTIFICATE OF PAYMENT	0	
D. CERTIFICATE OF PAYMENT This is to certify that		

Updated: 11/07/19

## **CONTINUATION SHEET**

APPLICATION AND CERTIFICATION FOR PAYMENT, containing Contractor's signing Certification, is attached. In tabulation below, amounts are stated to the nearest dollar. Use Column 1 and Contract where variable ratainage for line items may apply

 Application No.:
 0

 Application Date:
 1/0/1900

 Period To:
 1/0/1900

Α	В		С		D	E	F	G		Н	I
					WORK CO	MPLETED		TOTAL			
ITEM NO.	DESCRIPTION OF WORK	ORIGINAL CONTRACT AMOUNT	CHANGE ORDER AMOUNT	CURRENT CONTRACT AMOUNT	FROM PREVIOUS APPLICATIONS (D + E)	THIS PERIOD	MATERIALS PRESENTLY STORED (NOT IN D OR E)	COMPLETED AND STORED TO DATE (D+E+F)	% (G ÷C)	BALANCE TO FINISH (C-G)	RETAINAGE (IF VARIABLE RATE)
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# RANCHO SANTIAGO Community College District

## **Rancho Santiago Community College District**

2323 North Broadway Santa Ana, CA 92706

## **Change Order Tracker**

PAYMENT NO. 0

For the period Contractor Address Phone	1/0/1900	to 1/0/1900 0 0 0 0	DSA # Project Name P.O. No.	Campus Entra	0 nce Improveme 0	nts - Phase 1
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Previous Period Total	\$ -
This Period Total	\$ -

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Notice to

# Facility Planning, District Construction & Support Services 2323 North Broadway, Rm 112 Santa Ana, CA 92706

Community College	a District	Board Bate.			
Project Name:	Campus Entrance Improvements - Phase 1	Project/Bid No.	0		
Contractor:	0	Site:	0		
Contract No.:	0	Change Order (CO) N	o.: 0		

Previous

Extension

Proposed CO

New Revised

Proceed Date	Original Contract Duration (Days)	Completion Date	Extension Days Approved	Days Requested	Completion Date
01/00/00	0	01/00/00	0	0	1/0/1900
	Chang	e Order Summa	ry		
	Description		Number	Amount	% of Contract
Original Contract Amount				\$0.00	
Previous Change Orders			0	\$0.00	#DIV/0!
This Change Order			0	\$0.00	#DIV/0!
Total Change Order (s)				\$0.00	#DIV/0!
Revised Contract	Amount			\$0.00	

Contract Schedule Summary Original

Original Contract Duration (Days)

Contract

Items in Change Order						
Item No.	Description	Reason	Ext. Day	Credit	Add	Net
1	0	0	0	\$0.00	\$0.00	\$0.00
		Subtotal		\$0.00	\$0.00	\$0.00
		Grand Total				\$0.00

- 1 CODE REQUIREMENT 2 FIELD CONDITION 3 INSPECTION REQUIREMENT 4 DESIGN REQUIREMENT
- 5 OWNER REQUIREMENT



#### Facility Planning, District Construction & Support Services 2323 North Broadway, Rm 112 Santa Ana, CA 92706

RANCHO SANTIA Community College Di		Board Date:
Project Name:	Campus Entrance Improvements - Phase 1	Project/Bid No.
Contractor:		Site:
Contract No.:		Change Order (CO) No. :
	Contract Schedule Summary	
	Original Provious	

Notice to Proceed Date	Original Contract Duration (Days)	Contract Completion Date	Extension Days Approved	Days Requested	New Revised Completion Date
Change Order Summary					
Description		Number	Amount	% of Contact	

Description	Number	Amount	% of Contact
Original Contract Amount		\$0.00	
Previous Change Orders		\$0.00	#DIV/0!
This Change Order		\$0.00	#DIV/0!
Total Change Order (s)		\$0.00	#DIV/0!
Revised Contract Amount		\$0.00	

Items in Change Order							
Item No.	Description	Reason	Ext. Day	Credit	Add	Net	
				\$ -	\$ -	\$ -	-
-	_	Subtotal		\$ -	\$ -	\$ -	• _
		Grand Total				\$ -	•

- 1 CODE REQUIREMENT
- 2 FIELD CONDITION
- 3 INSPECTION REQUIREMENT
- 4 DESIGN REQUIREMENT
- 5 OWNER REQUIREMENT

The Contractor is to provide a complete description and specification of work involved and reason. The documents supporting this Change Order, including any drawings and estimates of that cost are attached hereto and made a part thereof.

Contractor agrees to furnish all labor and materials and perform all of the above described work in accordance with the above terms in compliance with applicable sections of the Contract Documents. The amount of the charges under this Change Order is limited to the charges allowed under the General Conditions. The adjustment in the contract sum, if any, and the adjustment in the contract time, if any, set out in this Change Order shall constitute the entire compensation and/or adjustment in the contract time and contract sum due to the Contractor arising out of the change in the work covered by this Change Order, unless otherwise provided in this Change Order. It is understood that this Change Order shall be effective upon approval

Contractor	Date	RSCCD Project Manager	Date
		Joe Melendez	
Architect	Date	RSCCD Director	Date
Inspector	Date	Carri M. Matsumoto	
		RSCCD Assistant Vice Chancellor	Date
	,	Iris ingram	
	Z A	RSCCD Vice Chancellor	Date



Project Name:	Campus Entrance Improvements - Phase 1				
Project No.:	DSA Application No.				

## **Conditional Waiver and Release Upon Final Payment**

## **CALIFORNIA CIVIL CODE SECTION 8136**

NOTICE: THIS DOCUMENT WAIVES THE C NOTICE, AND PAYMENT BOND RIGHTS EFFEC	·
PERSON SHOULD NOT RELY ON THIS DOCUM	
CLAIMANT HAS RECEIVED PAYMENT.	
<b>Identifying Information</b>	
Name of Claimant:	
Name of Customer:	
Job Location:	
Owner: RANCHO SANTIAGO COMMUNITY COLI	LEGE DISTRICT
This document waives and releases lien, stop paymer claimant has for labor and service provided, and excustomer on this job. Rights based upon labor or set delivered, pursuant to a written change order that has the date that this document is signed by the claimant, unless listed as an Exception below. This document is payment from the financial institution on which the following	equipment and material delivered, to the ervice provided, or equipment or material been fully executed by the parties prior to are waived and released by this document, a effective only on the claimant's receipt of
Maker of Check:	
Amount of Check:	
Check Payable To:	
Exceptions  This document does not affect any of the following:   \$	Disputed claims for extras in the amount of
Date:	(Company Name)
BY:	(Signature)
	· · · /
	(Title)



Project Name:	Campus Entrance Improvements - Phase 1			
Project No.:	DSA Application No.			

## **Conditional Waiver and Release Upon Progress Payment**

## **CALIFORNIA CIVIL CODE SECTION 8132**

PAYMENT BOND RIGHTS EFFECTIVE O	ON REC	CLAIMANT'S LIEN, STOP PAYMENT NOTICE, AND EIPT OF PAYMENT. A PERSON SHOULD NOT RELY ON HE CLAIMANT HAS RECEIVED PAYMENT.
Identifying Information	111/11 1	THE CERTIFICATION RECEIVED TRAINING.
Name of Claimant:		
Job Location:		
Owner: RANCHO SANTIAGO COMMUNI	TY COI	LLEGE DISTRICT
Through Date:		
and service provided, and equipment and m of this document. Rights based upon labor written change order that has been fully execlaimant, are waived and released by this do	aterial d or servi cuted by cument,	ent notice, and payment bond rights the claimant has for labor elivered, to the customer on this job through the Through Date ce provided, or equipment or material delivered, pursuant to a the parties prior to the date that this document is signed by the unless listed as an Exception below. This document is effective nancial institution on which the following check is drawn:
Maker of Check:		
Amount of Check:		
Check Payable To:		
Exceptions		
payment; (3) The following progress payment and release but has not received payment Amount(s) of unpaid progress payment(s):	nts for w t: Date(	(1) Retentions; (2) Extras for which claimant has not received which the claimant has previously provided a conditional waiver s) of waiver and release:
Date:		
		(Company Name)
	BY:	(Signature)
		(Title)



Facility Planning, District Construction & Support Services 2323 North Broadway, Suite 112 Santa Ana, CA 92706-1640

			Tilline diate	mange Directive (IC	עע)
	Date:		_		
	Project Name:	Campus Entrance Improvements - Phase 1	_	ICD No.:	
	Project No.:		_ Us	e of Allowance Dollars?	<yes no="" or=""></yes>
	Architect:		_	Reference RFI No.:	
(	Contractor:			Reference COR No.:	
			Initiated By		
				☐ Architect	
				☐ Contractor☐ Other:	
WOD	N. DEOLUBED				
WOR	RK REQUIRED:				
REAS	SON FOR CHAI	NGE DIRECTIVE:			
STA	TUS OF WORK	CONSTRUCTION ACTIVITIES AFFECTED:			
		UTHORIZED TO PROCEED WITH THE WORK	PURSUANT TO	THE CONSTRUCTION SE	ERVICES
		E FOLLOWING MANNER:		1100 ID D 1 1	
		(T&M), Not-to-Exceed	_ Ac	dditional Days Required:	
(	Complete work withi	n dollar limit stated, submit daily time tickets		Days beyond Approved Co	ontract Completion Date
	Lump Sum		<u>_</u>		
(	Complete work for al	pove indicated agreed upon lump sum	Schedule	Activity Nos. Affected:	
	Directed to Procee	ed, Submit Pricing	<u></u>		
I	Proceed with work in	nmediately. Pricing shall be submitted per the Agreement	_		
		mmediate Change Directive is a written order to the Contractor prepar change in the Work and stating a proposed basis for adjustment, if a			
invalida	ating the Contract, direct	et immediate changes in the Work within the general scope of the C	Contract consisting of ac	lditions, deletions, or other revisions	s within. If applicable, the
		ne will be adjusted accordingly. CONTRACTOR SHALL PROCEE R HOLD THE CONTRACTOR IN EITHER PARTIAL DEFAULT PU			
	CONTRACTOR		DISTRICT:	Rancho Santiago Comm District	lumity Conege
			_	DISHICL	
	Approved By:		_Approved By:	-	
]	Date:		_Date:		
(	CM:		ARCHITECT:		
	Approved By:		Approved By:		
1	Date:		Date:		



Project Name:	Campus Entrance Improvements - Phase 1			
Project No.:	DSA Application No.			

# **Unconditional Waiver and Release Upon Final Payment**

## **CALIFORNIA CIVIL CODE SECTION 8138**

NOTICE TO CLAIMANT: THIS DOCUMENT WAIVES AND RELEASES LIEN, PAYMENT NOTICE, AND PAYMENT BOND RIGHTS UNCONDITIONALLY STATES THAT YOU HAVE BEEN PAID FOR GIVING UP THOSE RIGHTS. DOCUMENT IS ENFORCEABLE AGAINST YOU IF YOU SIGN IT, EVEN IF YOU NOT BEEN PAID. IF YOU HAVE NOT BEEN PAID, USE A CONDITIONAL WAAND RELEASE FORM.	AND THIS HAVE
Identifying Information	
Name of Claimant:	
Name of Customer:	
Job Location:	
Owner: RANCHO SANTIAGO COMMUNITY COLLEGE DISTRICT	
This document waives and releases lien, stop payment notice, and payment bond right claimant has for all labor and service provided, and equipment and material delivered, customer on this job. Rights based upon labor or service provided, or equipment or m delivered, pursuant to a written change order that has been fully executed by the parties p the date that this document is signed by the claimant, are waived and released by this documents listed as an Exception below. The claimant has been paid in full.  Exceptions	to the aterial rior to
This document does not affect any of the following: Disputed claims for extras in the amos	unt of
Date: (Company Name)	
BY: (Signature)	
(Title)	



Project Name:	Campus Entrance Improvements - Phase 1			
Project No.:	DSA Application No.			

## Unconditional Waiver and Release Upon Progress Payment CALIFORNIA CIVIL CODE SECTION 8134

NOTICE TO CLAIMANT: THIS DOCUMENT WAIVES AND RELEASES LIEN, STOP PAYMENT NOTICE, AND PAYMENT BOND RIGHTS UNCONDITIONALLY AND STATES THAT YOU HAVE BEEN PAID FOR GIVING UP THOSE RIGHTS. THIS DOCUMENT IS ENFORCEABLE AGAINST YOU IF YOU SIGN IT, EVEN IF YOU HAVE NOT BEEN PAID. IF YOU HAVE NOT BEEN PAID, USE A CONDITIONAL WAIVER AND RELEASE FORM.
Identifying Information
Name of Claimant:
Name of Customer:
Job Location:
Owner: RANCHO SANTIAGO COMMUNITY COLLEGE DISTRICT
Through Date:
This document waives and releases lien, stop payment notice, and payment bond rights the claimant has for labor and service provided, and equipment and material delivered, to the customer on this job through the Through Date of this document. Rights based upon labor or service provided, or equipment or material delivered, pursuant to a written change order that has been fully executed by the parties prior to the date that this document is signed by the claimant are waived and released by this document, unless listed as an Exception below. The claimant has received the following progress payment: \$
<b>Exceptions</b>
This document does not affect any of the following: (1) Retentions; (2) Extras for which claimant has not received payment; (3) Contract rights including: (A) a right based on rescission abandonment, or breach of contract, and (B) the right to recover compensation for work not compensated by the payment.
Date:
(Company Name)
BY: (Signature)
(Title)



### **Instructions regarding Form:**

- 1. General:
  - a. Attach proposed Recycling and Waste Bin Location Plan.
  - b. Attach name and contact data for each recycling or disposal destination to be used.
- 2. Column 1: "Material Types" Enter types of materials targeted for recycling, reuse, and/or salvage, either on or off-site, and include a category for waste materials requiring disposal.
- 3. Columns 2 4: "Estimated Generation" Enter estimated quantities (tons) of recyclable, reusable, or salvageable waste materials anticipated to be generated and state number of salvageable items.
- 4. Column 5: "Estimated Landfill" Enter quantities (tons) of materials to be disposed in landfill.
- 5. Column 6: "Disposal Location" Enter end-destination of recycled, salvaged, and disposed materials.

(DELETE TEXT BOX BEFORE PROVIDING TO DISTRICT REPRESENTATIVE)

#### CONSTRUCTION WASTE MANAGEMENT PLAN

PROJECT NAME: Campus Entrance Improvements - Phase 1						
PROJECT SITE ADDI	RESS:				_	
PROJECT NO:	_				_	
NAME OF COMPAN	Y:					
CONTACT PERSON:	_					
TELEPHONE:						
PROJECT TYPE:	<u></u>		ONSTRUCTION ATION / ALTE		DEMOLITION DJECTS	
PROJECT SIZE (SQ. I	FT.):				_	
DATE & ESTIMATEI	O PERIOD:					
(1)	(a)			(F)	(0)	
(1) Material Type	(2) Tons Estimated Recycle	(3) Tons Estimated Reuse	(4) Tons Estimated Salvage	(5) Tons Estimated Landfill	(6) Proposed Disposal or Recycling Facility (e.g., Onsite, Name of Facility)	
Total						
Diversion Rate: Columns [(2)+(3)+(4)] / [(2)+(3)+(4)+(5)] =						
Signature		Title		Date		



#### <u>Instructions regarding Form:</u>

- 1. General:
  - a. Attach proposed Recycling and Waste Bin Location Plan.
  - b. Attach name and contact data for each recycling or disposal destination to be used.
- 2. Column 1: "Material Types" Enter types of materials targeted for recycling, reuse, and/or salvage, either on or off-site, and include a category for waste materials requiring disposal.
- 3. Columns 2 4: "Estimated Generation" Enter estimated quantities (tons) of recyclable, reusable, or salvageable waste materials anticipated to be generated and state number of salvageable items.
- 4. Column 5: "Estimated Landfill" Enter quantities (tons) of materials to be disposed in landfill.
- 5. Column 6: "Disposal Location" Enter end-destination of recycled, salvaged, and disposed materials.

(DELETE TEXT BOX BEFORE PROVIDING TO DISTRICT REPRESENTATIVE)

#### CONSTRUCTION WASTE MANAGEMENT PROGRESS REPORT

PROJECT NAME: Campu		pus Entrance Imp	rovements - Ph	ase 1	
PROJECT SITE ADD	RESS:				
PROJECT NO:	·				
NAME OF COMPAN	Y:				
CONTACT PERSON:					
TELEPHONE:					
PROJECT TYPE:			STRUCTION ION / ALTERA		DEMOLITION JECTS
PROJECT SIZE (SQ. 1	FT.):				
PERIOD:					
	T	T	1	T	
(1) Material Type	(2) Tons Actual Recycle	(3) Tons Actual Reuse	(4) Tons Actual Salvage	(5) Tons Actual Landfil	
Total					
Diversion Rate: Colu	umns [(2)+(3)+	-(4)] / [(2)+(3)+(	(4)+(5)]		=
Signature		Title		Da	ite



#### Rancho Santiago Community College District

## **REQUEST FOR INFORMATION (RFI)**

School Name:	Santiago Canyon College	RFI Number:	
Project Name:	Campus Entrance Improvements - Phas	se 1 Date:	
Contractor:		Project No.:	
Date Issued To: (Architect)		DSA No.:	
(Architect)			
Drawing Number	Detail Drawing Page	Specification	
Information F	Requested:		
Suggested Co	ourse of Action:	Cost Impact: ☐ Yes ☐ No	
Request Issued I	by:		
	Contractor's Signature	Name (Printed)	Date
Response:			
Response Issued	d by:		
	Signature	Name (Printed)	Date
Response Review	wed by:		
	Architect's Signature	Name (Printed)	Date

Proceeding with the Work in accordance with the above information indicates the Contractor's acknowledgement that there will be no change in the Contract Sum or Contract Time. If the Contractor considers that a change in Contract Sum or Contract Time is required, before proceeding with the work obtain authorization from the Owner by notifying the Owner and the Architect within five (5) working days and submit an itemized proposal within ten (10) days.



## REQUEST FOR IMPORT MATERIALS TESTING FORM

112 4	T TOTAL TOTAL	WHITEIGHES TESTING FORM			
Date:					
Project Name:	Campus Entrance Improve	ments - Phase 1			
RSCCD Project No.:					
Contractor:					
School Site Receiving					
Import (Name and					
Address):					
I	6.4 -				
Location of Soil Borrow	Site:				
Borrow Site Address:					
Borrow Site City:					
Major Cross Streets:					
Soil Owner Information	<u>:</u>				
Soil Owner Name:					
Contact Name:					
Contact Phone Number:					
Site History:					
Describe Current Site Use	2:				
Describe Site History:					
Available Environmental					
Documents:					
<b>Borrow Soil Description</b>					
Material Type:	Fill Soil				
Wateriar Type.	Other:				
Import Soil Volume:	(To	onnage)			
If in place material, depth		0 /			
and acres of excavation:					
Only portion of mate	erial is available	☐ Stockpile			
or		or			
All required material is available					
Materials already on					
Import Site?					
Schedule:					
Date and time when results are needed:					
Date formal report is need	Date formal report is needed:				
	l				
Comments:					

Note: Requests for testing at District pre-tested sites must be received four (4) weeks in advance of material being needed on site. Requests for non-pre-tested sites must be received eight (8) weeks in advance of material being needed on site.

## **CERTIFICATE OF SUBSTANTIAL COMPLETION**

DATE:

SITE:		CONTRACT #:	
PROJECT NAME: Campus Er	ntrance Improvements - Phase 1	PROJECT ID#:	DSA#:
CONTRACTOR:		CONTRACT DATI	E:
		all work under the Contract Docu the following specific parts of the	
information and belief, to be		efined in the Contract. The Substa	ne signatory's (below) best knowledg Intial Completion Date of the Project
☐ The completion of t	the Punch List for Final Completion	on is attached hereto	
reach Final Completion of al	l work in accordance with the Co	em on such list does not alter the r ntract Documents. Such work sha d in the Contract for Punch List wo	II be completed or corrected to the
	stitute an acceptance of Work no plete the Work in accordance wi		Documents nor is it a release of the
Contractor	Date	RSCCD Project Manager	Date
Inspector	Date	RSCCD Director	Date
Architect	Date		

## **WARRANTY GUARANTEE FORM**

(To issue to the Contractor by the District)

Project Name: <u>Santiago Canyon College – Campus Entrance I</u> Project ID:	<u>Improvements - Phase 1</u>
The following is a warranty and guarantee by the undersigned for the work which has been completed/installed at 8045 E. Chapman Avenue, Orange, CA 92869, will provide a new drop-off/pick-up area, modifying the existing access drive and a new round-about median. The exterior improvements will involve modifying existing walkways, hardscape, landscape, driving aisles and parking.  Capitalized terms not defined herein shall have the meanings assigned to them in the Contract Documents applicable to the Warranted Work at the time it was furnished and installed at the Project.	
SYSTEM OR ITEM	WARRANTY DURATION (YEARS)
In the event of the Warranted Work is found not in compliance with the terms of this warranty, then the District shall have the right, after expiration of a reasonable period of time (not later than seven (7) calendar days) following mailing by regular mail of notification by the District to the undersigned as its last known or reputed address, to proceed to have the Warranted Work repair, replace or otherwise made good, to whatever extent necessary, to make the Warranted Work comply with its terms of this warranty.  Warranties shall provide by written endorsement that if warranted Work fails and is replaced, removed or substantially rebuilt, that the original warranty on such Work shall be renewed, whereas the full warranty periods starts over again, commencing from when	
Work covered by warranty was corrected.	
The responsibility of the undersigned under this warranty includes, without limitation, replacement, removal and repair not only of the Warranted Work, but also of related or adjoining portions of work, equipment, materials or property as necessary to provide access for correction of the Warranted Work, as well as any other loss or damage (including, without limitation, economic loss) resulting directly or indirectly to District from the failure of the Warranted Work to comply with the terms of this warranty. All costs, expenses, damages and other losses to District due to the failure of the Warranted Work to comply with the terms of this warranty shall be deemed to be expenses of undersigned and shall be paid by the undersigned to the District upon demand.	
Print-Subcontractor or Supplier (Company Name)	Signature of Subcontractor or Supplier Date
Print-General Contractor (Company Name)	Signature of General Contractor Date
Representative(s) to be contacted for service:	
First and Last Name of Representative:	
Mailing Address:	
Email Address:	Contact Number:



### **Rancho Santiago Community College District**

### CONTRACTOR ALLOWANCE DISBURSEMENT AUTHORIZATION

College Name:	Santiago Canyon College	Initiatio	on Date:
Project Name:	Campus Entrance Improvements - Phas	e 1 Allowance Disburseme	ent No.:
To: (District)		Project	Bid No:
From: (Contractor)		Contract / PO N	Number:
Description of	Item to be charged to District Al	lowance:	Amount
			7 0
		Contractor Allowance Request	Total: \$0.00
			·
A. Original Con	tractor Allowance Amount:		\$0.00
	ce Disbursements previously author	•	
C. Charges to C	Contractor Allowance as a result of	this authorization:	\$0.00
D. Current Con	tractor Allowance Balance includin	g this authorization:	\$0.00
cknowledgment:			
Project Manage	r Signature	Name (Printed)	Date
District Represe	ntative Signature	Name (Printed)	Date
•	-	. ,	
cc: Project File			

Revised 9/20/17

### SUBSTITUTION REQUEST FORM

<u>To</u> : <insert contact="" info=""></insert>	From: Contact: Email: Phone:
Owner: RSCCD – Santiago Canyon College Project: Campus Entrance Improvements – Phase 1	Submittal Date:
PROPOSED SUBSTITUTION	
Specification Section, Article, Paragraph:	
Applicable Drawing & Details:	
Proposed Substitution:	
Manufacturer:	
Product/Model:	
REASON FOR SUBSTITUTION REQUEST	
EFFECTS OF PROPOSED SUBSTITUTION	
Does substitution affect dimensions indicated on Drawing	
□ NO □ YES Explain:	
Does substitution affect Work of other Sections?	
□ NO □ YES Explain:	
Does substitution require modifications to design, cha incorporated into the Project?	
□ NO □ YES Explain:	
CONTRACTOR'S REPRESENTATION Undersigned accepts responsibility for coordination of proposed substaccepts all additional costs resulting from the incorporation of proposed into the Project per Section 016000.	
Subcontractor	DISTRICT/ARCHITECT'S REVIEW
Signature:	Accepted
Date:	
Contractor	
Signature:	Reviewer:
Date:	Review Date:



To: Rancho Santiago Community College District

		Payment Application No.:					
Campus Name:		Project Number:					
Project Name:		Contract Number:					
Campus Name:							
	Progress Payment	☐ Final Payment					
The following i	tems have been VERIFIED:						
	Contified Paymell Pagends submitted to DID						
	•	undated on CDIa)	There But				
		updated on CDS)	i nru Date				
	- · · · · · · · · · · · · · · · · · · ·						
		ent Progress Reports					
	-	- ·					
		TIOI GUDG					
<del>_</del>							
_							
_		with approved Schedule c	of Values				
			n values				
	and Accounting Verification Summary sheet included	(2nd tab)					
The following	REQUIRED documents are ATTACHED {w/docs in or	rder listed}:					
	Contractor Payment Checklist						
	Accounting Verification Summary (signed by CM)						
	Stop Notice Summary Log						
	Application for Payment w SOV (4 originals signed, 3 set	nt to District)					
	Conditional Release from Prime Contractor and S	ubcontractor Release Lo	g				
	Other:						
ATTACH AND/	OR VERIFY additional REQUIRED documents as ne	eeded:					
	Consent of Surety for Final Payment						
	Certificate of Substantial Completion (ONLY Required	for payment at Substantial Comp	oletion)				
	Unconditional Waiver and Releases Upon Final Pa	ayment (Contractor/Subcontrac	tors)				
	Warranties, guarantees and maintenance agreeme	ents					
	Training Program and M&O Books						
	Report of Completion & Recommendation of Acce	eptance (w/ required attachmer	nts)				
	Final Punchlist Acceptance (note any holds or cor	ntested items)	·				
Construction Mar	ems and/or documents referenced above have been verified tager) and submitted in accordance with the contract docum to make payment under the Contract:	by the Prime Contractor (and	•				
Project M	lanager/Contractor Name Sig	nature	Date				
	Project Manager Sig	nature	Date				
	rojost manager Sig	matar 6	Date				

cc:



### APPLICATION FOR SUBMITTAL OF POST-APPROVAL DOCUMENT

This application is for submittal of documents, after the initial approval of the project (post-approval documents), that require Division of the State Architect (DSA) review and approval. This form shall be completed by the Design Professional in General Responsible Charge of the project, in accordance with California Code of Regulations, Title 24, Part 1, Sections 4-317, 4-323 and 4-338 and in compliance with DSA IR A-6: Construction Change Document Submittal and Approval Process.

DSA documents referenced within this form are available on the DSA Forms or DSA Publications webpages.

DSA documents reference	ed within this form are available or	Title DSA FOILIS	S OF DOA Publications W	eupages.				
1. SUBMITTAL TYPE:	(Is this a resubmittal? Yes No	v <u>~</u> )						
Deferred Submittal □	Addendum Number: 2	Revision N	Number:	CCD Num	iber:	Category A or B		
2. PROJECT INFORM	ATION:							
School District/Owner:	RANCHO SANTIAGO COMMUNI	TY COLLEGE D	DISTRICT		DSA File Numbe	r: 30	C2	
Project Name/School: 5	SANTIAGO CANYON COLLEGE (	CAMPUS ENTR	ANCE IMPROVEMENT	S - PHASE	DSA Application	Number: 04	121029	
3. APPLICANT INFOR	MATION:							
Date Submitted: 01/03/	23	At	tached Pages? No⊡Y	es 🗹 Numb	er of pages? 8			
Firm Name: SVA Archit	tects, Inc.	C	ontact Name: Robert Si	mons				
Work Email: BSimons@	sva-architects.com	W	ork Phone: (949) 809-3	380	T.			
Firm Address: 6 Hutton	Centre Drive, Suite 1150	C	ty: Santa Ana		State: CA	Zip Code: 92	2707	
4. REASON FOR SUB	MITTAL: (Check applicable box	es)						
☑ For revision or adden	dum prior to construction.			☐ For a p	project currently u	nder constructi	on.	
☐ For a project that has a 90-Day Letter issue	a form <i>DSA 301-N: Notification of</i> d.	f Requirement fo	or Certification, DSA 301	I-P: Posted	Notification of Re	quirement for (	Certification or	
☐ To obtain DSA appro	val of an existing uncertified buildi	ng or buildings.						
☐ For Category B CCD	this is: a voluntary submittal,	a DSA required	submittal (attach DSA r	notice requi	ring submission).			
5. DESIGN PROFESSI	IONAL IN GENERAL RESPONSI	BLE CHARGE:						
Name of the Design Pro	fessional In General Responsible	Charge: Rober	t Simons					
Professional License Nu	ımber: C-18301		Discipline: Architecture					
and appear to meet the incorporation into the co	a General Responsible Charge S appropriate requirements of Title 2 instruction of the project.							
Signature:	DESIGN PROFESSION.		ESPONSIBLE CHARGE		<del></del>			
6. CONFIRMATION, D	ESCRIPTION AND LISTING OF I	-						
For addenda, revisions, Design Professional liste Use of Construction Doo	or CCDs: CHECK THIS BOX ☑ to ed on form DSA 1: Application for a cuments Prepared by Other Profes cable, for signature and seal require	o confirm that <i>all</i> Approval of Plar ssionals, and IR	ns and Specifications for	this projec	t. (For Deferred S	<i>ubmittals</i> , refer	r to <i>IR A-18:</i>	
	on of construction scope for this po							
PVC SCH.40 and detail H	C-4.1 & C-5.2 to remove an existir I to use SCH.80 nipple MIPT and #4 on 6/L-6.01 to add 4-inch mulch	slip match valve	size. Added note on sh	eet L-501 t	o add root barrier	at trees within	8-ft. of	
List of DSA-approved dr	rawings affected by this post-appro	oval document:						
Civil sheet(s): CD-1.3, C-	-4.1, C-5.2, Landscape sheets: L-4	4.01, L-5.01, L-6	.01 and Electrical Sheet	(s): E-103 a	and E-501			
		DSA	USE ONLY					
			Retu	rned	D	SA STAMP		
sss <u>LR</u> _D	ate 01/04/2023    【Approved □Dis	sapproved □Not I	Required <b>Date:</b> 01/04/20	23	A	PPROVED		
Comments:			By:	20	DIV. OF THE	STATE ARG	CHITECT	
FLSD	ate □Approved □Dis	sapproved XNot	Required		APP: 04-1	21029 IN	C:	

Comments:

Comments:

\_Date\_\_\_\_\_ □Approved □Disapproved ☒Not Required


01/04/2023

ACS \_

REVIEWED FOR

SS 🗹

DATE:

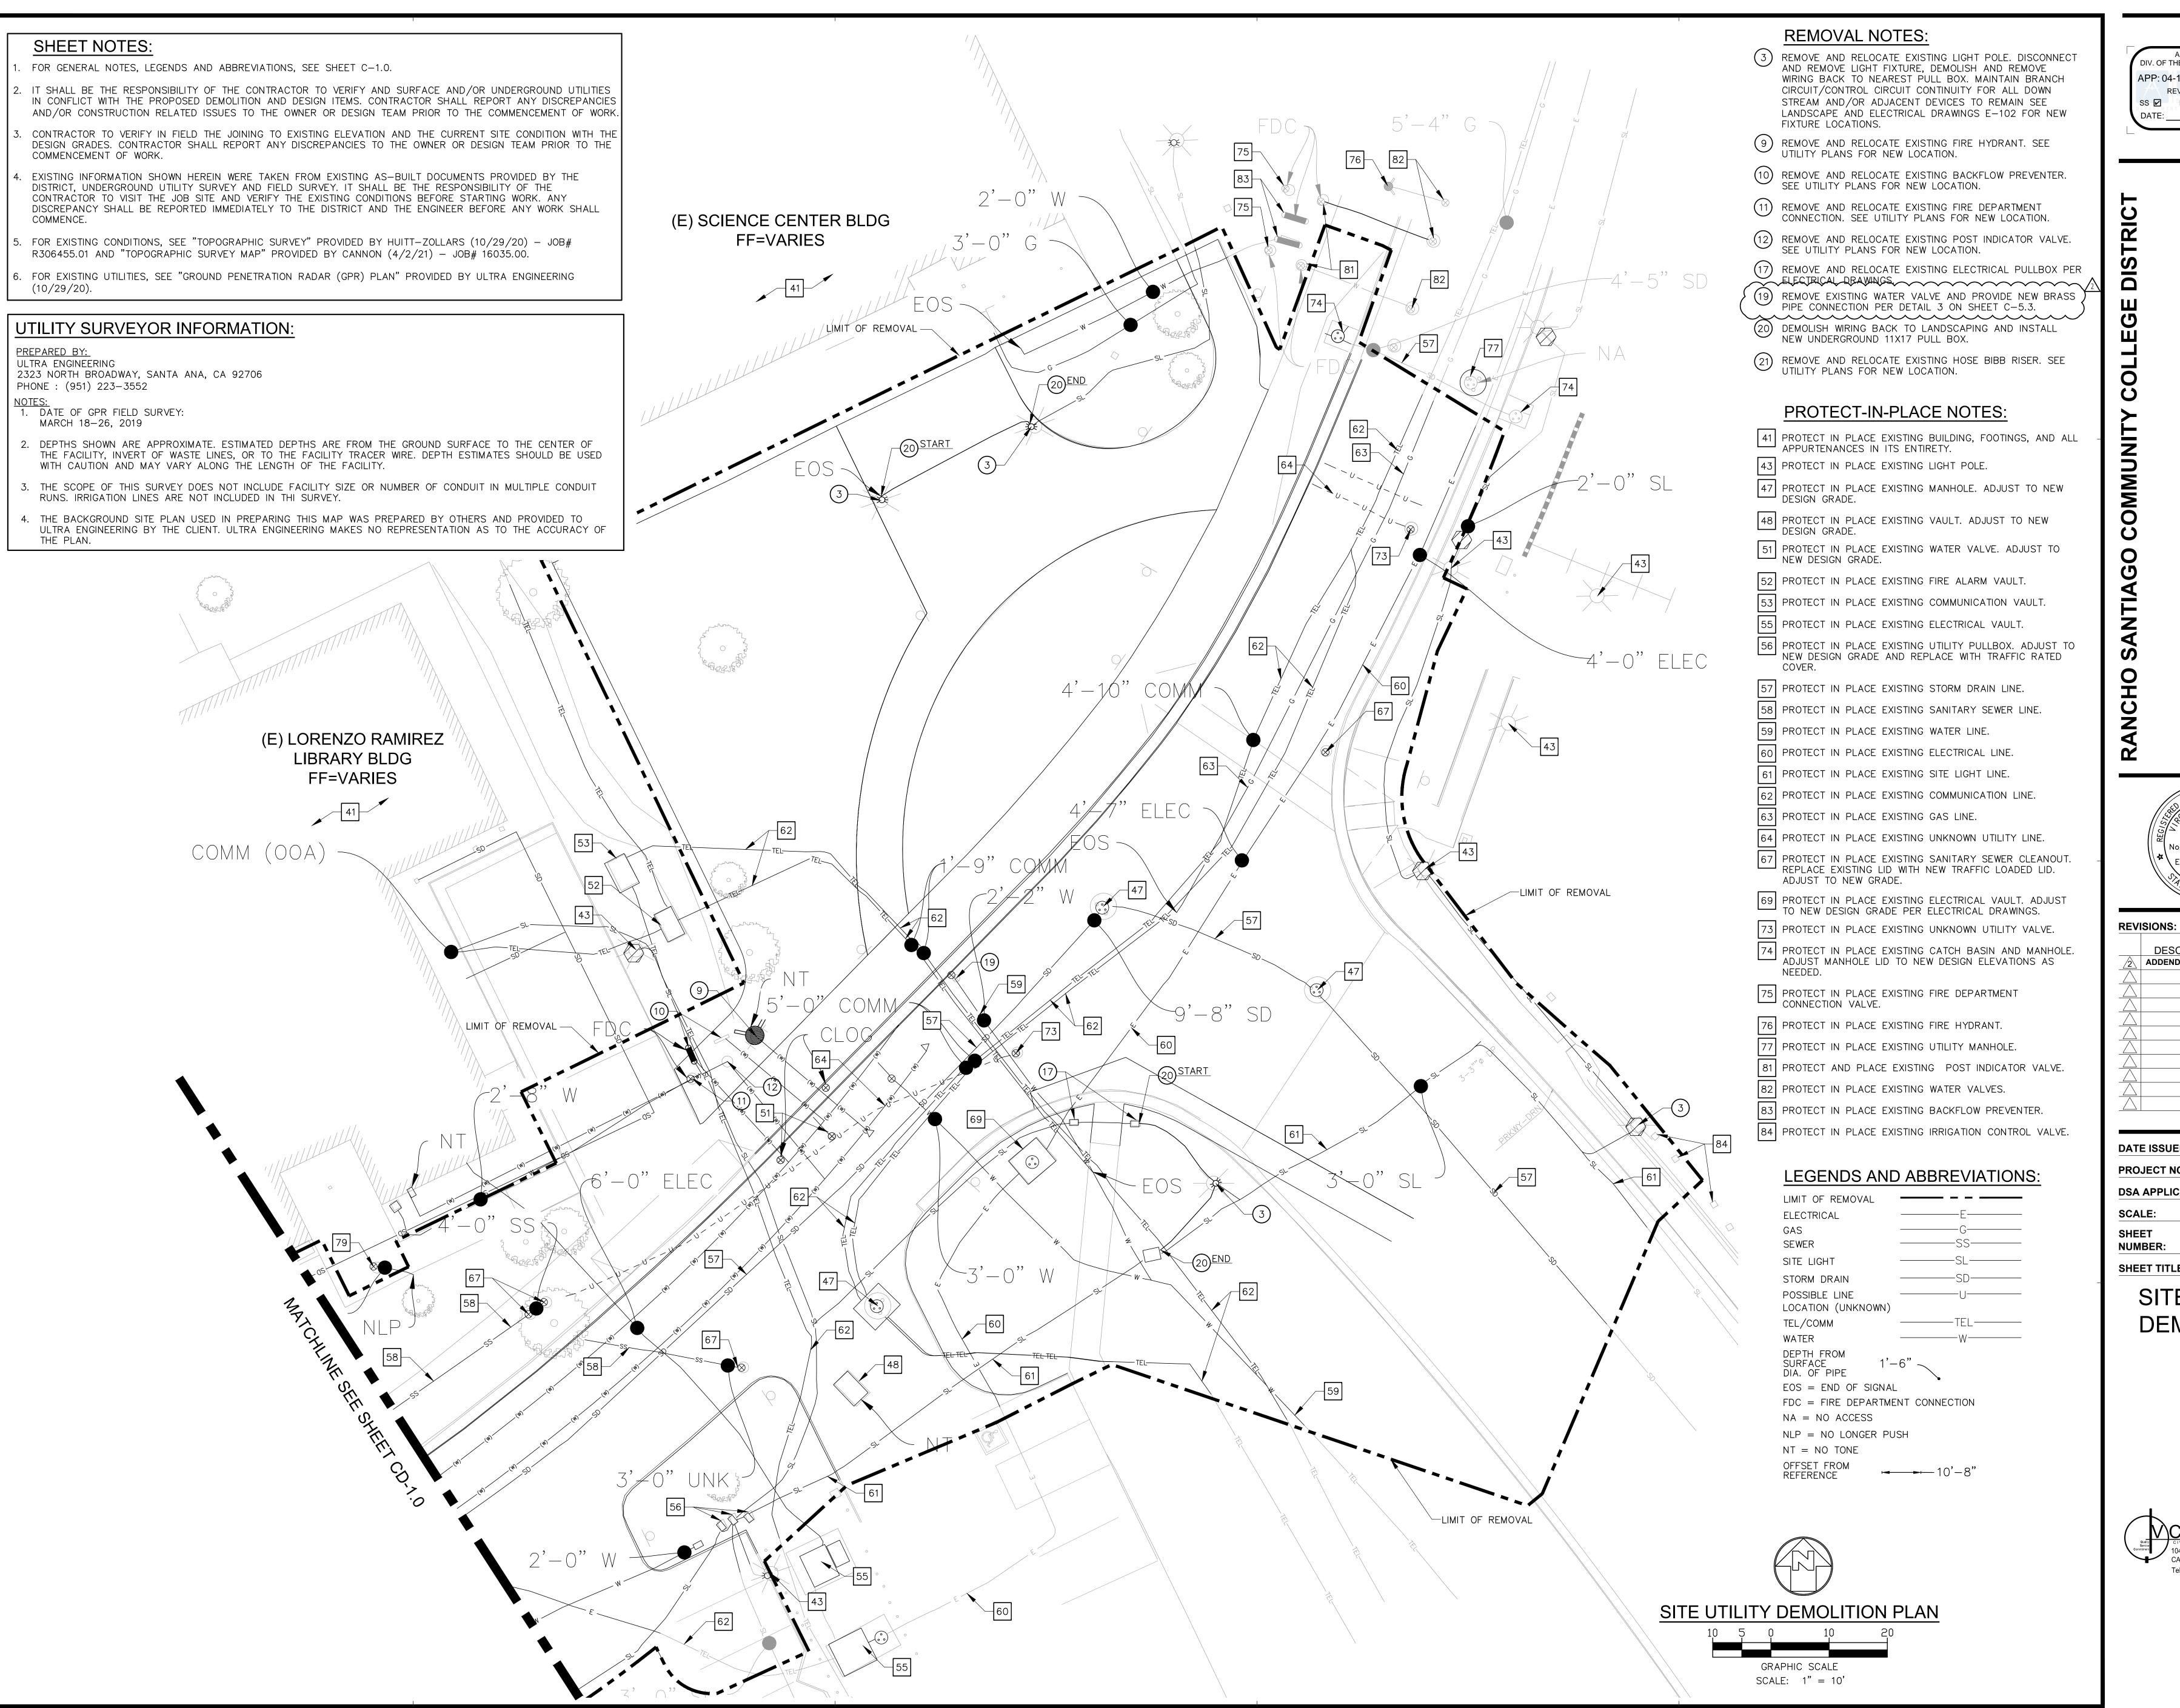

DIV. OF THE STATE ARCHITEC APP: 04-121029 INC: REVIEWED FOR SS ☑ FLS ☐ ACS ☐ DATE: 01/04/2023

응툍

DATE

DESCRIPTION

ADDENDUM 2

⊕ S ←


S S E

**DATE ISSUED:** 2018-11-19 PROJECT NO: 2018-40167 **DSA APPLICATION NO:** 04-121029

As indicated CD-1.3 NUMBER: SHEET TITLE:

SITE UTILITY DEMOLITION PLAN



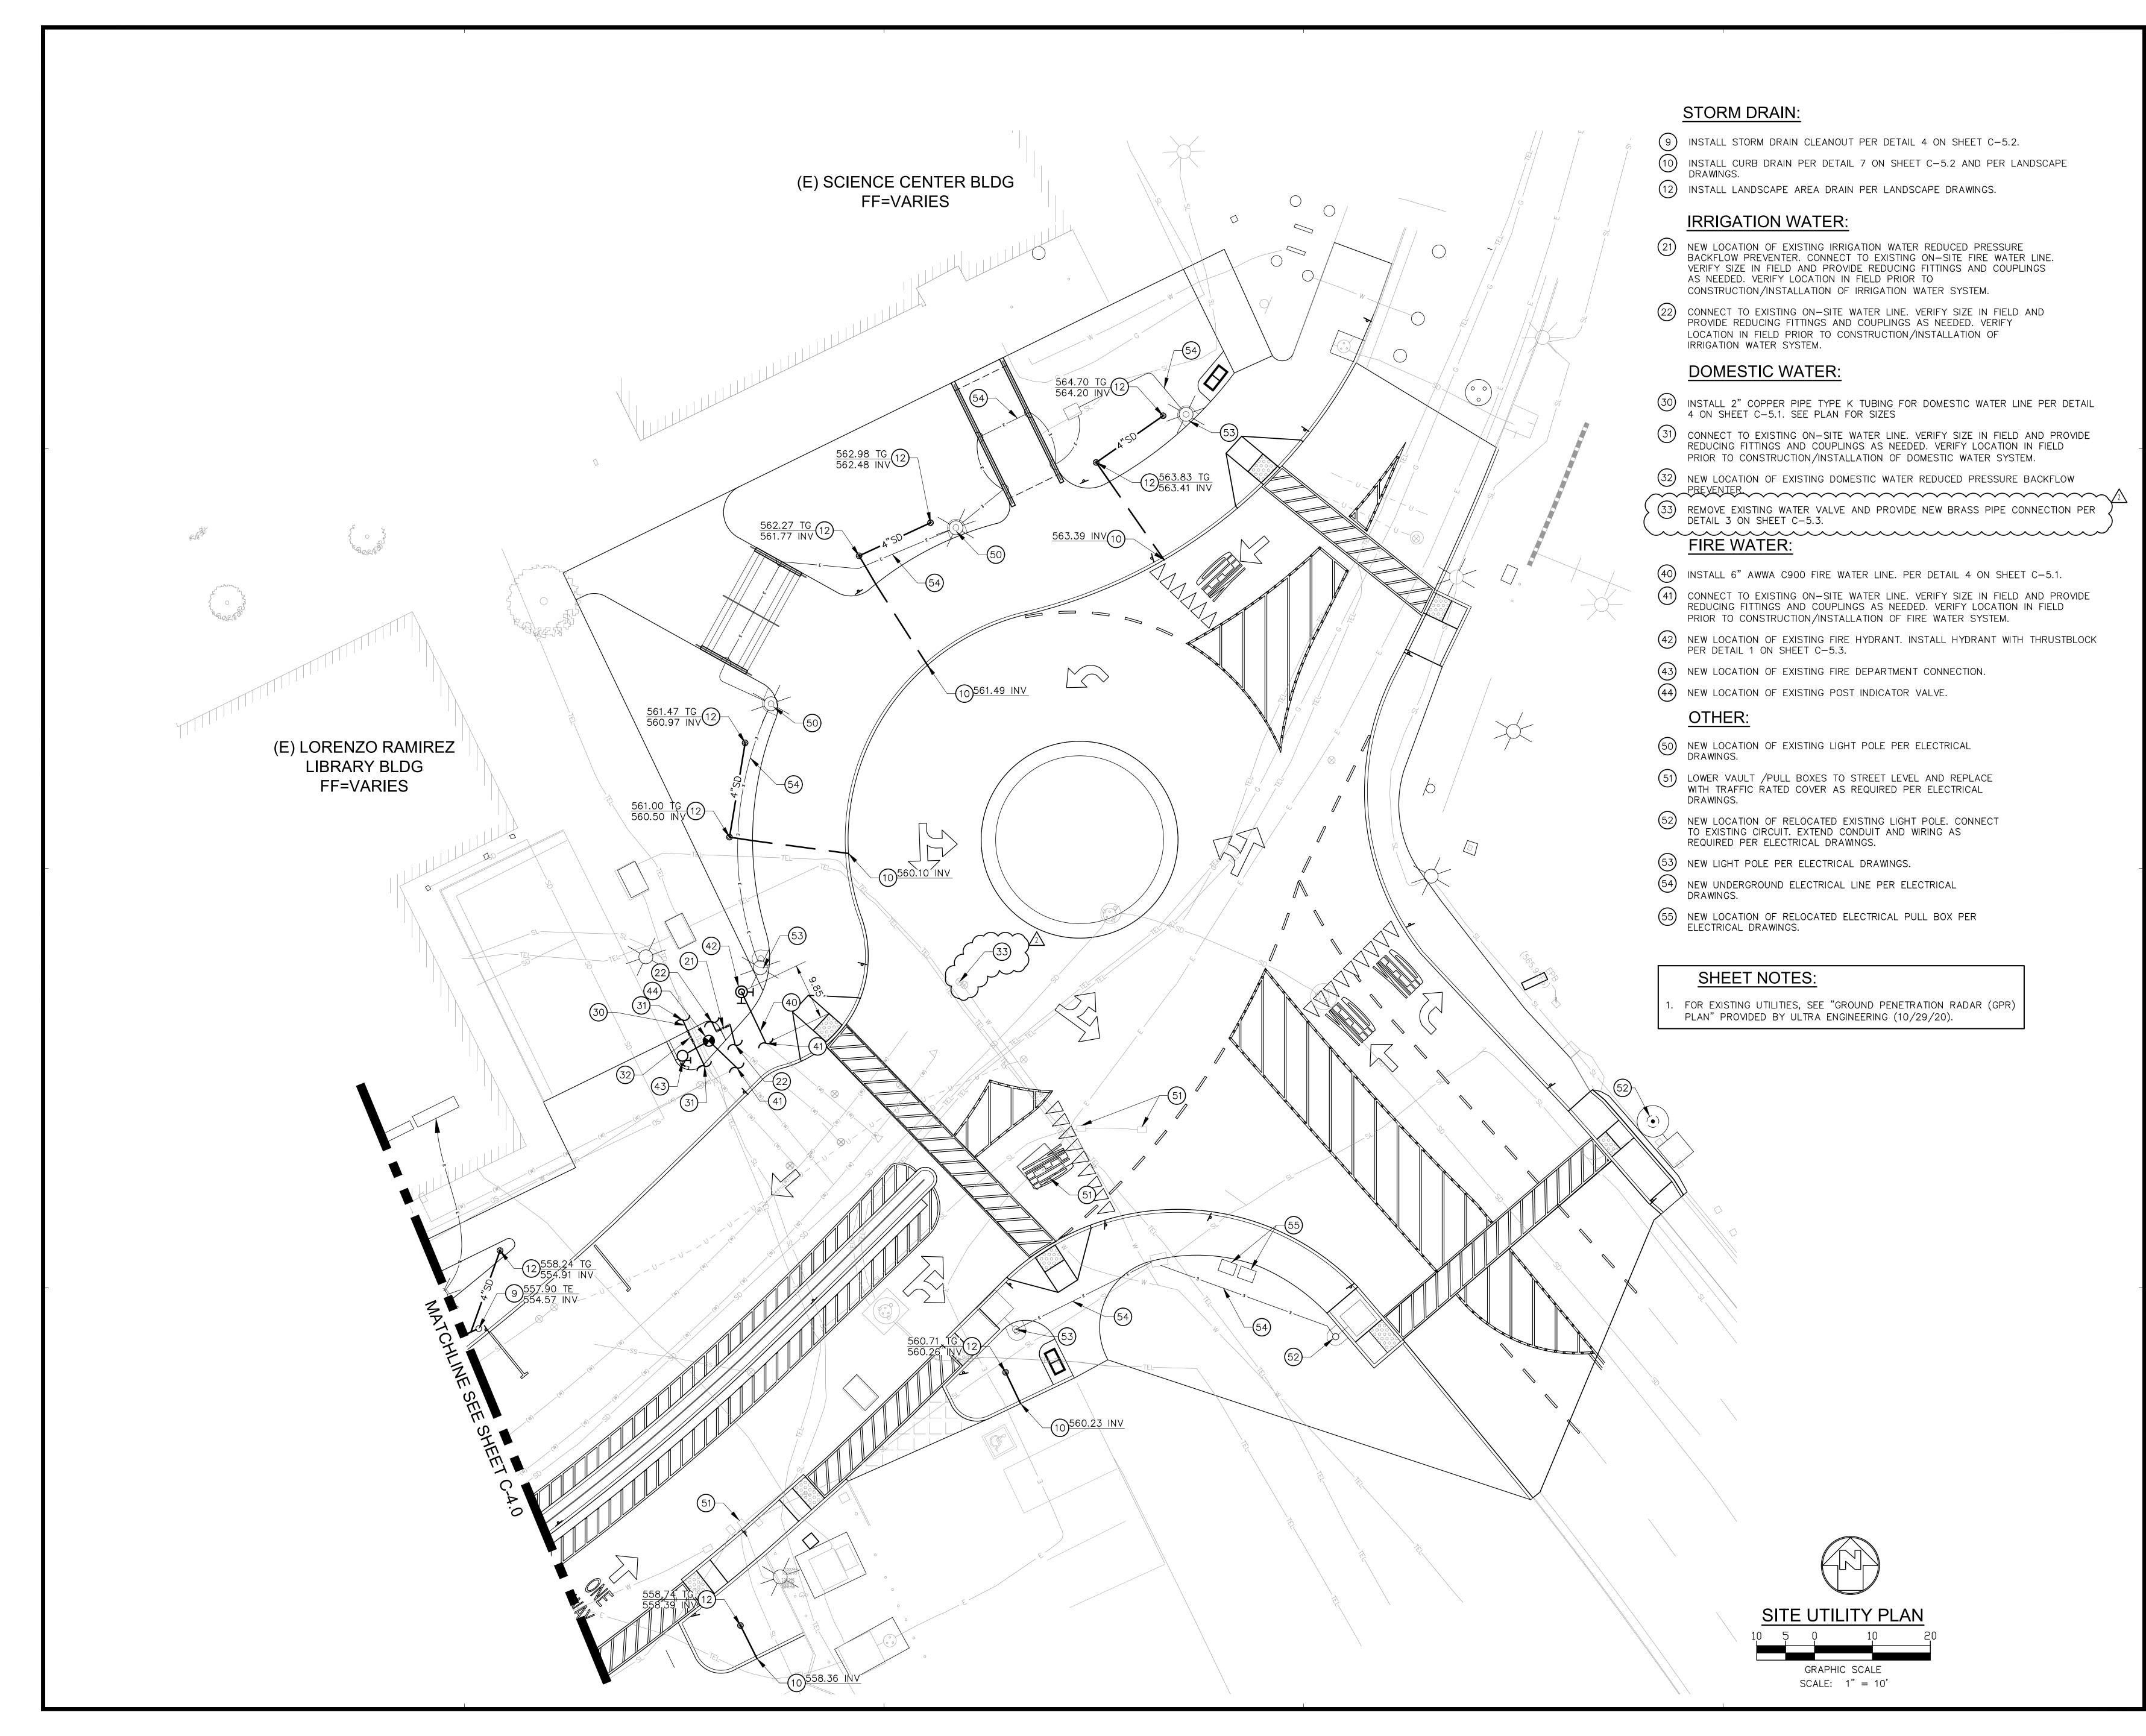

APPROVED
DIV. OF THE STATE ARCHITECT

APP: 04-121029 INC:
REVIEWED FOR
SS FLS ACS DATE:
01/04/2023

SANTIAGO CANYON COLLEGE CAMPUS ENTRANCE IMPROVEMENTS | PHASE 1

OF VICIONIC:

 DATE ISSUED:
 2018-11-19

 PROJECT NO:
 2018-40167

 DSA APPLICATION NO:
 04-121029

 SCALE:
 As indicated

NUMBER: C-4.1
SHEET TITLE:

SITE UTILITY PLAN



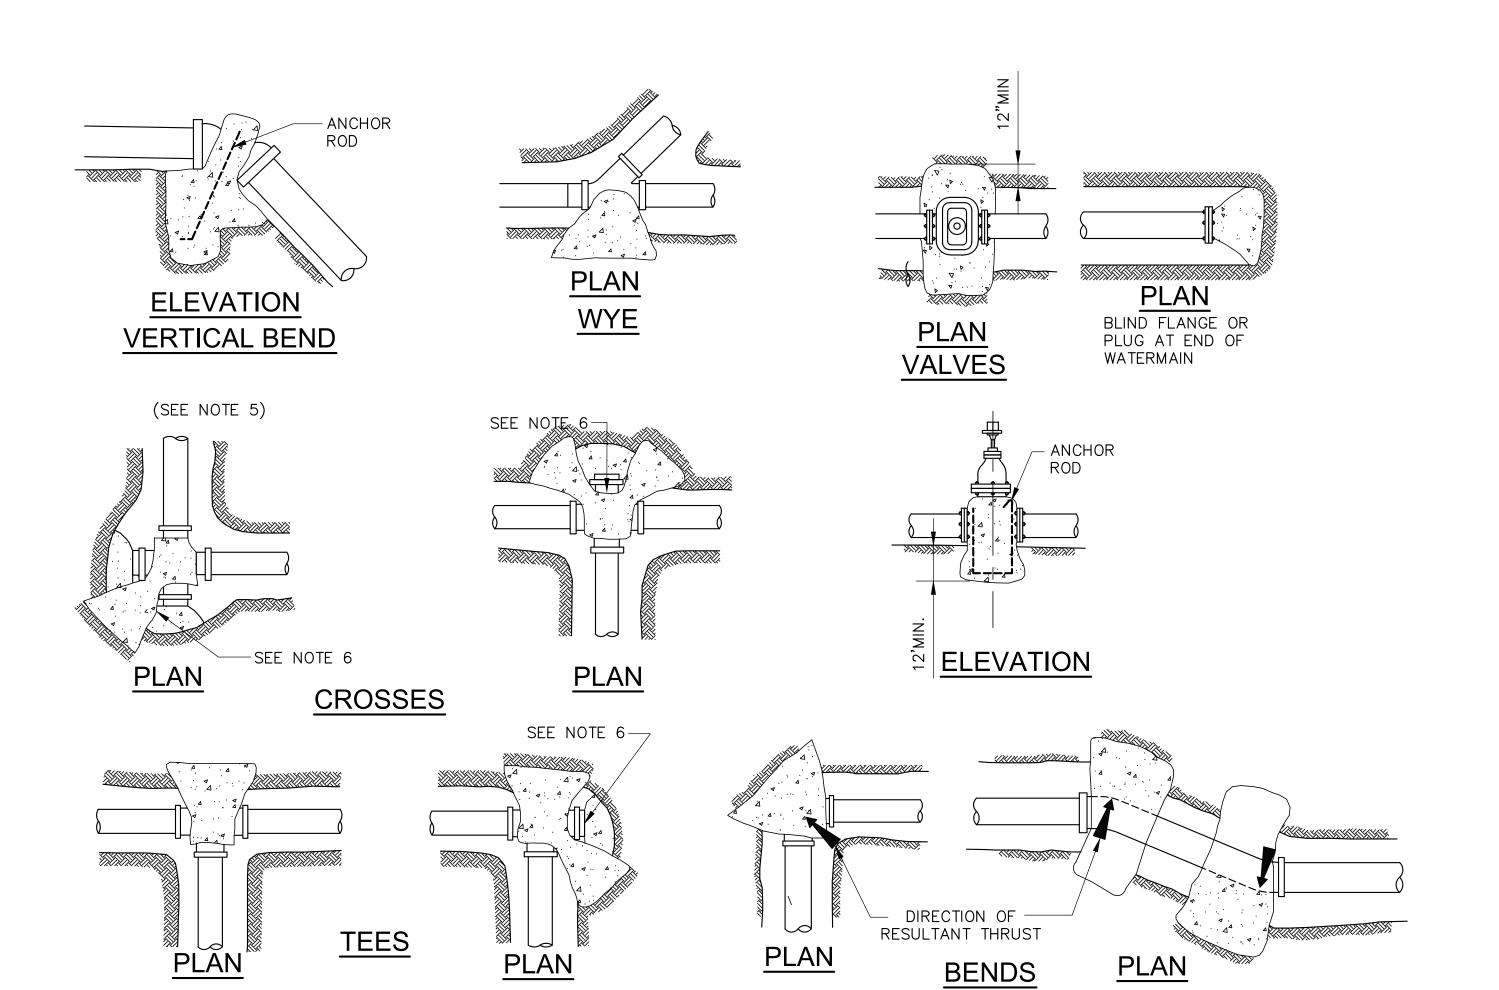


TABLE 1

			•						
MINIMUM BEARING AREAS IN SQ.FT.									
MAIN SIZE	TEE	90° BEND	45° BEND	22 1/2° BEND					
6"	4	4	4	3					
8"	5	7	4	3					
10"	9	12	6	4					
12"	12	16	9	6					
	011 450	501 1111		-001105					

BASED ON 150 PSI W.W.R. PRESSURE & SOIL BEARING LOADS OF 2000 PSF THE RATIO OF WIDTH TO HEIGHT SHALL NOT EXCEED 1 1/2 TO 1

TEES,PLUGS,CAPS & HYDRANTS.

TABLE II

SOIL TYPE	MAX. ALLOWABLE SOIL BEARING VALUES	FACTORS FOR INCREASING AREAS IN TABLE 1
LOOSE SAND	500 PSF	4
SOFT SANDY CLAY	1000 PSF	2
ADOBE	1000 PSF	2
COMPACT FINE SAND	2000 PSF	1
COMPACT COARSE SAND	2000 PSF	1
MEDIUM STIFF CLAY	2000 PSF	1

\* THE CONTRACTOR SHALL BE RESPONSIBLE FOR DETERMINING THE SAFE SOIL BEARING VALUES AND SIZE OF BEARING AREAS.


BASED ON 2 FEET MINIMUM DEPTH OF COVER OVER THE PIPE.


### NOTES:

- 1. ALL ANCHOR AND THRUST BLOCKS SHALL BEAR AGAINST UNDISTURBED SOIL.
- 2. MINIMUM ALLOWABLE WATER PRESSURE FOR DESIGN OF THRUST BLOCKS IS 150 PSI. BEARING AREA INCREASE IN PRESSURE.
- 3. ALL CONCRETE USED IN THRUST BLOCKS SHALL ATTAIN 2000 PSI STRENGTH.
- 4. ALL ANCHOR RODS SHALL BE REINFORCING STEEL AND A MINIMUM OF 1/2-INCH IN DIAMETER.
- 5. USE ANCHOR BLOCKS AT VERTICAL BENDS WHEN PIPE IS ABOVE OR BELOW GROUND. SIZE OF BLOCK AND ROD SHALL BE AS SHOWN ON THE PLANS OR AS DETERMINED BY THE ENGINEER IN THE FIELD.
- 6. USE 30 POUND FELT TO INSURE COLD JOINT.
- 7. CONCRETE SHALL NOT COME INTO DIRECT WITH ASBESTOS CEMENT PIPE.
- 8. FOR PIPE 14" IN DIAMETER OR LARGER ENGINEER IS TO SUBMIT CALCULATIONS.

1 THRUST BLOCK DETAIL

NOT TO SCALE

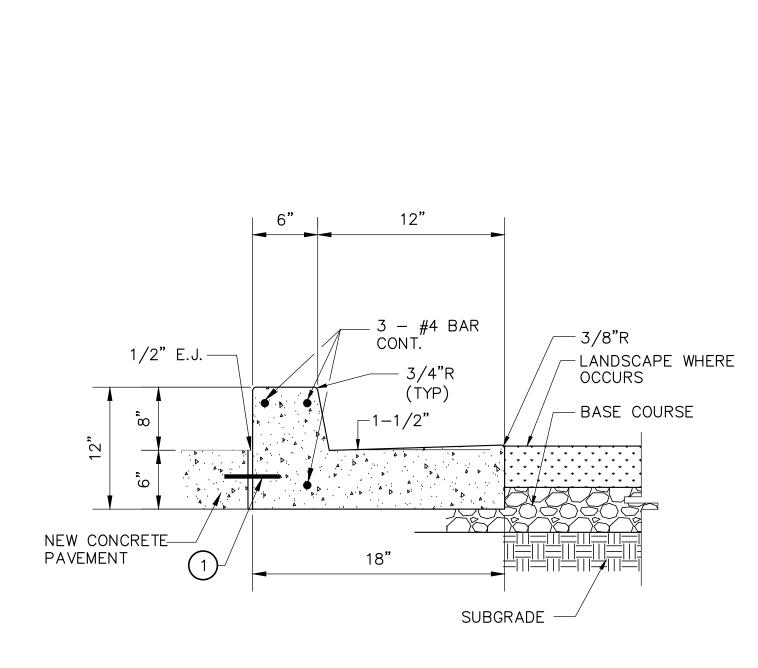

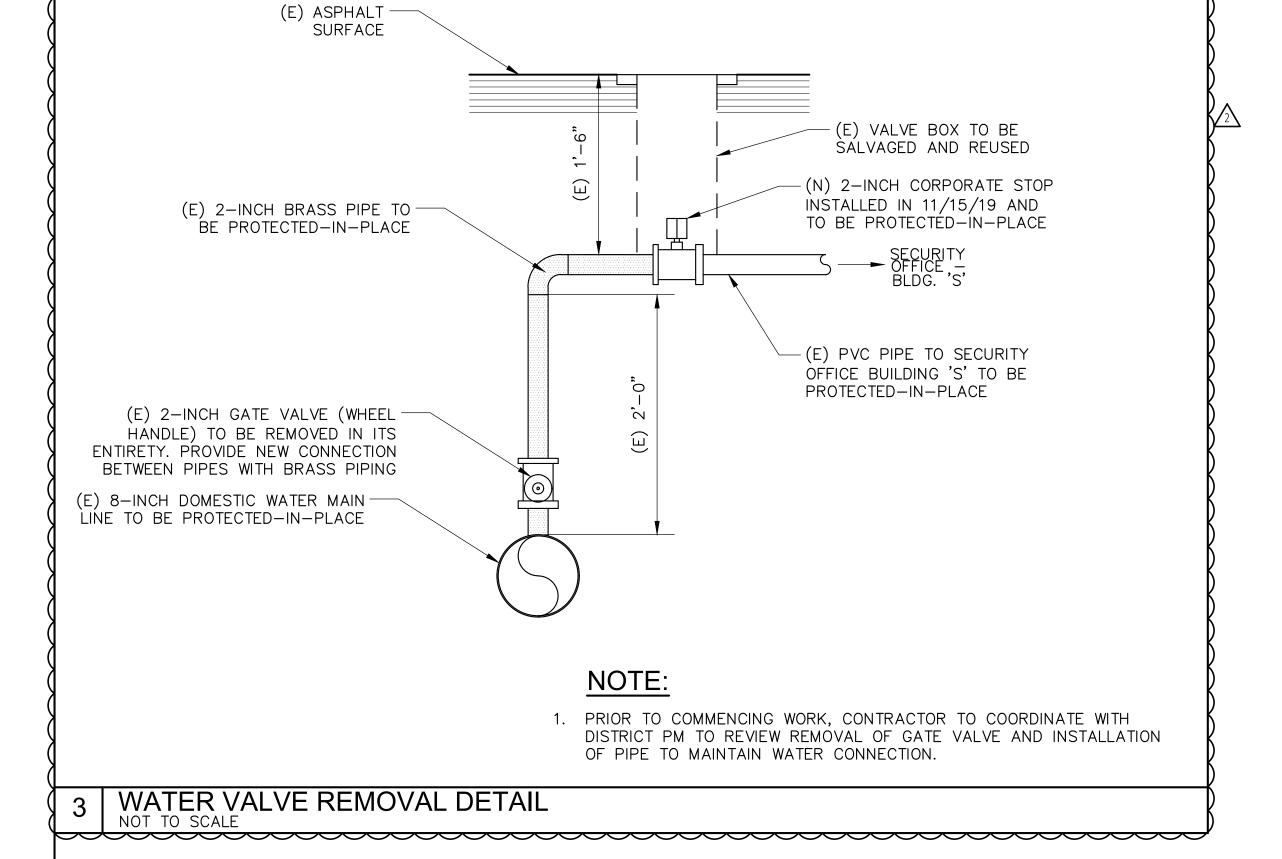

NOTE:

1. 18" #4 REBAR W/ 'SPEED DOWEL' @ 36" OC, CENTER IN CONC. AT COLD JOINTS & E.J.'S

MISCELLANEOUS
DETAILS

C-5.3

DSA APPLICATION NO: 04-121029



2 CONCRETE CURB AND 12" GUTTER DETAIL
NOT TO SCALE

APPROVED
DIV. OF THE STATE ARCHITECT

APP: 04-121029 INC:

REVIEWED FOR
SS FLS ACS 
DATE: 01/04/2023

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**REVISIONS:** 

DATE ISSUED:

**PROJECT NO:** 

SCALE:

NUMBER:

FIAGO CANYON COLLEGE
PUS ENTRANCE IMPROVEMENTS F
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PROFESS/ONANTER No. C36079

Exp. 6/30/24

CIVII

DESCRIPTION

**ADDENDUM 2** 


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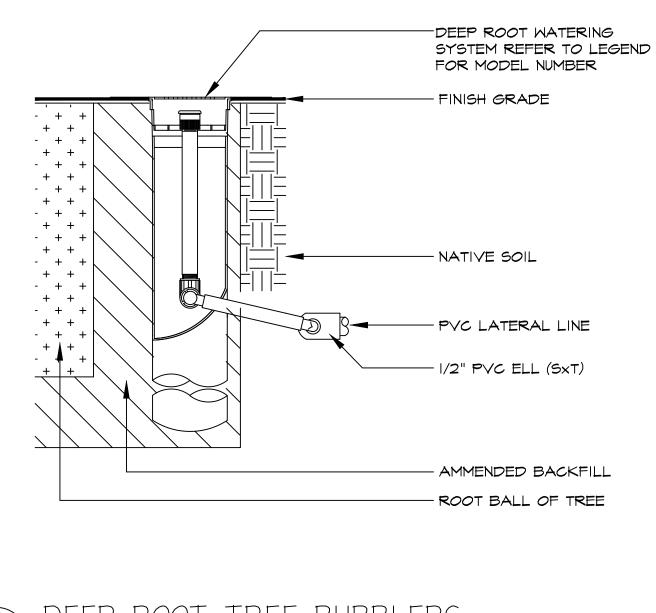
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2018-11-19


2018-40167

As indicated





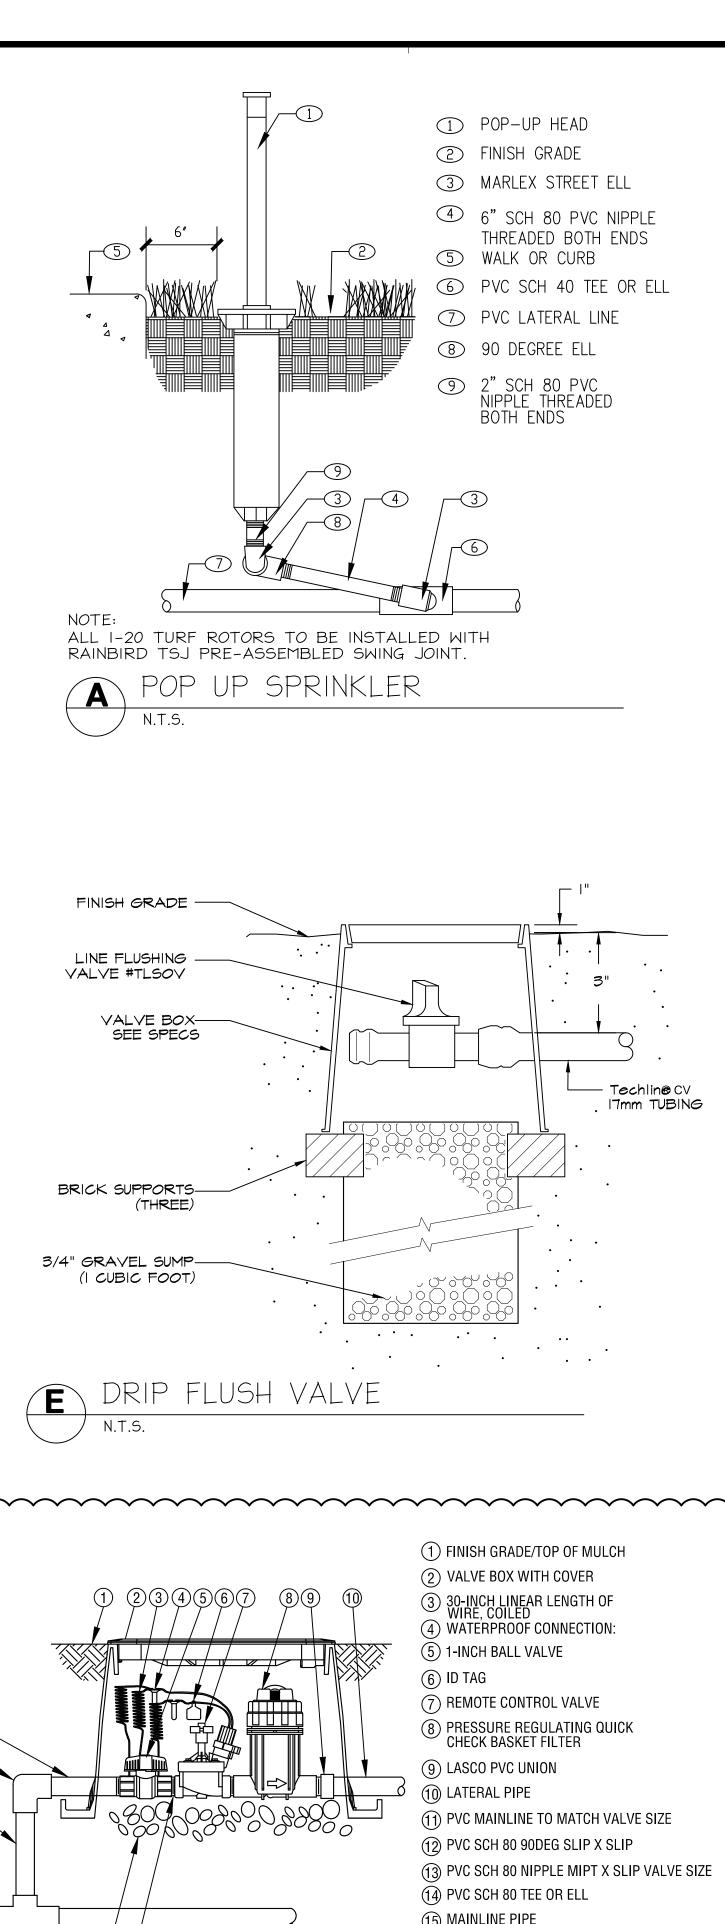

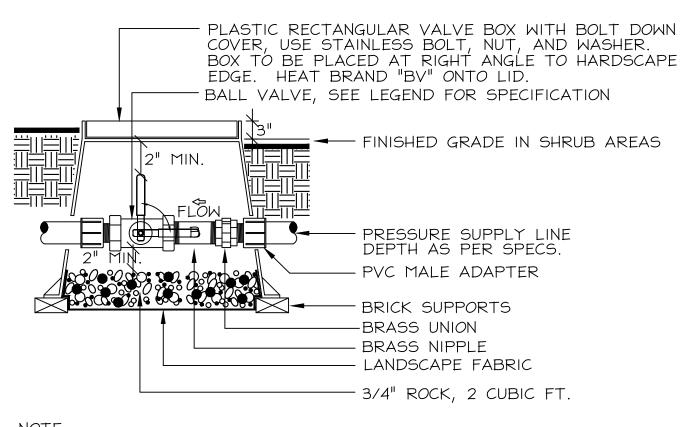

BOX TO BE INSTALLED AS TO ALLOW FOR PROPER OPERATION OF BALL VALVE INSTALL AT RIGHT ANGLE TO HARDSCAPE EDGE, INSTALL VALVE OFF-CENTER IN BOX. INSTALL VALVE BOX EXTENSIONS AS REQUIRED TO ACHIEVE PROPER VALVE INSTALLATION AT MAIN LINE DEPTH.

PIPE/SLEEVE LEGEND:

6 CONTROL WIRES OR COM. CABLE

PVC MAINLINE (FOR NON-POTABLE USE PURPLE

PVC LATERAL LINE (FOR NON-POTABLE USE PURPLE PIPE WITH WORDS "RECYCLED WATER DO

CONTROL WIRES OR COM. CABLE IN CONDUIT


7 SLEEVE FOR MAINLINE AND/OR LATERAL LINE


8 FINE GRANULAR BACKFILL (1/2" MAX. DIA.)

PIPE WITH WORDS "RECYCLED WATER DO NOT

1 PAVING



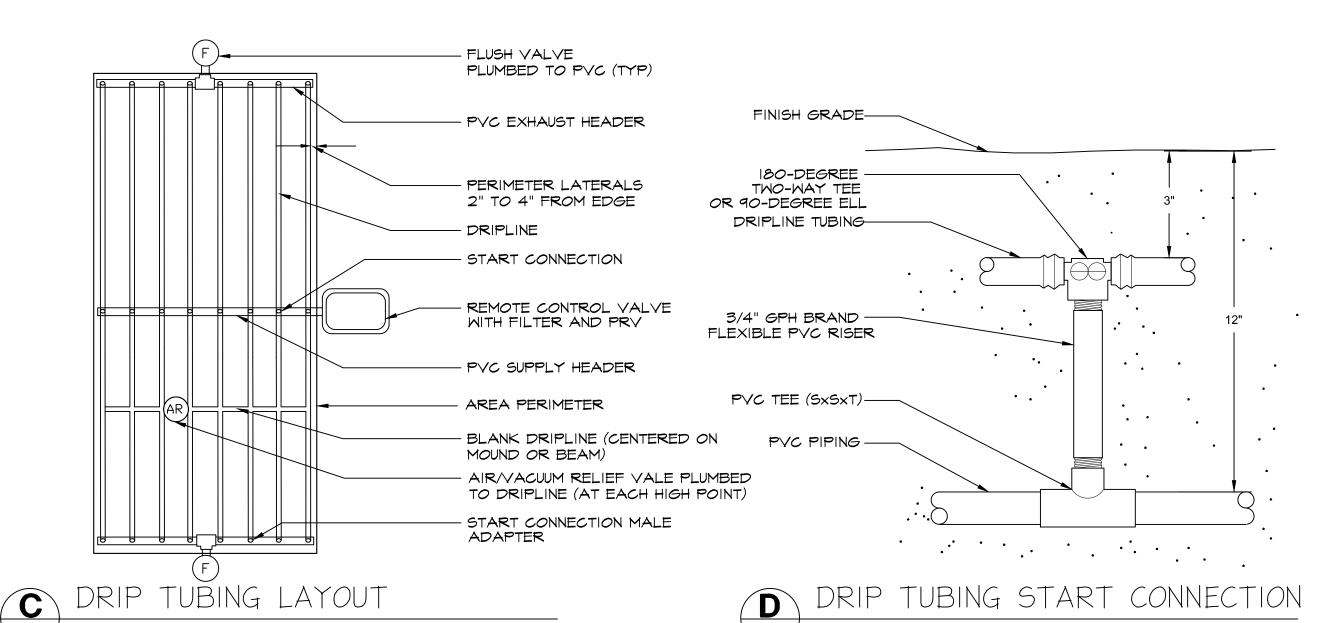


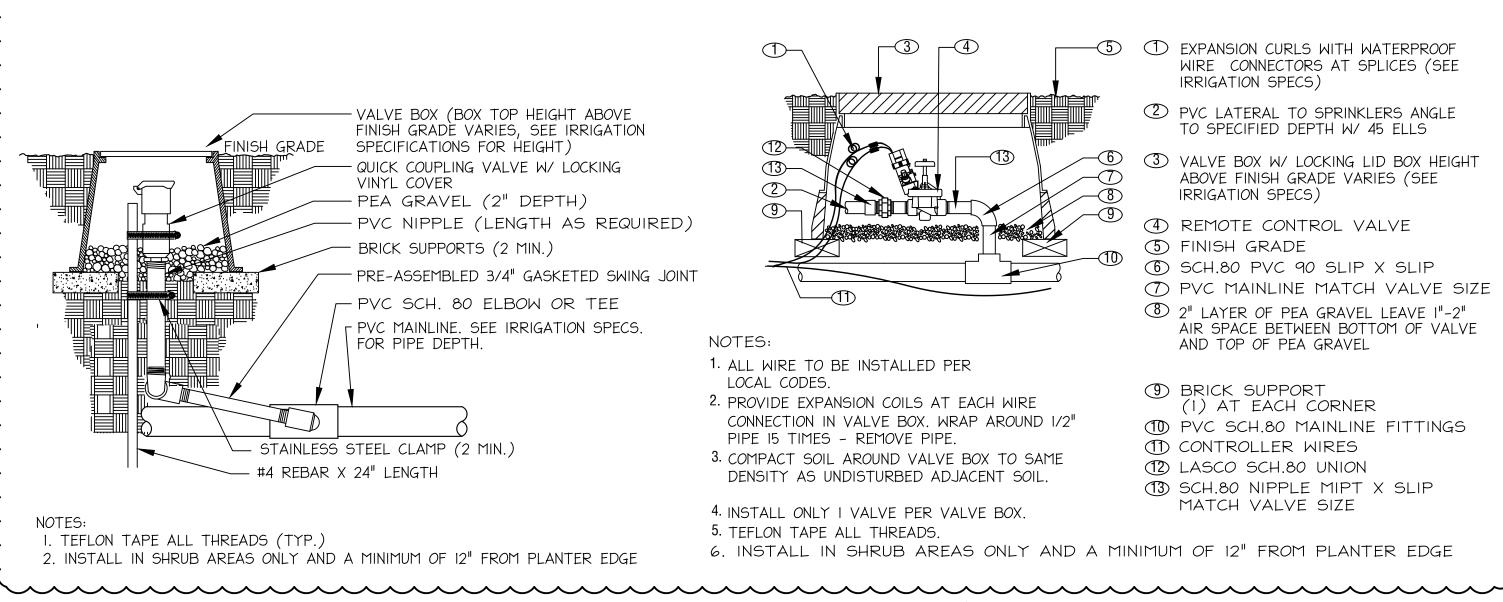

N.T.S.

FOR PATCHES TO EXISTING PEDESTRIAN PAVEMENT, THE CONTRACTOR

SHALL INSTALL THE PATCH IN COMPLIANCE WITH 11B-203.1 AND 11B-303 (TYPICAL)

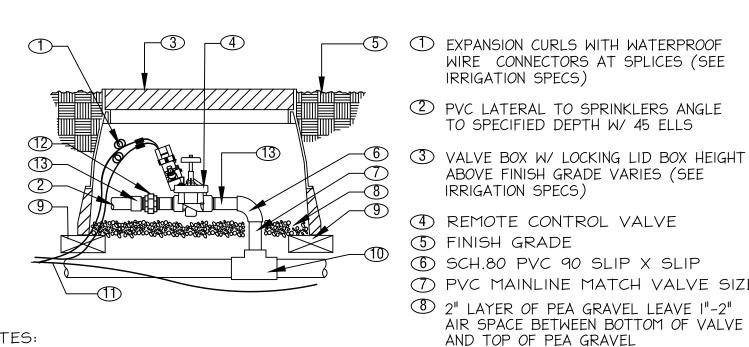

3 VALVE BOX W/ LOCKING LID BOX HEIGHT ABOVE FINISH GRADE VARIES (SEE IRRIGATION SPECS) 4 REMOTE CONTROL VALVE 5 FINISH GRADE 6 SCH.80 PVC 90 SLIP X SLIP 7 PVC MAINLINE MATCH VALVE SIZE 8 2" LAYER OF PEA GRAVEL LEAVE I"-2"

2. PROVIDE EXPANSION COILS AT EACH WIRE CONNECTION IN VALVE BOX. WRAP AROUND 1/2" 3. COMPACT SOIL AROUND VALVE BOX TO SAME DENSITY AS UNDISTURBED ADJACENT SOIL.


 BRICK SUPPORT (1) AT EACH CORNER (10) PVC SCH.80 MAINLINE FITTINGS ① CONTROLLER WIRES 12 LASCO SCH.80 UNION (13) SCH.80 NIPPLE MIPT X SLIP MATCH VALVE SIZE

6. INSTALL IN SHRUB AREAS ONLY AND A MINIMUM OF 12" FROM PLANTER EDGE

, Size Length

Length

REMOTE CONTROL VALVE Pipe Sizing Chart F.M. Upstream Downstream All master valve and flow sensor wires shall be installed All Models of

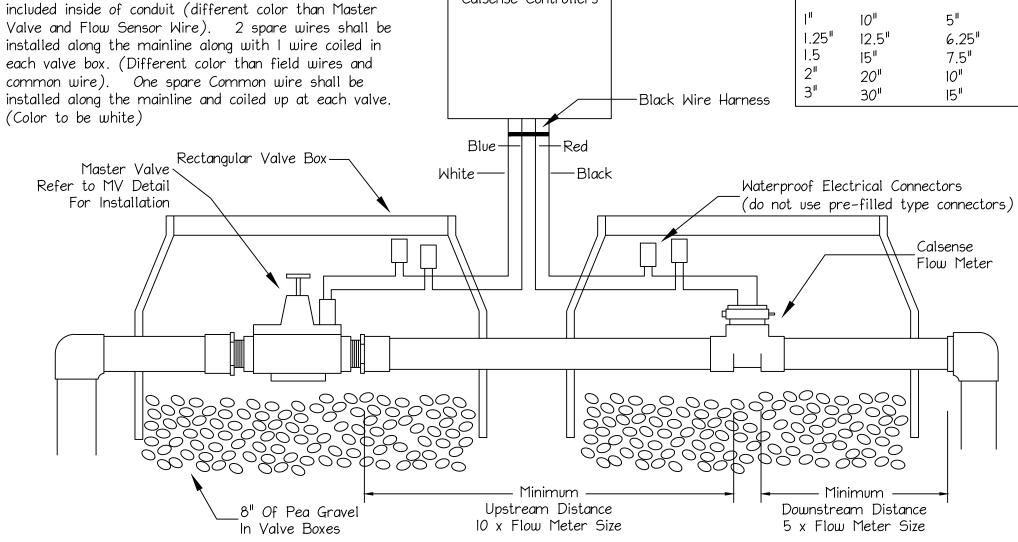


Calsense Controllers

**POC WIRING NOTES:** 


in conduit (sized accordingly). One spare wire shall be

MASTER VALVE / FLOW SENSOR INSTALLATION

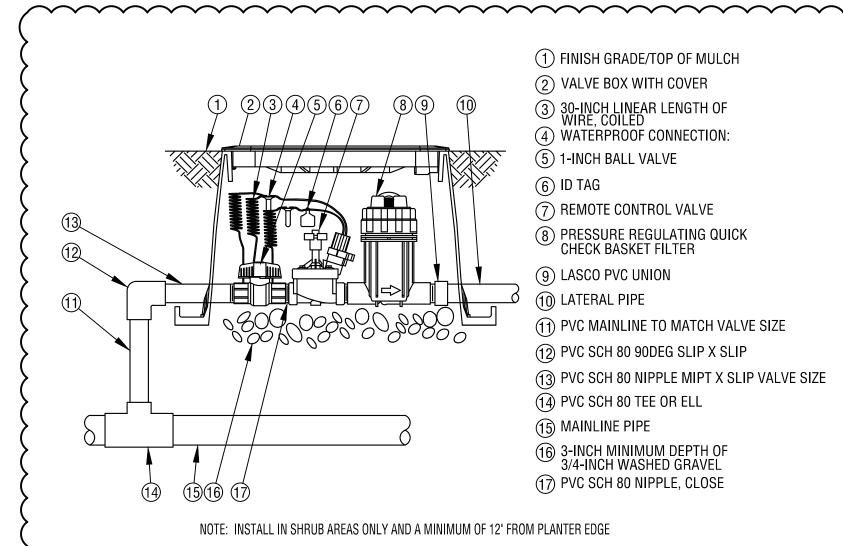

DRIP CONTROL ZONE KIT

2. CLOSE NIPPLES SHALL NOT BE USED

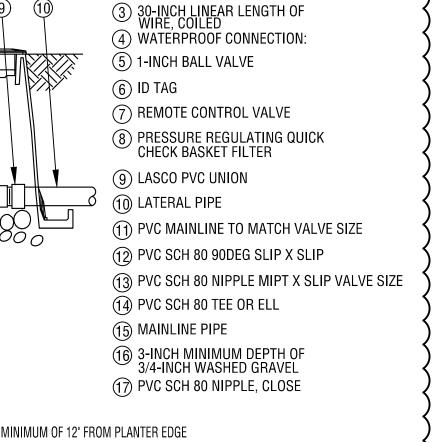

REDUCED PRESSURE BACKFLOW PREVENTER W/

- 3" LONG BRASS THREADED NIPPLE

- BRASS RISER (LENGTH AS

- P.V.C. MAINLINE, SEE IRRIGATION

- 8" BRASS THREADED NIPPLE (TYP.)

REQUIRED, TYP.)

── BRASS ELBOW (TYP.)

— P.V.C. SCH. 40 FEMALE ADAPTER (TYP.)

- 12"x12"x30" CONCRETE


THRUST BLOCK

SPECS. FOR PIPE DEPTH

QUICK PAD W/ S.S. BACKFLOW ENCLOSURE

BALL VALVES

- BRASS UNION

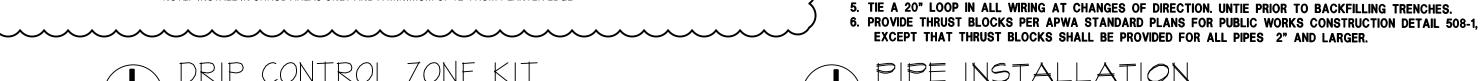





1. TAPE AND BUNDLE 24 V. WIRES @ 10' INTERVALS.

2. MINIMUM DEPTH OF 24 V. WIRING SHALL BE 24" BELOW GRADE. 3. TRENCH WIDTH ALLOW 4" MIN. CLEARANCE BETWEEN PARALLEL PIPES.


4. SNAKE PIPES FROM SIDE TO SIDE WITHIN TRENCH TO ALLOW FOR MOVEMENT.

					N. DL A	0510	24110	DICATI	ON COL	IED.III	- /BAIN	TEO	
					OPLA	CE LO	JAN IK	RIGATI	ON SCH	IEDUL	E (IVIII	NUTES,	<u>)                                    </u>
	JAN	FEB	MAR	APR	MAY	JUNE	JULY	AUG	SEP	ОСТ	NOV	DEC	Turf Root Depth 4"
	1	2	3	4	4	5	5	4	3	3	2	1	Shrub Root Depth 6"
Γ	.61	.64	.75	1.04	.95	.88	.94	.86	.74	.75	.69	.60	Depletion Factor (MAD) 40%
3	1	1	2	2	2	3	3	3	2	2	1	1	
													Soil Type (Textural) CLAY LOAM
	.07	.09	.12	.16	.17	.20	.21	.20	.16	.12	.09	.07	Field Capacity 27%
													Permanent Wilt Point 13%
													Apparent Specific Gravity 1 25

NOTE:

						C	oPLA(	CE LO	SAN IR	RIGATI	ON SCHI	EDUL	F (MIL	MULES	S)								
			JAN	FEB	MAR	APR	MAY	JUNE	JULY	AUG	SEP	OCT	NOV	DEC			Turf Ro	ot Depth		4	4"		
CYCLI	ES PER WI	EEK - TURF	1	2	3	4	4	5	5	4	3	3	2	1		,	Shrub Ro	oot Dept	h	6	6"		
TURF	CROP CO	EFFICIENT	.61	.64	.75	1.04	.95	.88	.94	.86	.74	.75	.69	.60		De	pletion F	actor (M	AD)	4(	0%		
CYCLE	S PER WE	EK-SHRUB	1	1	2	2	2	3	3	3	2	2	1	1									
																S		(Textura	I)		LOAM		
Eto DA	ILY AVERA	AGE	.07	.09	.12	.16	.17	.20	.21	.20	.16	.12	.09	.07				apacity			7%		
																		Wilt Poi			3%		
																App	arent Sp	ecific Gr	avity	1.	.35		
																IRRI	GATION	RUN TIM	ES				
Hydrozone	PLANT TYPE	Water Usage	Kc	1	NKLER /PE	EXPOSURE	EXPO FACTOR	PRECIP (in/hr)	SPKLR EFFIC.	ROOT DEPTH (in)	RUN TIME MULTIPLIER	JAN	FEB	MAR	APR	MAY	JUN	JUL	AUG	SEP	ОСТ	NOV	DEC
1	SHRUB	LOW	0.20	D	RIP	FULL SUN	100%	0.72	81%	6	1.23	10	13	9	12	12	10	10	10	12	9	13	10
2	SHRUB	LOW	0.20	RO	TARY	FULL SUN	100%	0.61	75%	6	1.33	13	17	11	15	16	12	13	12	15	11	17	13
3	TREE	MEDIUM	0.50	BUB	BLER	FULL SUN	100%	3.00	75%	12	1.33	7	8	6	7	8	6	7	6	7	6	8	7



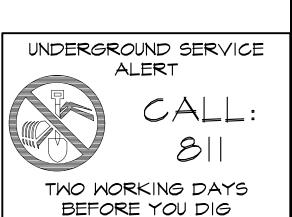



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	DESCRIPTION	DATE
	ADDENDUM 2	01/03/2023
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SCALE: SHEET	As indicated
DSA APPLICATION NO:	04-121029
PROJECT NO:	2018-40167
DATE ISSUED:	2018-11-19

SHEET TITLE: LANDSCAPE **IRRIGATION** 

**DETAILS** 



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REDUCED PRESSURE BACKFLOW

1. ALL RISER, UNIONS, ELBOWS AND NIPPLES SHALL BE RED BRASS.

3. EQUIPMENT TO BE INSTALLED A MIN. OF 12" FROM WALLS, BUILDINGS, ETC.

HEALTH DEPT. VERIFY LOCAL REQUIREMENTS PRIOR TO INSTALLATION.

4. INSTALL AND TEST BACKFLOW PREVENTER AS REQUIRED BY LOCAL CODES \$

	T-2  LIMIT OF WORK
	GYM & FITNESS CENTER BUILDING "G"
	MULCH-TEL PB PB PB
$\mathcal{N}_{i}$	
MULCH  6  7	
EX-I	

TREE LEGEND DISTRICT APPROVED PLANT BOTANICAL NAME COMMON NAME WUCOLS ZONE 3 SIZE GEIJERA PARVIFLORA SPACING PER PLAN 36" BOX YES AUSTRALIAN WILLOW SPACING PER PLAN PODOCARPUS GARCILIOR - FEMALE YES EX-I EXISTING TREE OR PALM TO REMAIN PROTECT IN PLACE AS SHOWN

SHRUB AND GROUNDCOVER LEGEND

		BOTANICAL NAME COMMON NAME	SIZE	SPACING	DISTRICT APPROVED PLANT	WUCOLS ZONE 3	QTY.
	<u>5</u>	DYMONDIA MARGARETAE SILVER CARPET	I GAL.	12" <i>0.</i> C.	NOT LISTED	٦	36
	S-2	MYOPORUM PARVIFOLIUM 'PUTAH CREEK' CREEPING MYOPORUM	I GAL.	3'-6" O.C.	YES	٦	208
+	S-3	LANTANA X 'NEW GOLD' LANTANA NEW GOLD	I GAL.	3'-6" O.C.	NOT LISTED	₹	78
$\bigcirc$	S-4	PHORMIUM TENAX SURFER NEW ZEALAND FLAX	5 <i>G</i> AL.	4'-0" O.C.	YES	٦	120
	5-5 S-5	WESTRINGIA BLUE GEM BLUE GEM COAST ROSEMARY	5 <i>G</i> AL.	3'-6" O.C.	NOT LISTED	٦	68
*	5-6	ROSMARINUS OFFICINALIS 'TUSCAN BLUE' UPRIGHT ROSEMARY	5 <i>G</i> AL.	4'-0" O.C.	YES	<b>∨</b> L	דד
	<b>5-</b> 7	ELAEAGNUS PUNGENS SILVERBERRY	5 <i>G</i> AL.	4'-0" O.C.	NOT LISTED	٦	38
	5-8	BIOSWALE SOIL MEDIA / DETENTION BASIN PLANTING - MUHLENBERGIA CAPILLARIS	I GAL	3'-6" O.C.	YES	Y	247
_ = =	_	MULCH - SYMBOL SHOWN FOR REFERENCE IN MULCH ONLY AREAS		ALL SHRUB AREAS TO RECEIVE MULCH		-	-

### NOTES:

- I. FOR GENERAL PLANTING NOTES AND PLANTING DETAILS SEE SHEET L-6.01. 2. ALL PLANTING AND IRRIGATION SHALL ABIDE BY THE RANCHO SANTIAGO COMMUNITY COLLEGE DISTRICT FACILITY DESIGN
- STANDARDS AND PLANTING AND IRRIGATION SPECIFICATIONS. 3. SEE CIVIL ENGINEER'S PLANS FOR DEMOLITION AND PROTECT IN PLACE ITEMS.
- 4. ALL TREES TO BE LOCATED A MINIMUM OF 15' FEET AWAY FROM ALL VERTICAL ELEMENTS INCLUDING; BUILDINGS, ROOF LINES / CANOPIES, FENCES, WALLS, ETC.
- 5. ALL TREES TO BE LOCATED A MINIMUM OF 10' FEET AWAY FROM ALL EXISTING AND PROPOSED UNDERGROUND UTILITIES. 6. ALL TREE LOCATIONS SHALL BE STAKED PRIOR TO PLANTING FOR REVIEW AND APPROVAL BY DISTRICT REPRESENTATIVE.
- 7. ALL PLANT MATERIAL (SHRUBS, GROUNDCOVERS) SHALL BE PLANTED MINIMUM 18" AWAY FROM BUILDINGS, WALLS, FENCES, ETC. AREA SHALL BE MULCHED ONLY.
- 8. ALL SHRUB AND GROUNDCOVER AREAS TO RECEIVE 4" MULCH LAYER PER DISTRICT FACILITY DESIGN STANDARDS AND
- DETAILS. 9. ALL TREES SHALL NOT HAVE BRANCHES OR LIMBS LOWER THAN 80" WHERE ADJACENT TO PUBLIC WALKWAYS OR
- SIDEWALKS. CONTRACTOR SHALL LOCATE PROPOSED TREES PRIOR TO PLANTING FOR REVIEW AND APPROVAL BY COLLEGE AND DISTRICT. IF LIMBS INTERFERE WITH 80" CLEARANCE A CERTIFIED ARBORIST SHALL REVIEW PROPOSED PRUNING PRIOR TO LIMBS OR BRANCHES BEING CUT AS TO NOT COMPROMISE THE HEALTH OR STRUCTURE OF THE TREE. IO. ALL TREES LOCATED WITHIN 8' OF ANY HARDSCAPE ELEMENTS (SIDEWALKS, WALLS, D.G., PAVERS, CURBS, ETC.) SHALL RECEIVE

BARRIERS SHALL BE MINIMUM 24" DEEP BY 8' LONG PER TREE. SEE DISTRICT FACILITY DESIGN STANDARDS AND DETAILS. 

ROOT BARRIERS, ROOT BARRIER MODEL #:UB 24-2 UNIVERSAL BARRIER" BY "DEEP ROOT," CONTACT: (714) 898-0863, ROOT

APPROVED DIV. OF THE STATE ARCHITECT

REVIEWED FOR SS 🗹 FLS 🗌 ACS 🗌

COLLEGE IMPROVEMENTS

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APP: 04-121029 INC:

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**REVISIONS:** DESCRIPTION 01/03/2023 ADDENDUM 2

**DATE ISSUED:** 2018-11-19 PROJECT NO: 2018-40167 DSA APPLICATION NO: 04-121029 As indicated

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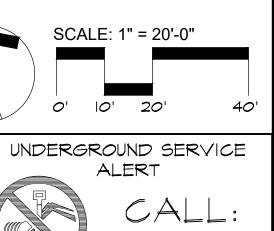
**NUMBER:** SHEET TITLE:

LANDSCAPE **PLANTING PLAN** 



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BEFORE YOU DIG

TWO WORKING DAYS

REMOVE ALL NURSERY STAKES FROM ROOTBALL

LODGE POLE TREE STAKES SHALL BE PLUMB OR ANGLED SLIGHTLY OUTWARD AFTER TREE TIES ARE IN PLACE, AS SHOWN.

DO NOT PLANT TREES WITHIN 10' OF SEWER WATER LINES OR 15' WITHIN ALL OTHER UTILITY LINES. NOTIFY THE DISTRICT OF ANY FIELD CONDITION DISCREPANCIES.

SEE IRRIGATION PLANS AND DETAILS FOR TREE BUBBLER SPECS AND DETAILS

LEGEND: (I) TREE, CENTER IN PIT.

(2) 2" DIAMETER, 10' FT TREATED LODGE POLE PINE TREE STAKES PER TREE, PER SPECIFICATIONS LIGHT 10' ET L'ENGTH CTAILER À TREE, PER SPECIFICATIONS USE 10' FT LENGTH STAKES AT ALL 15 GAL. AND 24" BOX TREES, TYP. KEEP CLEAR OF ROOTBALL. REMOVE TOP OF STAKE TO 4" BELOW LOWEST BRANCH. SET STAKES PARALLEL TO PREVAILING

SECTION

3 4" DEEP TEMPORARY WATERING BASIN BERM AT EDGE OF ROOTBALL REMOVE AT END OF PLANT ESTABLISHMENT PERIOD. TOPDRESS WITH 2" DEEP MULCH LAYER PER DISTRICT STANDARDS. KEEP 3" AWAY FROM ROOT

4 FINISH GRADE WITH 4" BARK MULCH LAYER SURROUND TREES, SHRUBS AND GROUNDCOVERS PER DISTRICT SPECIFICATIONS

5 AMENDED BACKFILL PER SPECIFICATIONS. NATIVE BACKFILL SHALL BE FREE OF CLODS IN EXCESS OF 2" IN DIAMETER.

PLANT TABLET PER SPECIFICATIONS FOR QUANTITY AND PLACEMENT.

2 SETS OF 2 V.I.T. TWIST BRACE (TB24/TB36) TREE TIES BY STRONGBOX (800) 729-1314. INSTALL USING 2-1/2" GALV. SCREWS. NO WIRE CONNECTIONS

SET TOP OF ROOTBALL / CROWN I"-2" ABOVE SURROUNDING GRADE AND SLOPE FOR DRAINAGE


SCARIFY SIDES AND BOTTOM OF PLANTING PIT. SIDES OF PIT TO BE

NATIVE UNDISTURBED SOIL.

(I) FILTER FABRIC WRAPPED 4" DIA. BY 2' LONG PERFORATED PIPE W/CAP FILL W/PEA GRAVEL. SET TOP OF CAP HEIGHT 3" ABOVE FINISHED GRADE. INSTALL AT NON-TURF AREAS ONLY.

@ ROOT BARRIERS, INSTALL ADJACENT TO ANY HARDSCAPE ELEMENTS WITHIN 8' OF PLANT PIT. MODEL # PER PLANTING NOTES AND SPECIFICATIONS

6 TREE PLANTING ON SLOPE (24" BOX OR SMALLER)

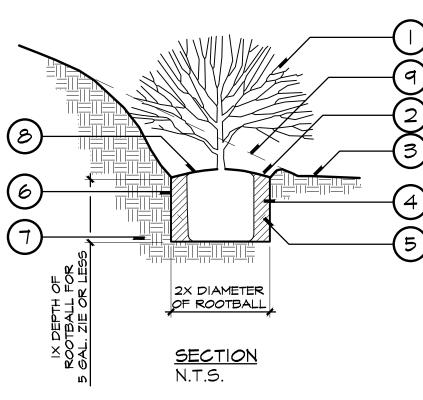

O SHRUB, CENTER IN PIT.

2"-3" DEEP WATERING BASIN BERM AT EDGE OF ROOTBALL. MAINTAIN IN THIS POSITION FOR FIRST 60-90 DAYS AFTER PLANTING. WIDEN BASIN TO PLANT PIT AFTER 60-90 DAYS AS SHOWN. TOPDRESS WITH 2" DEEP MULCH LAYER PER DISTRICT STANDARDS. KEEP 3" AWAY FROM

ROOT CROWN. 3 FINISH GRADE WITH 4" BARK MULCH LAYER SURROUND TREES, SHRUBS AND GROUNDCOVERS PER DISTRICT SPECIFICATIONS.

\_\_\_\_\_ 4) AMENDED BACKFILL PER SPECIFICATIONS.

(5) PLANTING TABLETS PER SPECIFICATIONS FOR QUANTITY

6 SCARIFY SIDES AND BOTTOM OF PLANTING PIT. SIDES OF PIT TO BE VERTICAL


(7) NATIVE UNDISTURBED SOIL.

(S) SET TOP OF ROOTBALL/ CROWN 1-2" ABOVE SURROUNDING FINISH GRADE AND SLOPE FOR DRAINAGE.

9 FINISH GRADE BEYOND.

× 1 × 1111 \ 11 × 1

(A) TEMPORARY WATERING BASIN TO BE INSTALLED IF IRRIGATION SYSTEM IS NOT OPERATIVE AT THE TIME

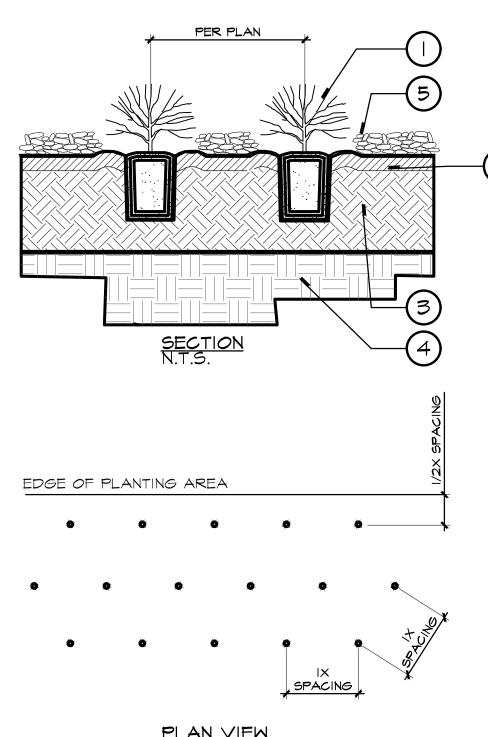

(I) GROUNDCOVER FROM FLAT, CUTTING, LINER, OR PLANTING CONTAINER WITH TRIANGULAR SPACING


(2) 2" LAYER OF HUMUS TOP DRESSING INSTALLED BEFORE PLANTING AT GROUNDCOVER AREAS PER DISTRICT SPECIFICATIONS.

(3) PLANTING BED DEPTH PER SPECIFICATIONS.

4 NATIVE UNDISTURBED SOIL.

(5) 4" LAYER OF BARK MULCH SURROUNDING SHRUBS AND GROUNDCOVER PER DISTRICT SPECIFICATIONS.

### 2 GROUNDCOVER PLANTING

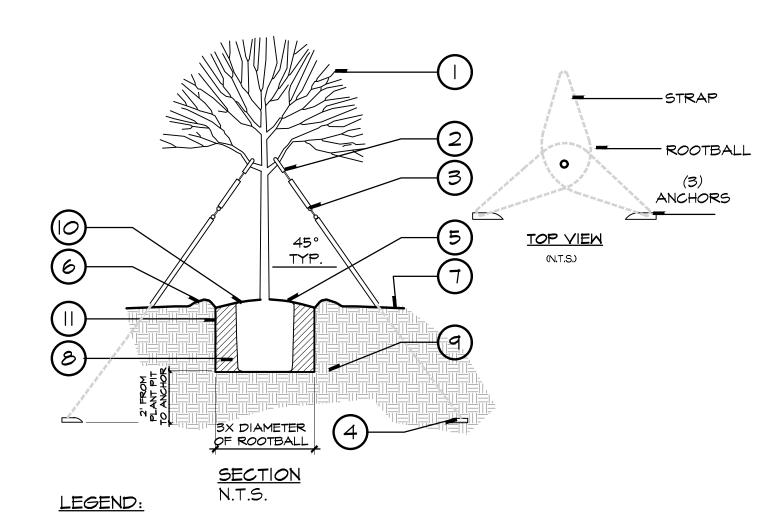

TREE, CENTER IN PIT

2 3/8" DIA. HOSE, SNUG AROUND TRUNK WITH CABLE CLAMPS

(3) MIN. - 1/8" DIA. GALV. CABLE WITH TURNBUCKLE SECURED TO DUCKBILL ANCHOR SET. INSTALL 1/2' DIA. BLACK POLY TUBING ON CABLES. SPACE CABLES EQUALLY AROUND TREE TRUNK

(4) DUCKBILL ROOTBALL ANCHOR KIT , SPECIFY LARGE 88RBK KIT" TYPICAL OR APPROVED EQUAL. EACH KIT INCLUDES: (3) DUCKBILLS, (21 FT) 3/16" TENSION CABLE, (1) RATCHET TENSION STRAP.INSTALL ROOTBALL ANCHOR KIT PER MANUFACTURER'S RECOMMENDATIONS.

2" DEEP LAYER OF SHREDDED BARK MULCH AROUND TREE. SEE SPECIFICATIONS AND DISTRICT STANDARDS.

TIGHTLY COMPACTED 3" BERM TO FORM WATERING BASIN.

MO FINISH GRADE WITH 4" BARK MULCH LAYER SURROUND TREES, SHRUBS AND GROUNDCOVERS PER DISTRICT SPECIFICATIONS. 

AMENDED BACKFILL PER SPECIFICATIONS. NATIVE BACKFILL SHALL BE FREE OF CLODS IN EXCESS OF 2" IN DIAMETER.

NATIVE UNDISTURBED SOIL.

SET TOP OF ROOTBALL / CROWN I"-2" ABOVE SURROUNDING GRADE AND SLOPE FOR DRAINAGE.

SIDES OF PIT TO BE VERTICAL

SCARIFY SIDES AND BOTTOM OF PLANTING PIT.

(A) DISTRICT INSPECTION AND APPROVAL: ALL TREES THAT REQUIRE ROOT BALL ANCHORS SHALL BE INSPECTED AND APPROVED BY DISTRICT PRIOR TO BACKFILLING. ANY TREE INSTALLED WITHOUT PRIOR INSPECTION WILL BE SUBJECT TO REMOVAL AND REPLACEMENT AT NO COST TO THE

REMOVE ALL NURSERY STAKES

DISTRICT.

O DO NOT PLANT TRESS WITHIN 10' OF SEWER WATER LINES OR 15' WITHIN ALL OTHER UTILITY LINES. NOTIFY LANDSCAPE ARCHITECT OF ANY FIELD

DISCREPANCIES.

SEE IRRIGATION PLANS AND DETAILS FOR TREE BUBBLE SPECS AND DETAILS. A REMOVE ALL NURSERY STAKES FROM ROOTBALL

4 SHRUB PLANTING ON SLOPE

B LODGE POLE TREE STAKES SHALL BE PLUMB OR ANGLED SLIGHTLY OUTWARD AFTER TREE TIES ARE IN PLACE, AS SHOWN.

DO NOT PLANT TREES WITHIN 10' OF SEWER WATER LINES. OR 15' WITHIN ALL OTHER UTILITY LINES. NOTIFY DISTRICT OF ANY FIELD CONDITION DISCREPANCIES.

SEE IRRIGATION PLANS AND DETAILS FOR TREE BUBBLER SPECS AND DETAILS

(I) TREE, CENTER IN PIT.

3X DIAMETER

OF ROOTBALL

SECTION

(2) 2" DIAMETER, 10' FT, TREATED LODGE POLE PINE TREE STAKES PER TREE, PER SPECIFICATIONS. USE 10' FT LENGTH STAKES AT ALL 15 GAL AND 24" BOX TREES, TYP. KEEP CLEAR OF ROOTBALL. REMOVE TOP OF STAKE TO 4" BELOW LOWEST BRANCH. SET STAKES PERPENDICULAR TO PREVAILING WINDS.

3 4" DEEP TEMPORARY WATERING BASIN BERM AT EDGE OF ROOTBALL REMOVE AT END OF PLANT ESTABLISHMENT PERIOD. TOPDRESS WITH 2' DEEP MULCH LAYER PER DISTRICT STANDARDS. KEEP 3" AWAY FROM ROOT CROWN.

4 FINISH GRADE WITH 4" BARK MULCH LAYER SURROUNDING TREES, SHRUBS AND GROUNDCOVERS PER DISTRICT SPECIFICATIONS

5 AMENDED BACKFILL PER SPECIFICATIONS. NATIVE BACKFILL SHALL BE

FREE OF CLODS IN EXCESS OF 2" IN DIAMETER.

6 PLANT TABLET PER SPECIFICATIONS FOR QUANTITY AND PLACEMENT.

(7) (2) SETS OF 2 V.I.T. TWIST BRACE (TB24/TB36) TREE TIES BY STRONGBOX (800) 729-1314. INSTALL USING 2-1/2" GALV. SCREWS. NO WIRE CONNECTIONS ALLOWED.

SET TOP OF ROOTBALL / CROWN I"-2" MAX ABOVE SURROUNDING GRADE AND SLOPE FOR DRAINAGE.

9 SCARIFY SIDES AND BOTTOM OF PLANTING PIT. SIDES OF PIT TO BE VERTICAL

NATIVE UNDISTURBED SOIL.

 $\textcircled{\ }$  FILTER FABRIC WRAPPED 4" DIA. BY 2' LONG PERFORATED PIPE W/CAP FILL W/PEA GRAVEL. SET TOP OF CAP HEIGHT 3" ABOVE FINISHED GRADE. INSTALL AT NON-TURF AREAS ONLY.

@ ROOT BARRIERS, INSTALL ADJACENT TO ANY HARDSCAPE ELEMENTS WITHIN 8' OF PLANT PIT. SEE PLANTING NOTES AND SPECIFICATIONS

() SHRUB, CENTER IN PIT.

2"-3" DEEP WATERING BASIN BERM AT EDGE OF ROOTBALL. MAINTAIN IN THIS POSITION FOR FIRST 60-90 DAYS AFTER PLANTING. WIDEN BASIN TO PLANT PIT AFTER 60-90 DAYS AS SHOWN. TOPDRESS WITH 2" DEEP MULCH LAYER PER DISTRICT STANDARDS. KEEF 3" AWAY FROM ROOT CROWN.


3 FINISH GRADE WITH 4" BARK MULCH LAYER PER DISTRICT SPECIFICATIONS.

6 SCARIFY SIDES AND BOTTOM OF PLANTING PIT. SIDES OF PIT TO BE VERTICAL.

7 NATIVE UNDISTURBED SOIL

DRAINAGE.


(A) TEMPORARY WATERING BASIN TO BE INSTALLED

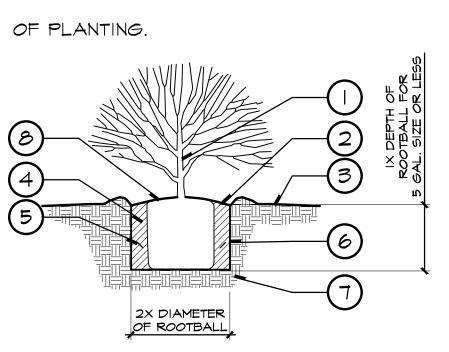


IF IRRIGATION SYSTEM IS NOT OPERATIVE AT THE

AS SHOWN.

5 PLANTING TABLETS PER SPECIFICATIONS FOR QUANTITY AND PLACEMENT.

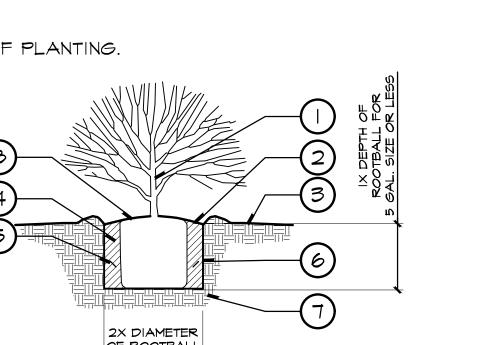

SURROUNDING FINISH GRADE AND SLOPE FOR NOTES:

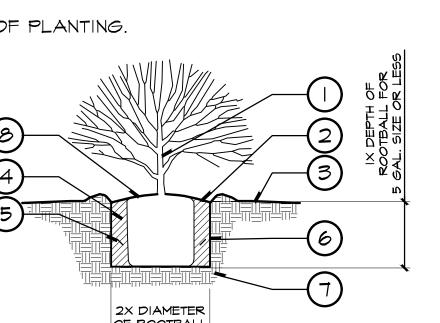

(4) AMENDED BACKFILL PER SPECIFICATIONS.

SET TOP OF ROOTBALL / CROWN 1-2" ABOVE

TIME OF PLANTING.

AND DISEASE FREE. IT IS THE CONTRACTOR'S OBLIGATION TO WARRANTY ALL PLANT MATERIALS PER THE SPECIFICATIONS

LANDSCÁPE ARCHITECT.

PLANTING NOTES

MATERIALS.

APPROVAL OF THE DISTRICT.

ONTRACTOR SHALL BE RESPONSIBLE FOR MAKING HIM/HERSELF FAMILIAR WITH ALL UNDERGROUND UTILITIES, PIPELINES AND STRUCTURES. CONTRACTOR SHALL TAKE SOLE RESPONSIBILITY FOR ANY COST INCURRED DUE TO DAMAGE OF SAID UTILITIES. CONTRACTOR SHALL CALL UNDERGROUND SERVICE DIG ALERT (2) FULL WORKING DAYS BEFORE COMMENCING ANY DIGGING. PHONE SII FOR U.S.A

(1) ALL TREES WITHIN A SPECIES SHALL HAVE MATCHING & UNIFORM FORM.

4 ALL PLANT MATERIAL SHALL BE APPROVED BY THE DISTRICT PRIOR TO

3 REFER TO PLANTING SPECIFICATIONS FOR SOIL PREPARATION,

5 FINAL LOCATION OF ALL PLANT MATERIALS SHALL BE SUBJECT TO THE

6 CONTRACTOR SHALL NOTIFY THE DISTRICT 48 HOURS PRIOR TO COMMENCEMENT OF WORK TO COORDINATE PROJECT INSPECTION

9 SEE DETAILS AND SPECIFICATIONS FOR STAKING METHOD, PLANT PIT DIMENSIONS AND BACKFILL REQUIREMENTS.

(CONTRACTOR TO

G CONTRACTOR SHALL SUBMIT TO THE DISTRICT FOR APPROVAL, PHOTOS OF

CONTACT DISTRICT AND LANDSCAPE ARCHITECT FOR RESOLUTION. FAILURE

TO MAKE SUCH CONFLICTS KNOWN TO THE DISTRICT AND LANDSCAPE

ARCHITECT WILL RESULT IN CONTRACTOR'S LIABILITY TO RELOCATE THE

ALL BOXED TREES. PHOTOS SHOULD INCLUDE A PERSON FOR SCALE

PURPOSES. ALL BOX TREES SHALL BE OF QUALITY AS DETERMINED BY THE

DISTRICT AND LANDSCAPE ARCHITECT. MATERIAL FOUND UNSUITABLE FOR

THE DESIGN OR SPECIFICATION INTENT WILL BE REJECTED. THE CONTRACTOR SHALL ALSO SUBMIT WRITTEN SPECIFICATIONS FOR ALL

PLANT MATERIAL SPECIFIED ON THIS PROJECT PRIOR TO PLACING ORDER. FAILURE TO DO SO COULD RESULT IN THE REPLACEMENT (AT CONTRACTOR'S

EXPENSE) OF ANY PLANTS DETERMINED UNACCEPTABLE BY DISTRICT AND

IT IS THE CONTRACTOR'S RESPONSIBILITY TO FURNISH PLANT MATERIALS

FREE OF PESTS OR PLANT DISEASES. PRE-SELECTED OR 'TAGGED'

MATERIAL MUST BE INSPECTED BY THE CONTRACTOR AND CERTIFIED PEST

FERTILIZATION, MULCHING, AND OTHER ADDITIONAL PLANTING INFORMATION.

2 ALL LANDSCAPED AREAS TO RECEIVE AUTOMATED IRRIGATION.

(2) CONTRACTOR SHALL NOT PROCEED WITH CONSTRUCTION AS DESIGNED WHEN IS OBVIOUS THAT UNKNOWN OBSTRUCTIONS AND/OR GRADE DIFFERENCES EXIST THAT MAY NOT HAVE BEEN KNOWN DURING DESIGN. SUCH CONDITIONS SHALL BE IMMEDIATELY BROUGHT TO THE ATTENTION OF THE DISTRICT. THE CONTRACTOR SHALL ASSUME FULL RESPONSIBILITY FOR ALL NECESSARY REVISIONS DUE TO FAILURE TO GIVE SUCH NOTIFICATION.

(3) CONTRACTOR SHALL BE RESPONSIBLE FOR ANY COORDINATION WITH SUBCONTRACTORS AND CONSTRUCTION MANAGER AS REQUIRED TO ACCOMPLISH PLANTING OPERATIONS.

LANDSCAPE CONTRACTOR TO RECEIVE SITE GRADED TO +0.10. CONTRACTOR SHALL OBTAIN LETTER OF GRADE CERTIFICATION FROM DISTRICT PRIOR TO PROJECT EXECUTION.

(5) PLANT MATERIAL QUANTITIES ARE GIVEN FOR CONVENIENCE ONLY. PLANT SYMBOLS AND SPECIFIED SPACING SHALL TAKE PRECEDENCE. CONTRACTOR SHALL VERIFY PLANT MATERIAL QUANTITIES PER PLAN. 6 CONTRACTOR TO ASSURE POSITIVE DRAINAGE IN ALL PLANTING AREAS

2% MINIMUM ALLOWED. TO AFTER ROUGH GRADES HAVE BEEN ESTABLISHED IN PLANTING AREAS CONTRACTOR SHALL HAVE SOIL SAMPLES TAKEN AT THE LOCATIONS INDICATED BY DESIGNATION (3 TOTAL). CONTRACTOR SHALL INFORM SOIL TESTING LAB OF THE PLANT MATERIAL SPECIFIED IN SOIL TESTING LOCATIONS (NATIVE TREES & SHRUBS, ORNAMENTAL TREES & SHRUBS, PALM TREES, BERMUDA SOD, ETC.) SO THAT APPROPRIATE PLANTING RECOMMENDATIONS CAN BE GIVEN. THESE SAMPLES SHALL BE TESTED BY SUMMIT TURF AND HORTICULTURE CONSULTANTS, OR APPROVED EQUAL CONTACT: JASON GIHRING (951) 258-7937 FOR SOIL AGRICULTURAL SUITABILITY TEST AND RECOMMENDATIONS .. TWO SAMPLES SHALL BE TAKEN AT EACH LOCATION (I) GROUND LEVEL TO 10" DEEP, (2) 24" TO 36" DEEP. EACH SAMPLE SHAL CONTAIN APPROXIMATELY I QUART OF SOIL AND BE LABELED PER LOCATION AND DEPTH. CONTRACTOR SHALL INSTALL SOIL PREPARATION AND BACKFILL MIX TO CONFORM TO THESE RECOMMENDATIONS ONLY UPON

RECEIPT OF WRITTEN CHANGE ORDER FROM DISTRICT. REPORT TO DISTRICT'S ENGINEER PRIOR TO PLANTING. (B) GROUND COVERS AND SHRUBS SHALL BE TRIANGULARLY SPACED, UNLESS

OTHERWISE INDICATED. ALL SOIL FOR LANDSCAPE PLANTING AREAS OR BERMS SHALL OBTAINED FROM ON-SITE EXCAVATIONS. SHOULD IMPORT SOIL BE NECESSARY, INDICATE SOURCE LOCATION. SEE PROJECT GEOTECHNICAL REPORT. SOIL SHALL BE SANDY LOAM CONTAINING NO TOXIC CHEMICALS OR ELEMENTS WHICH MAY INHIBIT OR RETARD NORMAL PLANT GROWTH SOIL TESTING RESULTS SHALL BE SUBMITTED AND APPROVED PRIOR TO

@ ALL LANDSCAPED AREAS (EXCLUDING TURF) SHALL BE MULCHED WITH A 4" LAYER OF SHREDDED BARK MULCH, O"-4" IN SIZE, PER SPECIFICATIONS, AT THE CONCLUSION OF PLANTING OPERATIONS. 2) AT EDGES OF PLANTING AREAS, THE CENTER LINE OF THE LAST ROW OF

SHRUBS AND/OR GROUND COVER SHALL BE LOCATED NO FARTHER FROM

OR CLOSER TO THE EDGE THAN ONE-HALF THE SPECIFIED ON-CENTER

2 REMOVE ALL NURSERY STAKES AND ESPALIER RACKS IMMEDIATELY AFTER INSTALLATION, UPON PROVIDING SUPPORT PER DETAILS, THIS SHEET.

(3) ALL TREES PLANTED WITHIN 8' OF ANY HARDSCAPE ELEMENTS (SIDEWALKS

WALLS, D.G., PAYERS, CURBS, ETC.) SHALL RECEIVE ROOT BARRIERS. ROOT BARRIER MODEL #:UB 24-2 UNIVERSAL BARRIER" BY "DEEP ROOT CONTACT: (714) 898-0863. ROOT BARRIERS SHALL BE MINIMUM 24" DEEP BY 8' LONG PER TREE. SEE DISTRICT STANDARD SPECIFICATIONS ALL MULCH AREAS ON SLOPES TO RECEIVE POLY JUTE NETTING. MODEL

814312 AND ANCHOR STAKES MODEL #: 00042579500581 BY DEWITT CO

65 CONTRACTOR SHALL BE RESPONSIBLE FOR MAINTAINING PROTECTION OF EXISTING SHRUB AND TURF AREAS TO REMAIN DURING CONSTRUCTION. DAMAGED SHRUB AND TURF AREAS SHALL BE REPAIRED OR REPLACED AT THE CONTRACTOR'S EXPENSE

OR APPROVED EQUAL. PER DISTRICT STANDARD SPECIFICATIONS.

THE WORK INDICATED ON THE DRAWINGS HAS BEEN COMPLETED, INSPECTED, & APPROVED BY THE CLIENT REPRESENTATIVE AREAS WITHIN THE PROJECT BOUNDARY ARE TO BE MAINTAINED FOR A PERIOD OF 90 CALENDAR DAYS, PER PLANTING SPECIFICATION SECTION 32 90 00, PART 4.2, MAINTENANCE PERIOD.

ALL SHRUBS & OTHER PLANT MATERIALS SHALL BE GUARANTEED FOR A PERIOD OF 90 CALENDAR DAYS. ALL GUARANTEE PERIODS COMMENCE FROM THE TIME OF FINAL ACCEPTANCE BY THE CLIENT REPRESENTATIVE AT THE COMPLETION OF THE 90 CALENDAR DAY MAINTENANCE PERIOD PER PLANTING SPECIFICATION SECTION 32 90 00, PART 1.2, GUARANTEE

ALL PLANTING AREAS SHALL RECEIVE WEED-CONTROL BARRIERS. COMPOSITE FABRIC MIRAFI 140N OR DISTRICT APPROVED EQUAL.

> UNDERGROUND SERVICE ALERT CALL 8 TWO WORKING DAYS BEFORE YOU DIG

APPROVED DIV. OF THE STATE ARCHITEC APP: 04-121029 INC: REVIEWED FOR SS ✓ FLS ☐ ACS ☐ DATE: 01/04/2023

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**Z** ≥ **∢ A A I** SOL | 12/22/2022 | Date

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**REVISIONS: DESCRIPTION** DATE ADDENDUM 2

**DATE ISSUED:** 2018-11-19 PROJECT NO: 2018-40167 **DSA APPLICATION NO:** 04-121029 As indicated

L-6.01

**SHEET TITLE:** LANDSCAPE **PLANTING DETAILS** 

SHEET

**NUMBER:** 



REUSED, OR MODIFIED WITHOUT THE WRITTEN CONSEN

OF RJM DESIGN GROUP, INC. © 2022 RJM Design Group,

TREE GUYING (48" BOX AND LARGER)

5 TREE PLANTING (24" BOX OR SMALLER) | 3 SHRUB PLANTING

SOIL IMPLEMENTATION.

PLANTING NOTES

Inc. All rights reserved.

### **GENERAL NOTES:**

- 1. ELECTRICAL ENGINEERING FOR THIS PROJECT IS BASED ON EXISTING DRAWINGS AND A FIELD VISIT OF THE ELECTRICAL SYSTEM. IN CASE OF ANY DISCREPANCIES WITH EXISTING FIELD CONDITIONS, ELECTRICAL CONTRACTOR SHALL VERIFY THE EXACT DIFFERENCES AND NOTIFY THE ELECTRICAL ENGINEER FOR POSSIBLE REVISION TO THESE DOCUMENTS.
- 2. MAINTAIN CONTINUITY OF ALL ELECTRICAL SYSTEMS, EQUIPMENT, ETC. REMAINING IN OPERATION.

### RECONSTRUCTION NOTES:

- 1 EXISTING SECURITY CAMERA TO REMAIN AND BE PROTECTED IN PLACE.
- 2 NEW LOCATION OF RELOCATED CAMERA. EXTEND CONDUIT AND WIRING TO MATCH EXISTING.
- 3 NEW LOCATION OF RELOCATED PULL BOX. MATCH EXISTING CONDUIT AND WIRING. PULL BOX TO BE AS CLOSE TO THE CURB TO AVOID BIOFILTRATION AREA.
- NEW MUTIL-IMAGER CAMERAS TO BE INSTALL ON NEW AREA LIGHT. EXTEND NEW WIRING TO MATCH EXISTING WIRING. PROVIDE NEW DATA WIRING FROM BUILDING D. REFER TO CAMERA FIELD OF VIEW SHEET FOR IMAGER TUNING. SEE E-102 FOR LIGHTING LOCATION. SEE E-501 FOR POLE MOUNTED CAMERA DETAIL.

DIV. OF THE STATE ARCHITEC APP: 04-121029 INC: REVIEWED FOR SS ☑ FLS ☐ ACS ☐

**REVISIONS:** DESCRIPTION
ADDENDUM 2


DATE ISSUED: 2018-11-19 PROJECT NO: **DSA APPLICATION NO:** 04-121029

E-103

SHEET TITLE:

SHEET NUMBER:

**RECONSTRUCTION** SECURITY PLAN

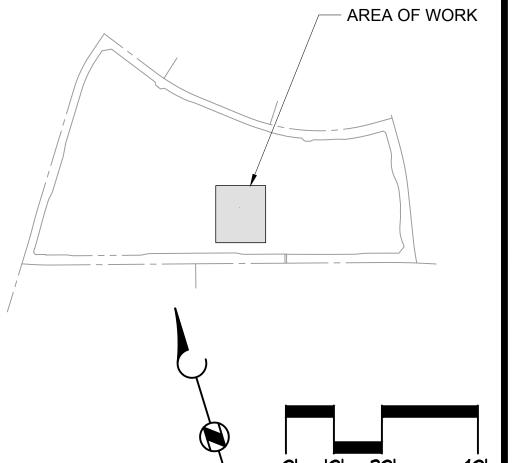



RECONSTRUCTION SECURITY PLAN

SCALE


1" = 20'-0"

0' 10' 20'

KEY PLAN SCALE
N.T.S.

255 East Rincon St., Suite 301 Corona, CA 92879 P 951.340.1977 | F 951.340.1090 FILE NO.: 120-06-04

G GOSS ENGINEERING

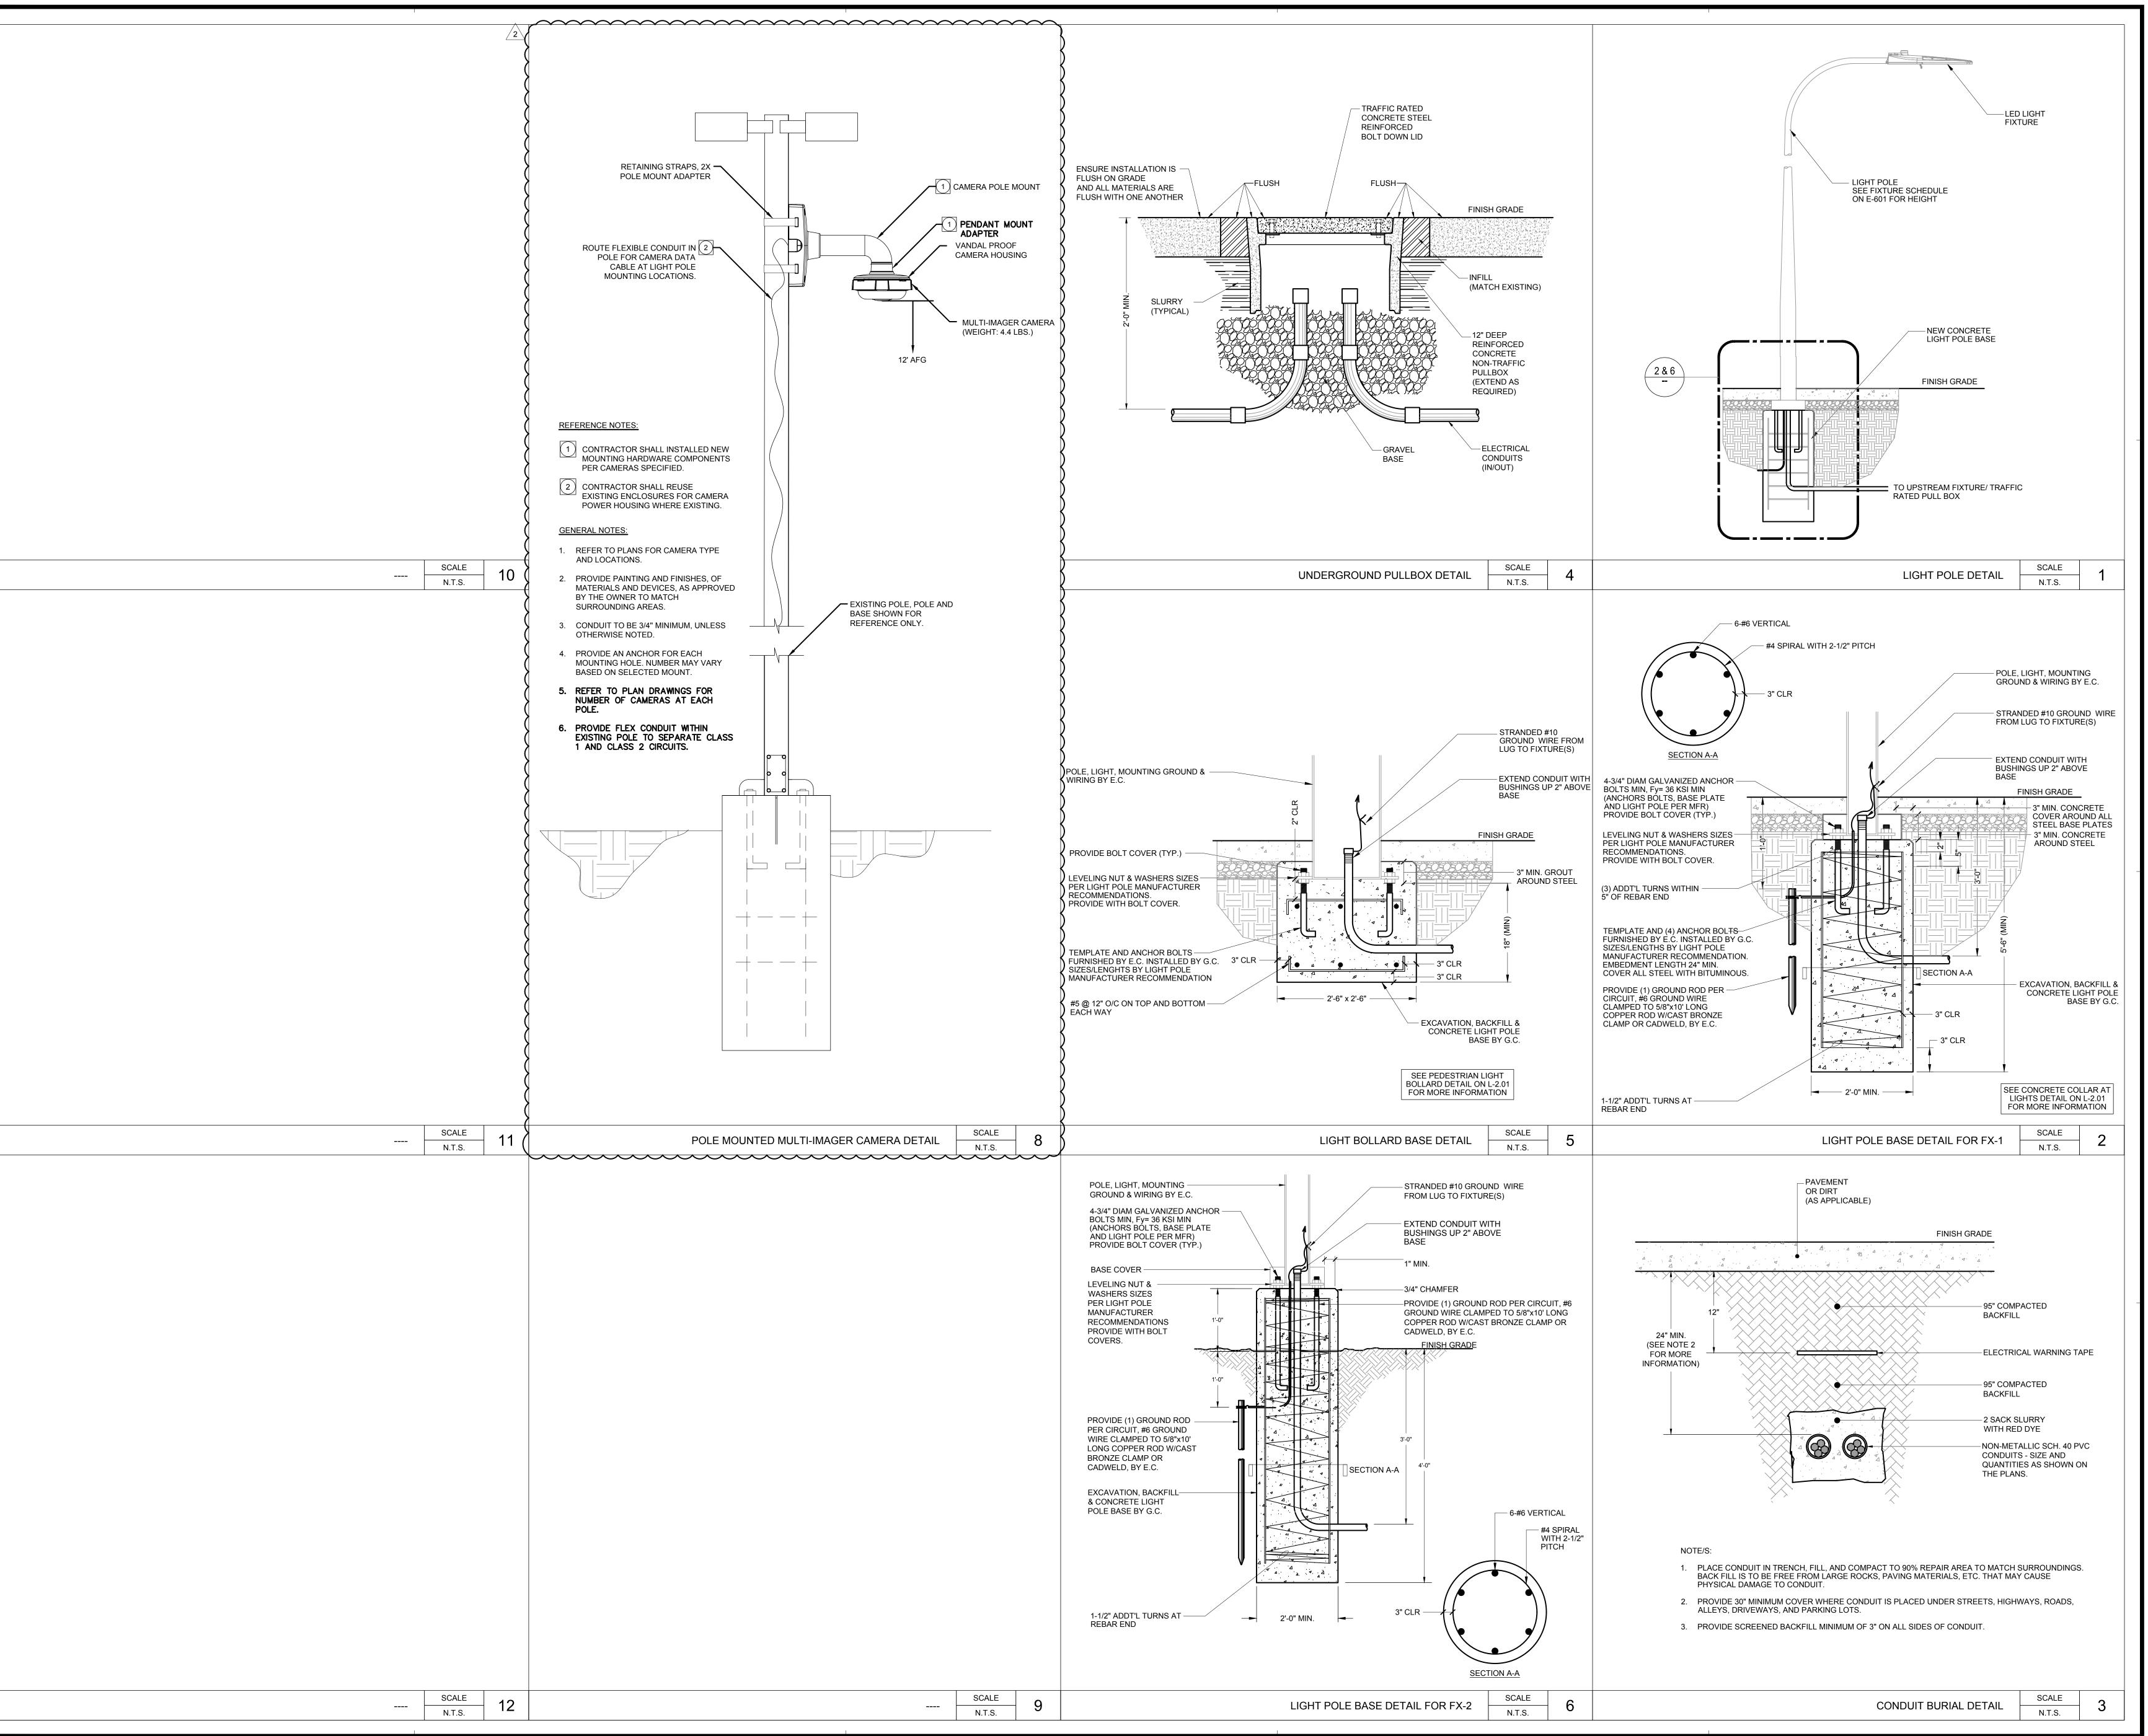

APPROVED
DIV. OF THE STATE ARCHITECT

APP: 04-121029 INC:

REVIEWED FOR
SS FLS ACS

DATE: 01/04/2023

RANCHO SANTIAGO COMMUNITY COLLEGE DISTRICT

REVISIONS:

DESCRIPTION

ADDENDUM 2

01/03/

REVISIONS:

DESCRIPTION

ADDENDUM 2

O1/03/2023

DATE ISSUED: 2018-11-19
PROJECT NO: 2018-40167

DSA APPLICATION NO: 04-121029

SCALE: As indicated

SHEET
NUMBER: E-501

SHEET TITLE:

**DETAILS** 

G GOSS

255 East Rincon St., Suite 301 Corona, CA 92879 P 951.340.1977 | F 951.340.1090 FILE NO.: 120-06-04

### **SECTION 01 32 13**

### CONSTRUCTION SCHEDULE

### PART 1 - GENERAL

### 1.01 SECTION INCLUDES

A. Required procedures, preparation, submittals, reviews, updates, and revisions to the construction schedule.

### 1.02 RELATED SECTIONS

- A. Division 0.
- B. Section 01 11 00: Summary of Work.
- C. Section 01 12 16: Phasing of the Work.
- D. Section 01 29 73: Schedule of Values Procedures.
- E. Section 01 29 76: Progress Payment Procedures.
- F. Section 01 31 13: Project Coordination.
- G. Section 01 33 00: Submittal Procedures.
- H. Section 01 45 23: Testing and Inspection.
- I. Section 01 50 00: Construction Facilities and Temporary Controls.
- J. Section 01 78 36: Warranty Procedures.

### PART 2 - PRODUCTS

### 2.01 SCHEDULING SOFTWARE

A. Contractor shall utilize Primavera Project Planner<sup>TM</sup> for Windows® (P6) software (latest version) by Primavera Systems, Inc., Microsoft Project, or equivalent scheduling software to employ the Critical Path Method (CPM) in the development and maintenance of the construction schedule network using the Precedence Diagram Mode (PDM). The scheduling software shall be capable of being resource loaded with manpower and materials. It shall also be capable of generating time-scaled logic diagrams, resource histograms and profiles, bar charts, layouts and reports with any and/or all activity detail.

### PART 3 - EXECUTION

### 3.01 SUBMITTALS

B. Contractor shall retain a construction scheduler to work in enough capacity to perform all of the requirements outlined in this Section. Scheduler shall have a minimum of five (5) years' experience. The Scheduler shall be able to plan, coordinate, execute, and monitor a CPM schedule as required for this Project. Contractor will assign a Scheduler to: Develop the baseline schedule; update the schedule on a monthly basis, provide a Status Report of updated activities semi-monthly; submit Progress Schedule files monthly that reflect all revisions and updates corresponding to payment estimate periods; prepare and submit four-weeks look-ahead schedule weekly; and coordinate with the Contractor's Project Manager, Superintendent throughout the duration of the construction of the Project on schedule issues. Scheduler will cooperate with District Representative and shall be available on site for monitoring, maintaining and updating schedules in a timely manner. District

Representative has the right to refuse to accept the Scheduler based upon a lack of experience as required by this Section or based on lack of performance and timeliness of schedule submittals and of fragments on past projects. If District Representative does not accept the proposed Scheduler, Contractor shall within one (1) week of disapproval, propose another scheduler who meets the experience requirements stated above.

- C. Contractor shall submit two originals and three copies of all bar charts, reports and/or other required schedule data as outlined in this Section. Contractor shall electronically deliver the schedule file in its original format at the time of submittal (PDF and XER file formats).
- D. Contractor shall submit the Preliminary Construction Schedule within ten (10) calendar days after Notice to Proceed.
- E. Contractor shall submit the Proposed Baseline Schedule within fifteen (15) calendar days after Notice to Proceed.
- F. Contractor shall submit the Monthly Schedule Updates, Four-Week Rolling Schedules, and Recovery Schedules as required.

### 3.02 PRELIMINARY CONSTRUCTION SCHEDULE

- Contractor shall develop and submit a Preliminary Construction Schedule as required by this A. Section. It shall be submitted in computer generated network format and shall be organized by Activity Codes representing the Contractor's intended sequencing of the Work. The Preliminary Construction Schedule shall include activities for the first 90 calendar days following the NTP such as mobilization, preparation of submittals, specified review periods, procurement items, fabrication items, milestones, and detailed construction activities.
- B. Upon District Representative's acceptance of the Preliminary Construction Schedule, Contractor shall update the accepted Preliminary Construction Schedule each month (beginning with month 1) and submit these updates until Contractor's Baseline Schedule is fully developed and accepted. Since updates to Preliminary Construction Schedule are the basis for payment to Contractor during the first three-month period, submittal and acceptance of such updates shall be a condition precedent to making of monthly payment, as referenced in General Conditions.
- C. Provide a written narrative describing Contractor's approach to mobilization, procurement, and construction during the first ninety (90) calendar days including crew sizes, equipment and material delivery, site access, submittals, and permits.
- D. Submit Bar Charts, Tabular Reports, Electronic Data, and Plots in accordance with this Section.

### 3.03 BASELINE SCHEDULE CPM NETWORK

- Within fifteen (15) calendar days of the Notice to Proceed, Contractor shall submit a detailed A. Proposed Baseline Schedule that covers the entire duration of the Project. This schedule shall convey Contractor's plan for organizing, managing, and executing the Work.
- B. The Proposed Baseline Schedule shall include activity descriptions, sequencing, logic relationships, duration estimates, by CSI section, resource loading, and other information as set forth in this Section.
  - 1. The Proposed Baseline Schedule shall include all Phases stipulated in Specification Section 01 12 16, the General Conditions, as well as all activities required to achieve timely completion of the Milestones.
  - 2. The Proposed Baseline Schedule shall include activities for: all construction activities, the NTP, Milestones, submittals, coordination drawings, re-submittals, procurement of materials and equipment, manufacturing, fabrication & delivery, owner furnished contractor installed items (OFCI), access restrictions, work restrictions, phased occupancy, testing, start-up, and contract closeout activities. The Proposed Baseline Schedule shall allow a period for District Representative and Architect to review each submittal, as

required by Section 01 33 00 and other sections which require additional time for District Representative reviews and deferred submittal reviews by Division of State Architect (DSA).

- 3. The Proposed Baseline Schedule shall include start and completion dates for: temporary facilities, construction of mock-ups, prototypes, samples, punch list, District Representative interfaces and furnishing of items, separate work contracts, regulatory agency approvals, and permits required for performance of the Work.
- 4. The Proposed Baseline Schedule shall allow for all foreseeable factors and risks which affect performance of the Work. Include allowances for weather conditions, applicable laws, transportation, traffic, air quality, noise, or any other applicable regulatory requirements, regulations or collective bargaining agreements pertaining to labor.
- 5. Contractor shall not use any float suppression techniques such as preferential sequencing or logic, special lead/lag constraints or unjustifiable over-estimating of activity durations in preparing the Proposed Baseline Schedule except that "Finish No Later Than" constraints are permitted for Milestones. No "Zero Free Float" constraints, No "Early" Constraints, and No "Mandatory Finish" constraints shall be utilized.
- 6. The Proposed Baseline Schedule shall include activity durations based on the crew sizes and equipment utilization that Contractor will maintain during the Project. No activity durations shall exceed fifteen (15) working days unless approved by the District Representative. Non-construction activities such as procurement, delivery, or submittal activities are exempted.
- 7. Contractor shall include with the Proposed Baseline Schedule a written narrative report sufficiently comprehensive to explain the rationale behind Contractor's approach to the Work including but not limited to: activity durations, manpower flow, average crew sizes, equipment requirements, production rates, constraints, holidays and other non-work days, potential problem areas, permits, coordination with regulatory authorities, utilities, separate work contracts and other parties, and long lead delivery items requiring more than thirty (30) days from the date of order to delivery to the Project site.
- C. At the District Representative's request, furnish a detailed written explanation of Contractor's basis for specific durations, logic, phasing, or other information. Such an explanation shall include Contractor's rationale for selecting the number of crews, crew composition, number of shifts per day, number of hours in a shift, number of work days per week, construction equipment, and similar factors.
- D. The Proposed Baseline Schedule activities shall contain the following data:
  - Activity ID numbers shall consist of no more than eight alphanumeric characters.
     Following District Representative acceptance of the Baseline Schedule, Activity ID numbers shall not be changed.
  - 2. Activity Descriptions shall provide adequate information that readily identifies each activity, work scope, and location.
  - 3. Activity codes specified in Section 3.03.G shall be applied to each activity.
- E. At District Representative's request, furnish a written explanation for each lead or lag relationship and each constrained date. Unjustifiable leads, lags, and constraints may result in District Representative's rejection of the Proposed Baseline Schedule.
- F. Calendar Identification: In the scheduling software, identify all activities that will require overtime shifts, double shifts, and work on weekends or holidays. Identify non-work days and holidays in the schedule calendar. All milestones stipulated in Specification Section 01 12 16, Phasing of the Work shall be placed on a calendar with seven days per week. No holiday or non-work day restrictions are permitted on this calendar.

G. Activity Codes: As a minimum, the Activity Codes shown in Table 1 below shall be assigned to each activity.

Table 1

Name	Length	<u>Description</u>
TYPE	2	Type of activity (for example: mobilization, submittals, procurement/fabrication, construction, milestones, etcetera.)
AREA	2	Area or Building (for example: Bldg A, Building B, Courtyard, Athletic Fields, Street Work, etcetera.)
STAG	2	Stage (for example: Foundations, Superstructure, Exterior, Interior, Roof, Floor Number etcetera.)
SBST	2	Substage (a specific area within a stage such as: main electrical room, kitchen, room number, etcetera.)
RESP	7	Responsible Party (subcontractor and/or trade)
SPEC	5	CSI section number

- District Representative may require additional coding of activities. The mandatory activity
  code requirements listed in Table 1 are not to be construed as setting limits on Contractor's
  management and coordination responsibilities, but are intended to guide Contractor in the
  administration of its contractual responsibilities.
- H. Milestones are designated dates in which Work or portions thereof are required to start and complete in accordance with the Contract Documents.
  - 1. Where the term completion or similar terms are used in regards to a Milestone, it shall be construed to mean all portions of the Work in the indicated phase, area, and zone are complete and acceptable to District Representative. Where the term starts or similar terms are used in the designation of a Milestone, it shall be construed to mean a portion of the Work in the indicated phase, area, or zone is required to be commenced.
  - 2. A Proposed Baseline Schedule extending beyond the Milestones or Contract Time will not be acceptable.
  - 3. Finish Milestones shall be constrained with Late Finish (Finish No Later Than) type constraints in accordance with the dates stipulated in Specification Section 01 12 16, Phasing of the Work, Appendix A.
  - 4. In the scheduling software, in the "Project Overview" menu, assign the "Project Must Finish By" date to match the Substantial Completion and Contract Completion Milestone dates stipulated in Specification Section 01 12 16, Phasing of the Work.
  - A Proposed Baseline Schedule indicating Work completed in less time than the Milestones and/or Contract Time will not be acceptable. Rather, Contractor shall show any unused contract time as float.
  - 6. Milestones shall be placed on a calendar with seven days per week. No Holiday or non-workday restrictions are permitted on this calendar.

- I. The Critical Path shall be clearly indicated on all schedules submitted. An activity is defined as critical when its Total Float is less than or equal to zero (0) days.
- J. Contractor shall allow Float time for Inclement Weather, Government Delay, and Free Float in the Baseline Schedule in accordance with the General Conditions.
- K. Contractor shall submit computer generated reports and plots with the Proposed Baseline Schedule submittal package. Format shall display the following columns: Activity ID, Activity Description, Original Duration, Remaining Duration, Percent Complete, Early Start, Early Finish, Late Start, Late Finish, and Total Float. Unless otherwise noted, bar charts and reports shall be on 11 inch by 17 inch paper and bound.
  - 1. Bar charts shall be generated separately for:
    - a. Milestones only.
    - b. Activities sorted by Early Start date and organized by Project, Area, Stage, and Substage. (The network shall show continuous flow of all activities from left to right).
    - c. Activities sorted by Responsibility.
    - d. Summary level of all activities sorted by craft/trade and area.
  - 2. Tabular Reports:
    - a. Total Float sorted low to high
    - b. Predecessors and Successors sorted by Activity ID.
  - 3. Electronic data: Provide an electronic file in its original format of the Proposed Baseline Schedule. The electronic P6 files shall be saved in ".XER" and/or ".XML" type format.
  - 4. Plots: Produce a color bar chart on E-size paper (30-inch by 42-inch) organized (at a minimum) by project, area, stage, and substage.
- L. District Representative will notify Contractor of any adjustments that are required for the Proposed Baseline Schedule to be accepted. Contractor shall perform any required adjustments to the Proposed Baseline Schedule and resubmit it for acceptance certifying in writing that all information contained therein complies with the Contract Documents. District Representative will review the Proposed Baseline Schedule for accuracy, reasonableness, and conformance with the Contract Documents and shall provide comments within ten days of receipt. Within five days after receiving District Representative comments, Contractor shall both incorporate changes to address District Representative concerns and resubmit the Proposed Baseline Schedule for District Representative back-check. This process will continue until the Proposed Baseline Schedule is accepted as the Baseline Schedule. Once accepted by District Representative, the Baseline Schedule will be the basis upon which Contractor shall prepare updates that record and report actual performance and progress. The accepted Baseline Schedule and subsequent Monthly Updates shall be the basis for consideration and analysis of requests for time extensions and Contractor progress payments.
- M. District Representative acceptance of the Baseline Schedule or Contractor's failure to identify or include an element of the Contract, shall not release Contractor's obligation to complete all required Work in accordance with the Contract Documents.

### 3.04 REQUIREMENTS FOR MONTHLY SCHEDULE UPDATING

- A. Once the Baseline Schedule is accepted by District Representative, Contractor shall submit Monthly Schedule Updates beginning with month No. 1. The current month's schedule update cannot be accepted until the previous Monthly Schedule Update has been accepted by District Representative.
- B. Monthly Schedule Update Format

- 1. Initially, the Contractor shall status a current Monthly Schedule Update with actual Work progress only. No logic ties shall be modified. Status all Actual Start and Finish dates, adjust Remaining Durations where needed, and update Percent Completion of activities. If Contractor chooses to modify logic or add activities (other than out-of-sequence corrections) it shall be done in accordance with Section 3.06.
- 2. Once the schedule is status in accordance with Section 3.04.B.1, Contractor shall print (and submit with Monthly Schedule Update) a report of "out-of-sequence" logic that results from the updating process. Contractor shall then correct all "out-of-sequence" logic to reflect Contractor's actual Work sequence.
- 3. During construction, Contractor may desire to break down specific activities into greater detail. If greater detail is necessary, then Contractor shall identify expanded activities such that the Baseline Schedule activities that the expanded activities originated from are readily apparent. Contractor shall not allow the aggregate duration of the expanded activities to exceed the duration assigned to the Baseline Schedule activity unless permitted by District Representative in writing.
- 4. The Data Date for the Monthly Schedule Updates shall be the last day of the month. At a minimum, three days prior to the submission of the Monthly Schedule Update, Contractor shall meet in person with District Representative to present the proposed Percentages of Completion and Actual Start and Actual Finish dates. If the District Representative takes no exceptions to the percentages of completion and actual dates then the Monthly Schedule Update may be implemented.
- 5. Written Narrative Report: Contractor shall include a written report to explain the Monthly Schedule Update. The narrative shall, at a minimum include the following headings with appropriate discussions of each topic:
  - a. Introduction.
  - b. A Summary of Work which was on-going This Pay Period.
  - c. Problem Areas and Proposed Solutions.
  - d. Critical Path.
  - e. Current and Anticipated Delays.
  - f. Coordination of Work with Others.
  - g. Milestone Status.
  - h. Denote changes in logic and added Fragnets.
  - i. Denote additions/deletions of activities.
- 6. In updating the Schedule, Contractor shall not modify Activity ID numbers, schedule calculation rules/criteria, or the Activity Coding Structure required.
- 7. Submit bar charts, tabular reports, written narrative, electronic data, and plots in accordance with this Section.
- C. Four-Week Rolling Schedule: At each Weekly Progress Meeting, Contractor shall present a Four-Week Schedule in Bar Chart format. It shall show one (1) week of actual and three (3) weeks of forecasted progress. The Four-Week Rolling Schedule shall be used as a basis for discussing progress and work planned during the three (3) weeks.
  - 1. The Four-Week Rolling Schedule shall be based on the most recent District Representative Accepted Monthly Schedule Update. It shall include weekly updates to all construction, submittal, fabrication and procurement, and separate work contract activities. Contractor shall ensure that it accurately reflects the current progress of the Work.
  - 2. Contractor shall discuss actual dates and any variances to critical or near critical activities.

- 3. Upon request by District Representative, Contractor shall provide the Four-Week Rolling Schedule in electronic format.
- 4. If the Four-Week Rolling Schedule indicates activities are behind schedule, Contractor shall provide a Recovery Schedule in accordance with Section 3.05.

### 3.05 RECOVERY SCHEDULES

- A. If a Monthly Schedule Update indicates negative float greater than ten (10) workdays on a critical path as result of events not predicated by the General Conditions Contractor shall prepare a Proposed Recovery Schedule demonstrating Contractor's plan to regain the time lost. The Recovery Schedule shall be submitted either in advance of or concurrent with the Monthly Schedule Update and Contractor progress request. Both the Monthly Schedule Update and the Proposed Recovery Schedule shall be based on the same percentages of completion and actual dates accepted by District Representative under Section 3.05 B.
- B. The Proposed Recovery Schedule shall be based on a copy of the Monthly Schedule Update for the calendar month during which the negative float first appears.
- C. The Proposed Recovery Schedule shall include a narrative that identifies the causes of the negative float on the critical path and provides Contractor's proposed corrective action to ensure timely completion of all Milestones and the Substantial Completion Date. Contractor's corrective actions shall include but are not limited to increasing concurrent operations, increasing labor, adding multiple shifts in a 24-hour period, and adding overtime.
- D. During any period of time when Contractor is found to be behind schedule by District Representative, the Monthly Schedule Update described above shall become a weekly requirement to provide a greater degree of focus on the timely completion of the Work. These Updates shall be submitted to District Representative every Monday morning. When Contractor is deemed by District Representative to be back on schedule, Contractor may revert to submitting the schedule monthly.
- E. Contractor's progress payment may not be processed until District Representative accepts the Proposed Recovery Schedule. Following such an acceptance, the Proposed Recovery Schedule will be known as the Recovery Schedule and future Work will be performed by Contractor in accordance with it.

### 3.06 FRAGNETS AND TIME EXTENSION REQUESTS

- A. Float is not for exclusive use or benefit of either District Representative or Contractor but is an expiring resource available to both parties on a non-discriminatory basis. If required to meet specified Milestones, either party may utilize float. Adjustments to Milestones or Contract Time will only be authorized by Change Order and only to the extent the claimed adjustments exceed total float along the most critical path of the current Monthly Schedule Update in effect at the time of the claimed adjustments. The claimed adjustments to the Milestones and/or Contract Time must also cause the Beneficial Completion Date to exceed that currently indicated in the Monthly Schedule Update. Contractor alleged claimed adjustments to an existing negative float path will not receive consideration until the activity with the highest negative float is driven even further negative.
  - 1. Alleged Claimed adjustments to the Milestones or Contract Time will be administered in conjunction with those set forth in
- B. Pursuant to the float sharing requirements of this Section, the use of float suppression techniques such as preferential sequencing or logic, special lead or lag logic restraints, and extended activity times or durations are prohibited. The use of float time disclosed or implied by the use of alternate float suppression techniques shall be proportionally shared to benefit District Representative and Contractor. The use of any technique solely for the purpose of suppressing float will result District Representative rejection of the submitted Monthly Schedule Update.

- C. In the event Contractor believes the Project has suffered an adverse impact arising from events predicated by the General Conditions, Contractor may prepare a Time Extension Request by submitting a Schedule Fragnet and a written narrative outlining the detail of the impact. A Schedule Fragnet must demonstrate a critical path delay. Such a delay must adversely impact the Substantial Completion Date for Contractor to receive a time extension. To demonstrate such an impact successfully, Contractor shall prepare a Schedule Fragnet based on a copy of District Representative accepted Monthly Schedule Update for the calendar month during which the adverse impact occurred. This "copy" of the District Representative accepted Monthly Schedule Update shall however first be updated (by District Representative and Contractor jointly) with both Percentages of Completion and Actual Dates up to the day the delay commenced. This process will provide the "pre-delay" project status. Once District Representative and Contractor have agreed to the "predelay" project status, Contractor should make a copy of this "pre-delay" schedule and this copy is to be the starting point for Contractor's Schedule Fragnet development. District Representative will evaluate the activities, logic, durations, etcetera, in the Schedule Fragnet and will evaluate if the adverse impact arose from events described by the General Conditions. The Fragnet shall also include Contractor-caused delays that affect the critical or near critical path in the network and should be accounted for in the Time Impact Analysis if overlapped at any point in time with District Representative -caused delay. If rain impact days were granted between the Start and Finish of District Representative -caused delay period, they should be accounted for in the Time Impact Analysis as well. Provided District Representative determines such an impact occurred, Contractor may be due a time extension equal to the number of proportioned days of variance/delay that resulted to the Substantial Completion Date.
- D. Activities added into a Schedule Fragnet to demonstrate the impact of adverse event shall be assigned a unique activity code. The Schedule shall be organized by this unique activity code.
- E. The Schedule Fragnet shall incorporate logic that accurately ties reflective of the adverse event to pre-event predecessor activities and post event successor activities.
- F. The format and components of a Schedule Fragnet submittal shall be in accordance with this Section and the General Conditions. It is crucial for the Fragnet to be submitted within the same month of discovery so it can be resolved during the monthly schedule update review. The notice shall be transmitted to District Representative within the stipulations outlined in the General Conditions.
- G. If District Representative accepts Contractor's Schedule Fragnet and an extension is granted, a Change Order will be prepared. District Representative will advise what change order number the time extension will become. When Contractor receives this Change Order number, all the activities added to the Schedule Fragnet shall be given Activity Identification Numbers that corresponds with the Change Order number. Contractor shall resource-load the activities if required by District Representative. If resource loading is required, the resource loading shall include a breakdown of labor, material, and equipment quantities.
- H. If District Representative rejects Contractor's Schedule Fragnet in part based on improper forecast logic or activity tasks then it shall be revised accordingly to conform to District Representative review comments and resubmitted. If the forecast logic and activity tasks cannot be agreed to then the pre-delay schedule outlined in Section 3.06.C shall be compared to the actual as-built data in the succeeding month of the encountering issue, event, condition, circumstance, and/or cause. The variance to the project between the pre-delay and post-delay schedules shall be discussed in Contractor's written narrative and proportioned between the different parties involved in the delay.
- I. If District Representative rejects Contractor's Schedule Fragnet in whole then Contractor may follow the procedures set forth in the General Conditions.

### 3.07 FAILURE TO COMPLY WITH REQUIREMENTS

A. At any time during the project if Contractor fails to comply with the specified requirements, District Representative reserves the right to engage independent estimating and scheduling consultants to

fulfill these requirements. Upon notice to Contractor, District Representative shall assess against Contractor, incurred costs for these additional services.

- B. In such an event, District Representative will require, and Contractor shall participate and provide requested information to ensure the resulting Milestones Schedule accurately reflects Contractor's plan to execute the Work in compliance with the Contract Documents. If it becomes necessary for District Representative to recommend logic or duration revisions as a result of Contractor failure to furnish acceptable data, and if Contractor has objections to the recommendations, Contractor shall provide notice to District Representative within three (3) days and Contractor shall provide an acceptable alternate plan. If Contractor fails to so note any objections and provide an acceptable alternate plan, or if Contractor implements the recommendations of District Representative without so noting any objections, Contractor will be deemed to have waived all objections and concurred with the recommended logic/duration revisions provided by Architect and/or District Representative
- C. Submittal of any Monthly Schedule Updates are subject to review and acceptance by District Representative. District Representative retains the right, including, but not limited to the General Conditions, to withhold progress payments in whole or part until Contractor submits a Monthly Schedule Update acceptable to District Representative.


### 3. 08 CONTRACTOR RESPONSIBILITY

- A. Nothing in this Section shall be construed to be a usurpation of Contractor authority, responsibility, and obligation to plan and schedule Work as Contractor deems necessary, subject to all other requirements of the Contract Documents.
- B. Contractor shall involve the subcontractors, manufacturers, and suppliers in the development and periodic updating of the schedule.

### 3.09 RECORD DOCUMENTS

A. Prior to Contract Completion of the Work, Contractor shall submit an as-built time-scaled network diagram reflecting the actual dates of all activities.

END OF SECTION 01 32 13

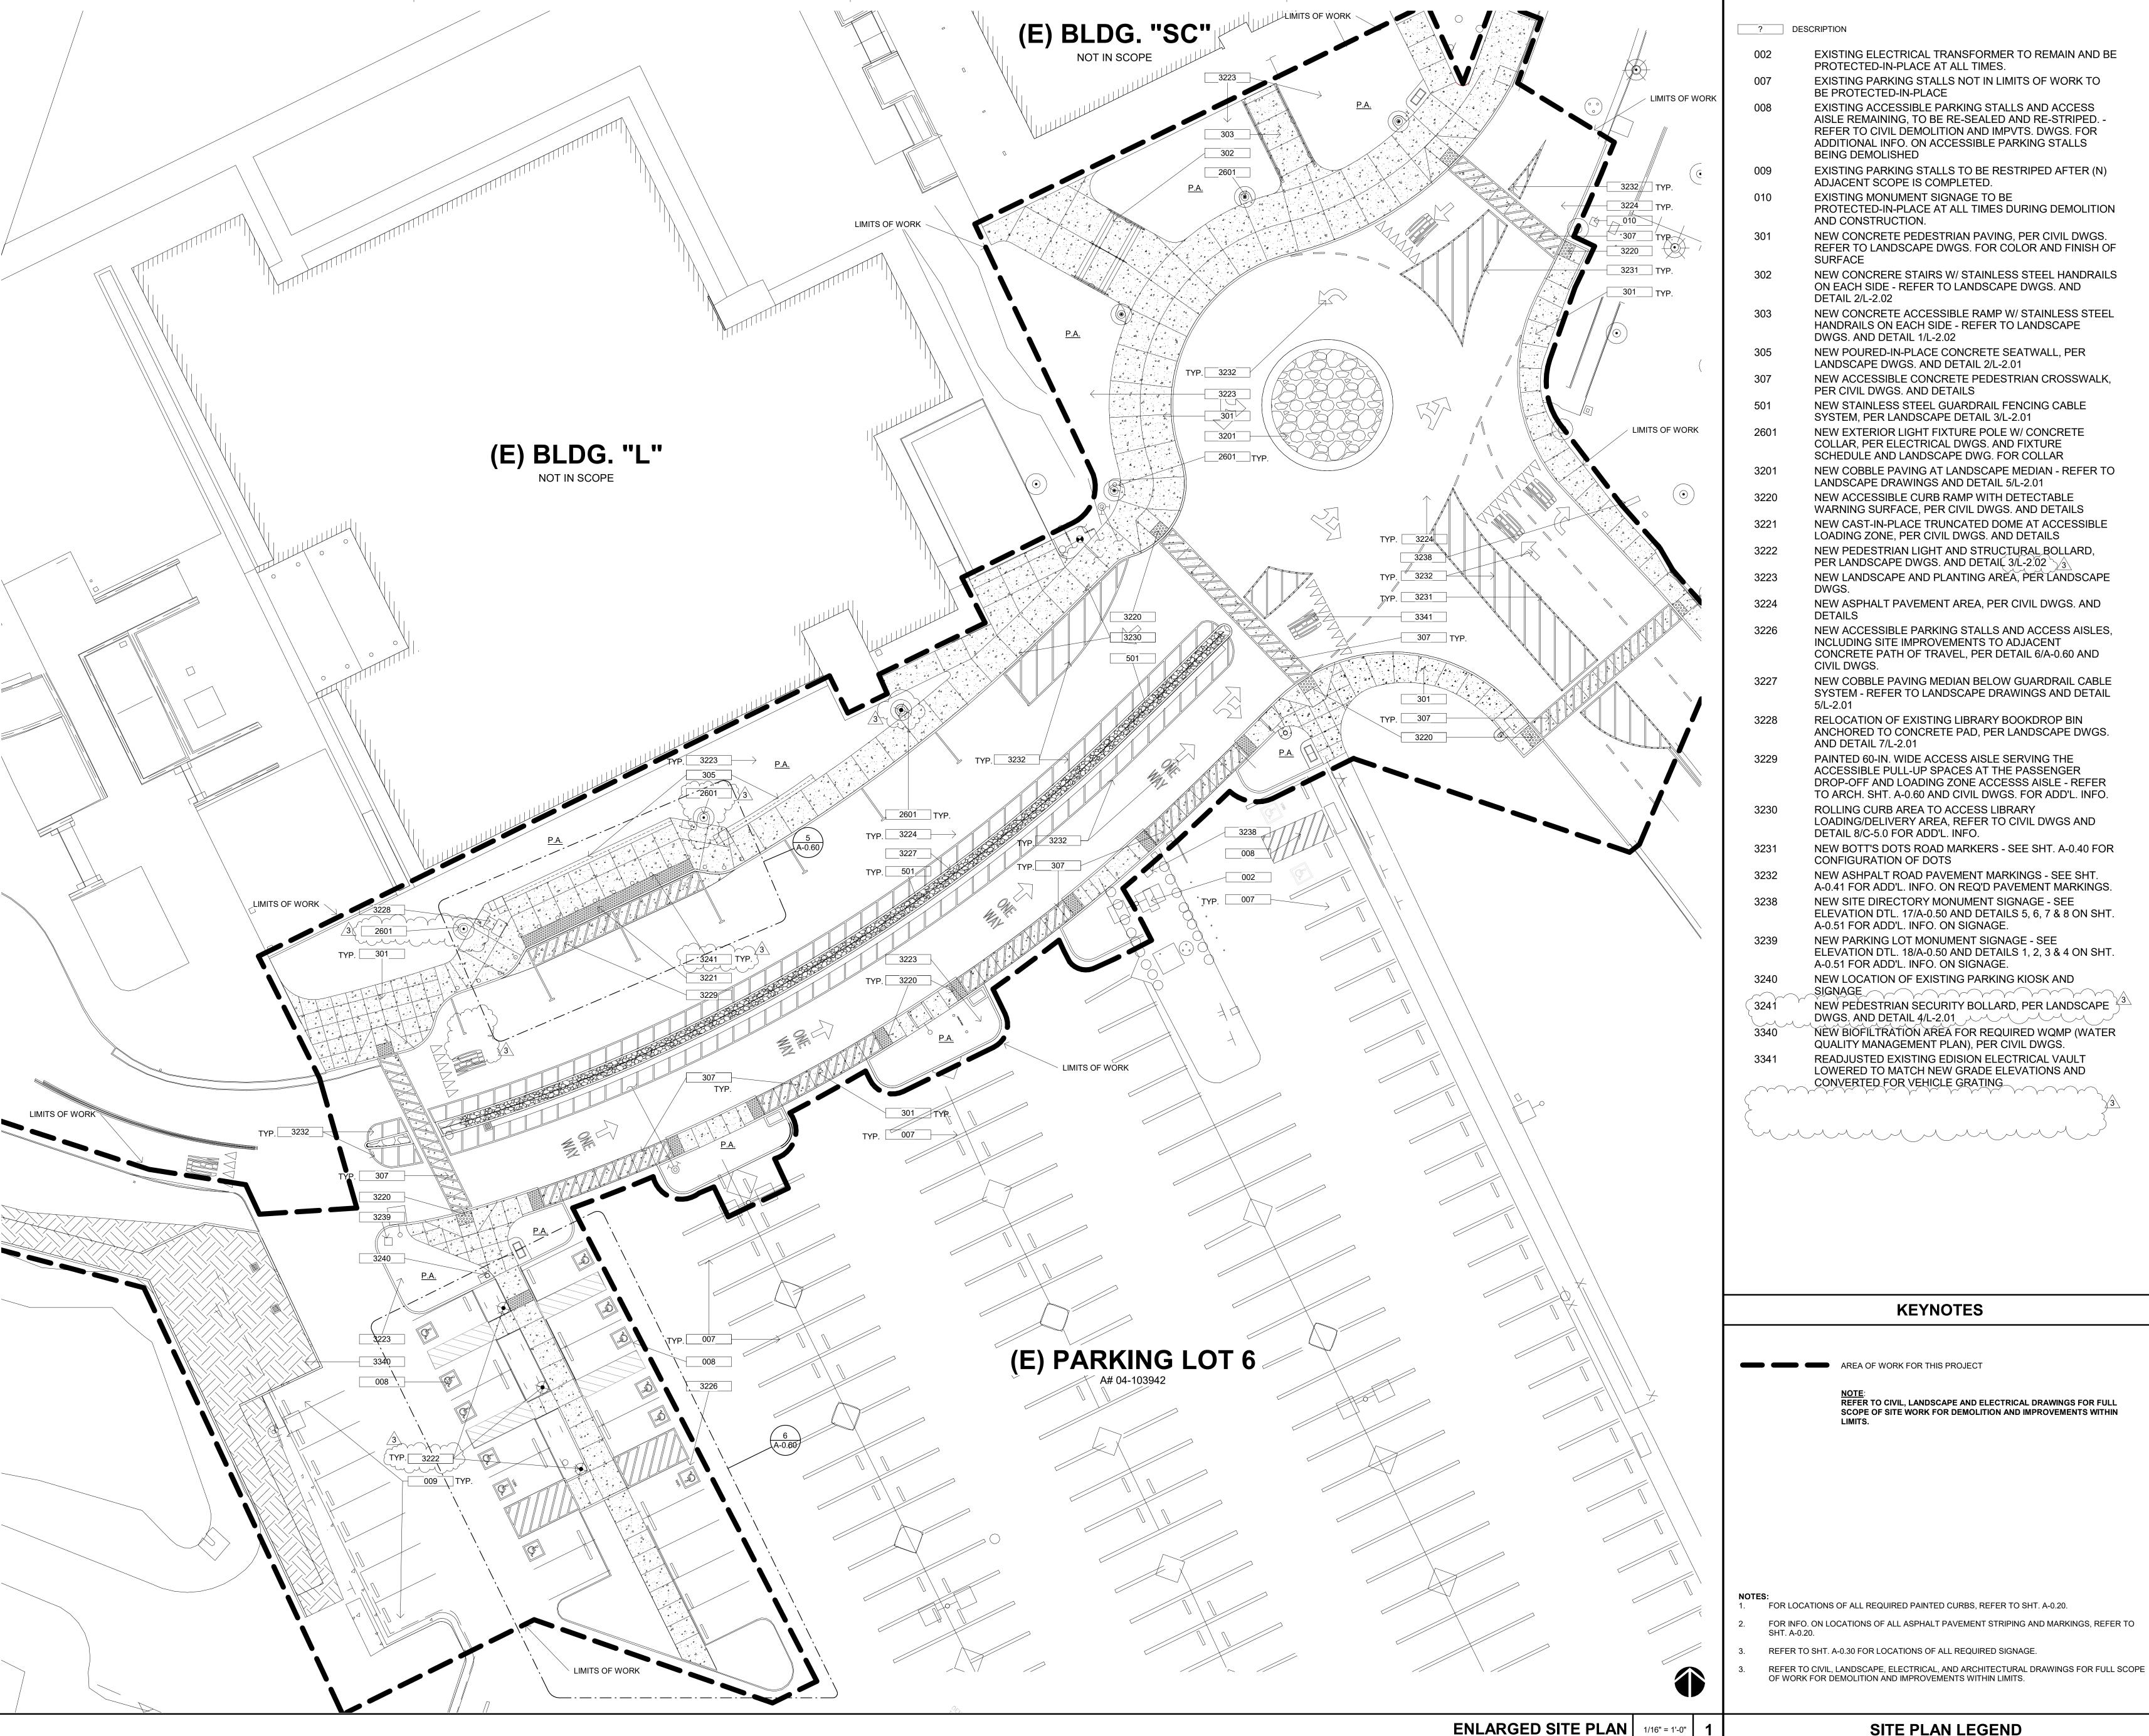

SITE PLAN LEGEND

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**REVISIONS:** DESCRIPTION ADDENDUM 3

DATE 01/16/2023

**DATE ISSUED:** 2018-11-19 PROJECT NO: 2018-40167 **DSA APPLICATION NO:** 04-121029 SCALE: As indicated

SHEET TITLE:

**NUMBER:** 

### **ENLARGED SITE PLAN**


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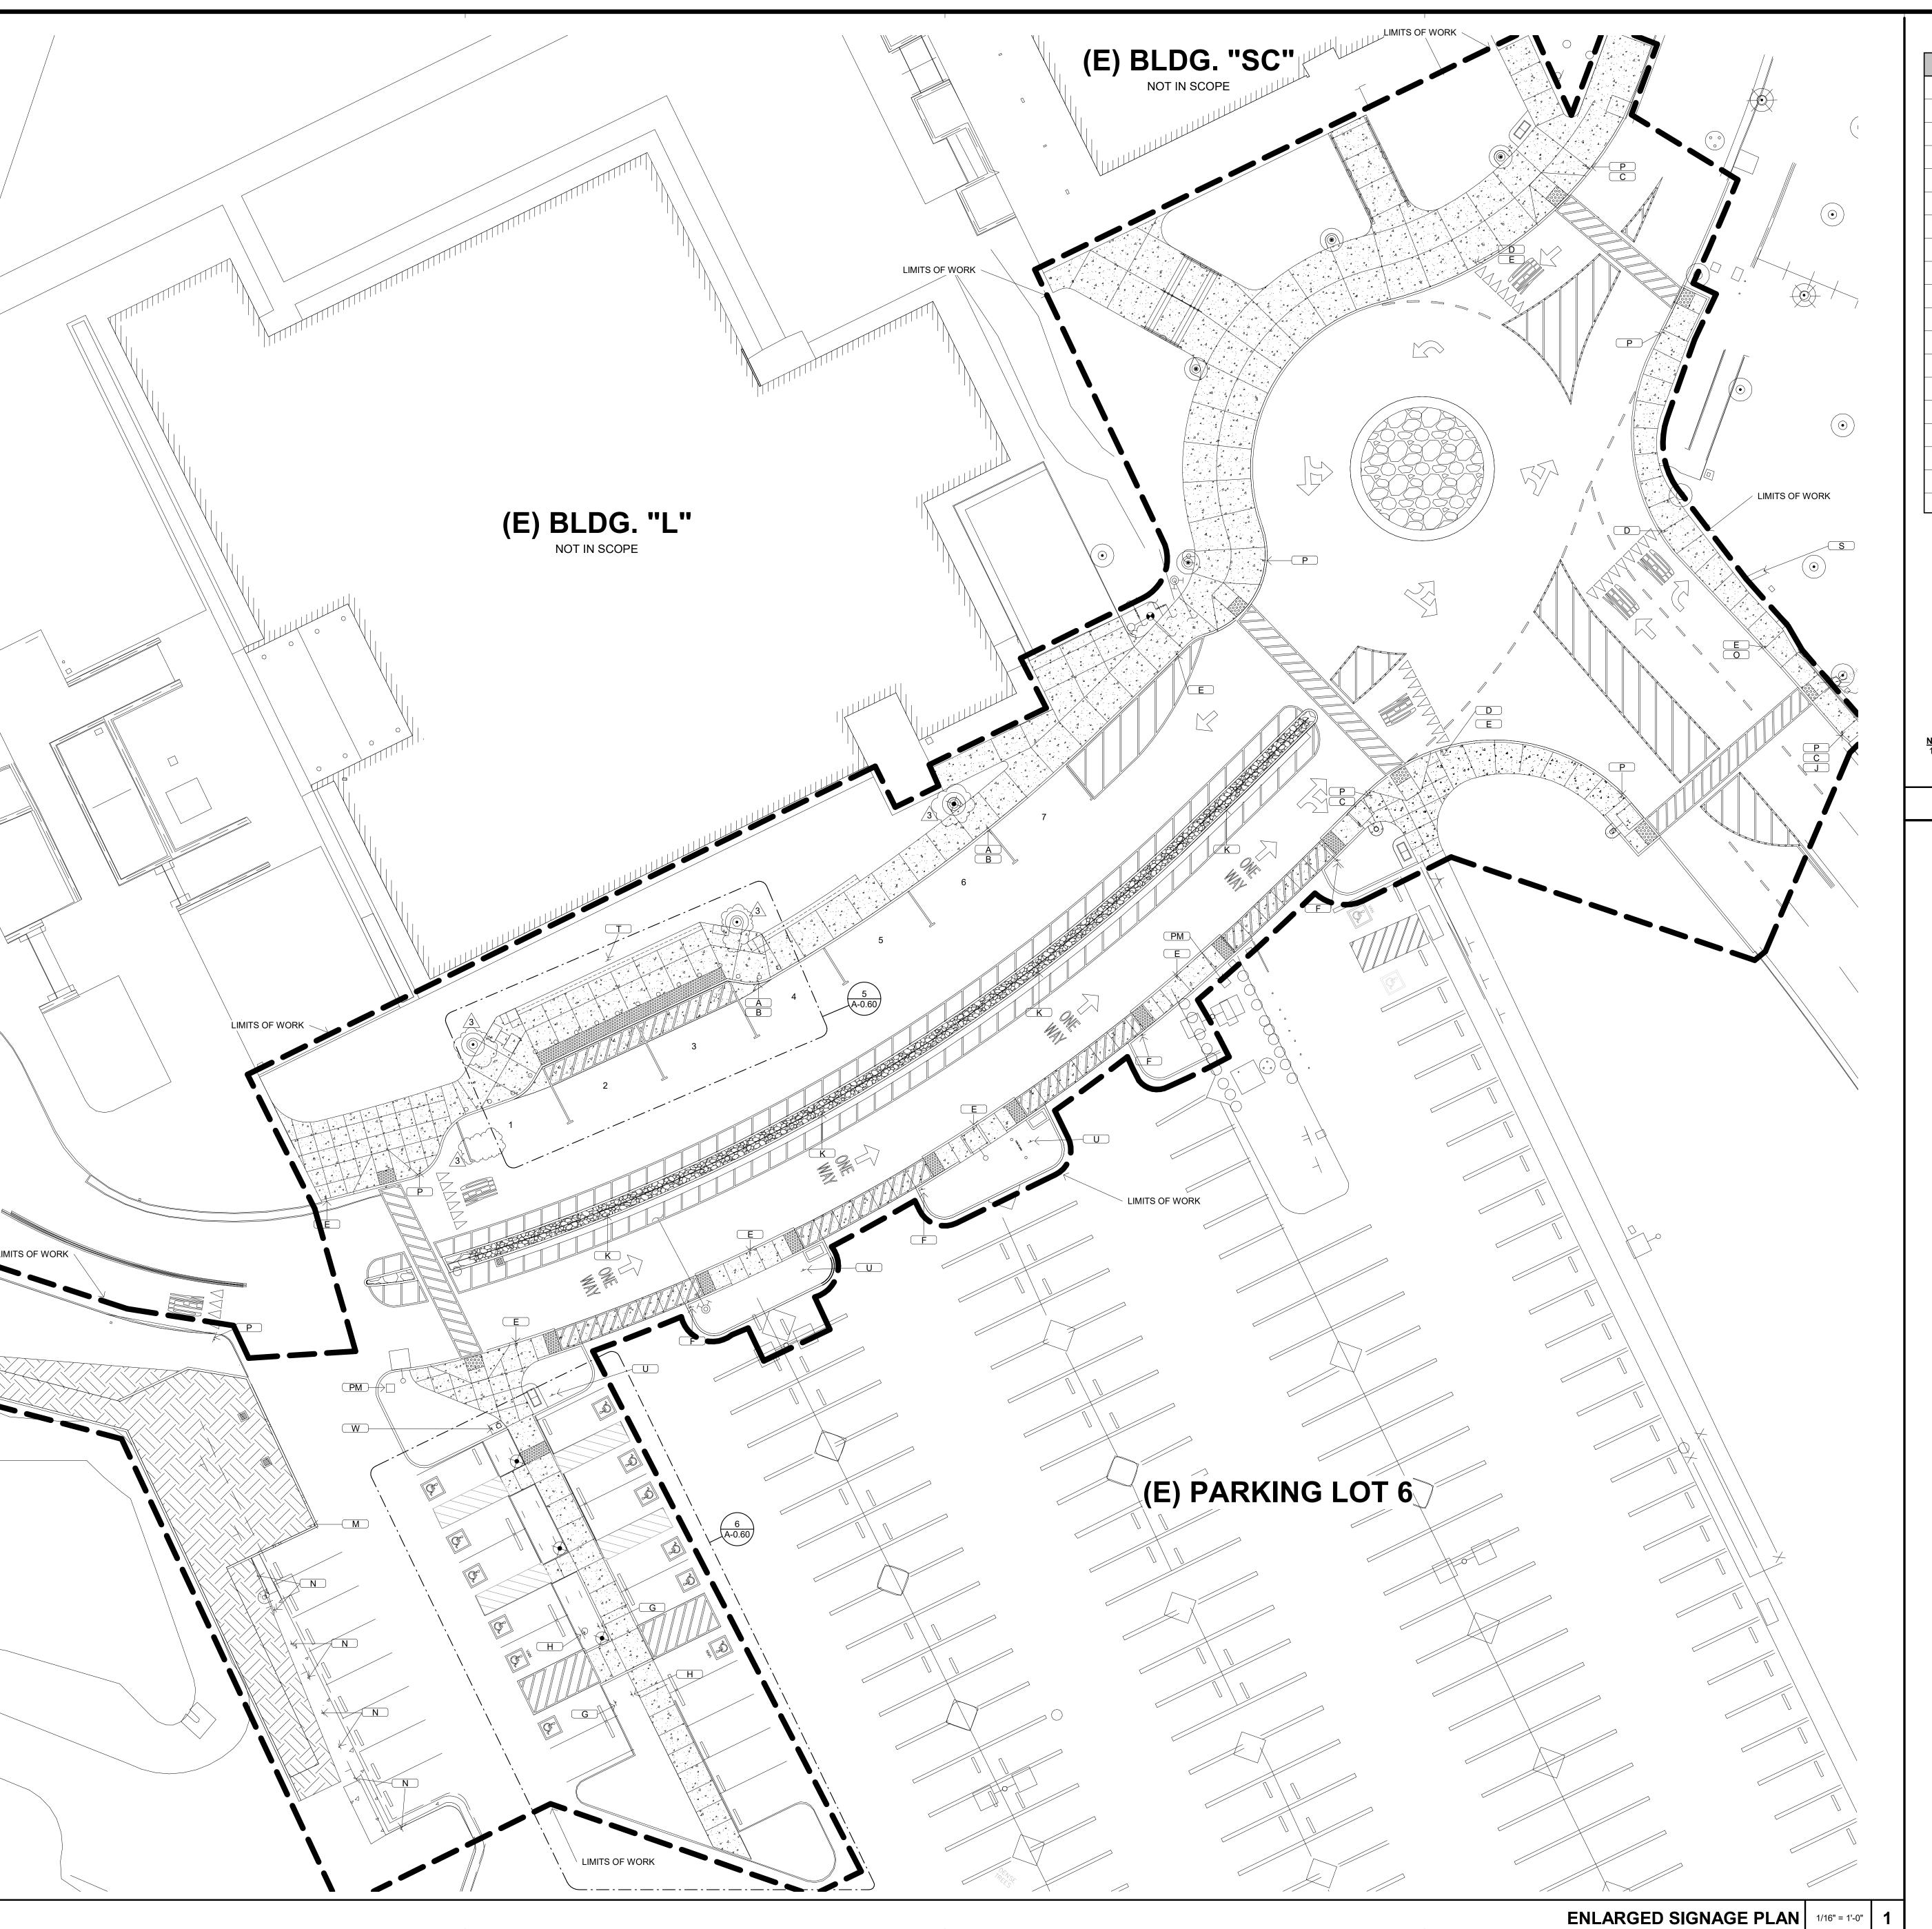


6 HUTTON CENTRE DR, SUITE 1150 SANTA ANA, CA 92707 WWW.SVA-ARCHITECTS.COM T 949.809.3380

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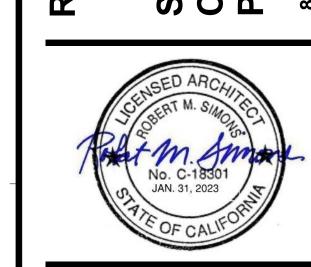


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	<b>)</b>	YIELD SIGN	4 / A-0.50	3
E		FIRE LANE & 'NO' PARKING SIGN	3 / A-0.50	9
F	=	RIGHT TURN ONLY SIGN	8 / A-0.50	4
G	3	ACCESS. PARKING SIGNAGE	2 / A-0.60	2
Н	1	VAN ACCESS. PKG. SIGNAGE	3 / A-0.60	2
J		ROUNDABOUT DIRECTIONAL SIGN	7 / A-0.50	1
□ K		ONE WAY SIGN	10 / A-0.50	4
		SPEED LIMIT SIGN	11 / A-0.50	1
	1	VISITOR PARKING SIGN	12 / A-0.50	8
	<u> </u>	SHIPPING & RECEIVING SIGN	13 / A-0.50	1
Р	<u> </u>	PEDESTRIAN CROSSING SIGN	14 / A-0.50	8
P	M	PARKING LOT MONUMENT	18 / A-0.50	2
S		SITE DIRECTORY MONUMENT	17 / A-0.50	1
		ACCESSIBLE STUDENT DROP OFF SIGN	15 / A-0.50	1
		SMOKE-FREE CAMPUS SIGN	16 / A-0.50	3
W	V	PARKING KIOSK SIGN	19 / A-0.50	1

NOTES:

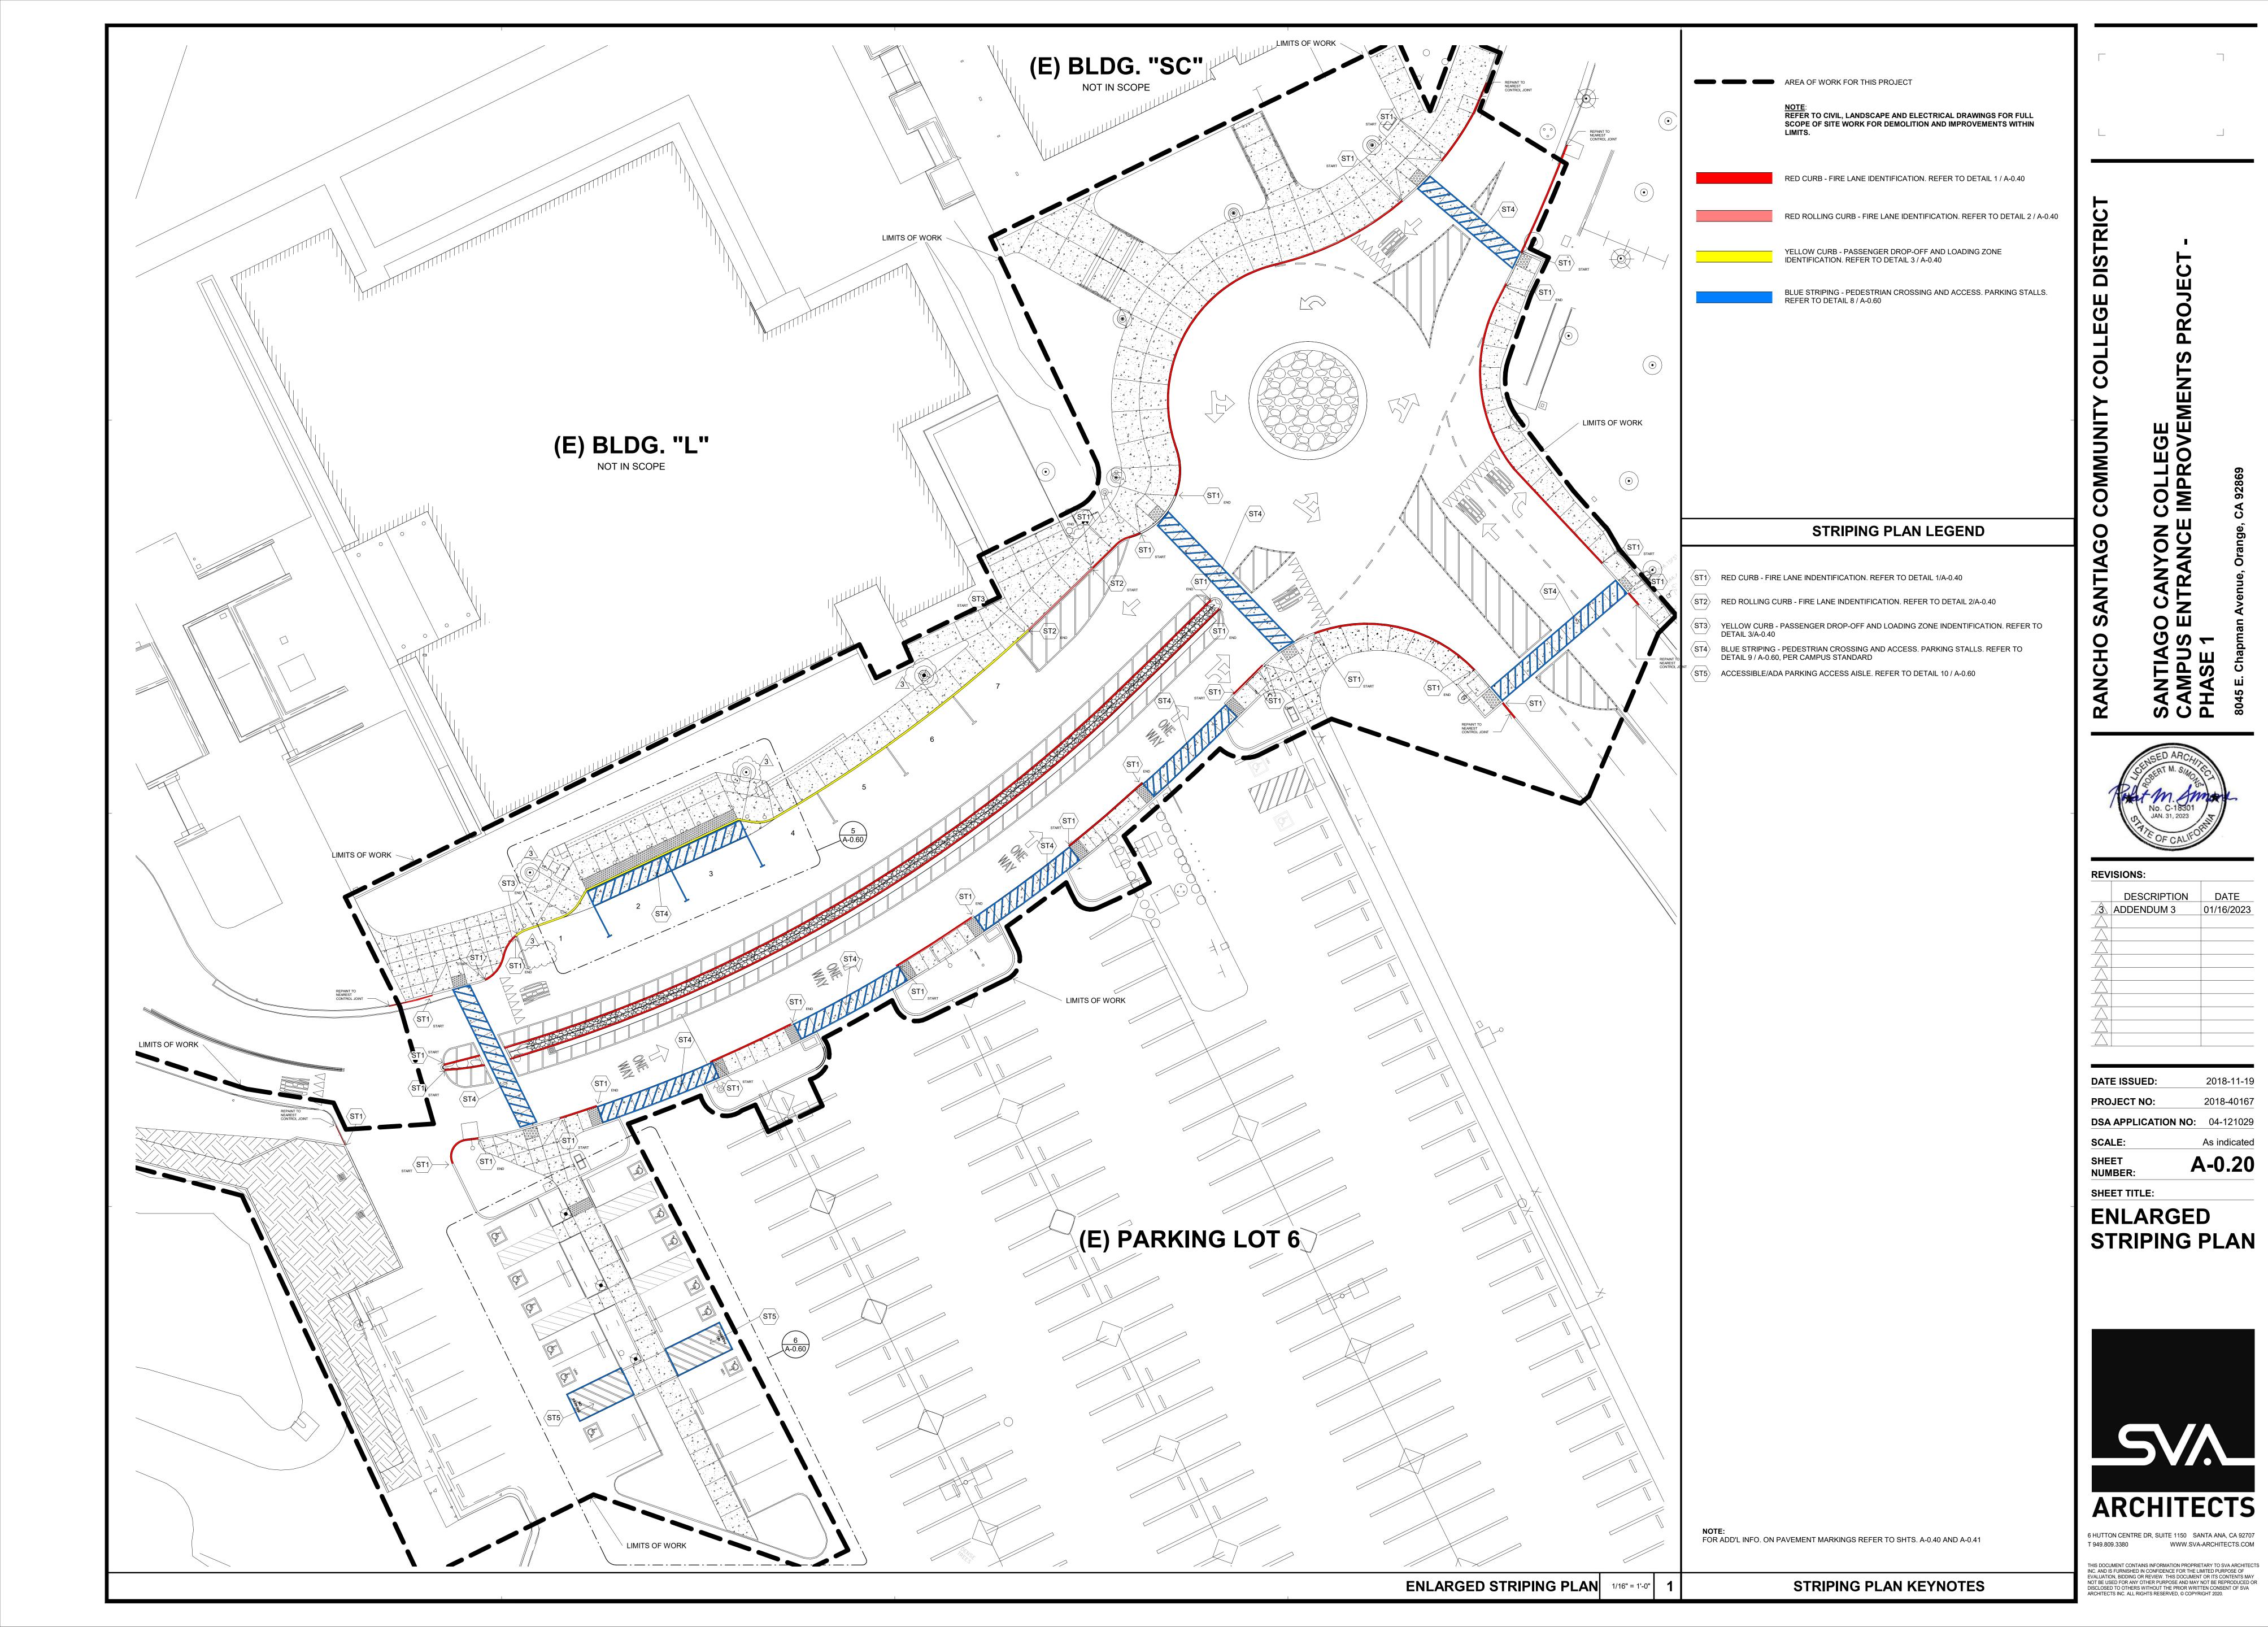1. REFER TO DETAILS ON SHEETS A-0.50 AND A-0.60 FOR INFO. ON SIGNAGE DESCRIPTION AND DIMENSIONS.

### SIGNAGE LEGEND



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DESCRIPTION DATE

ADDENDUM 3 01/16/20

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DATE ISSUED: 2018-11-19
PROJECT NO: 2018-40167

DSA APPLICATION NO: 04-121029

SCALE: As indicated


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SIGNAGE PLAN



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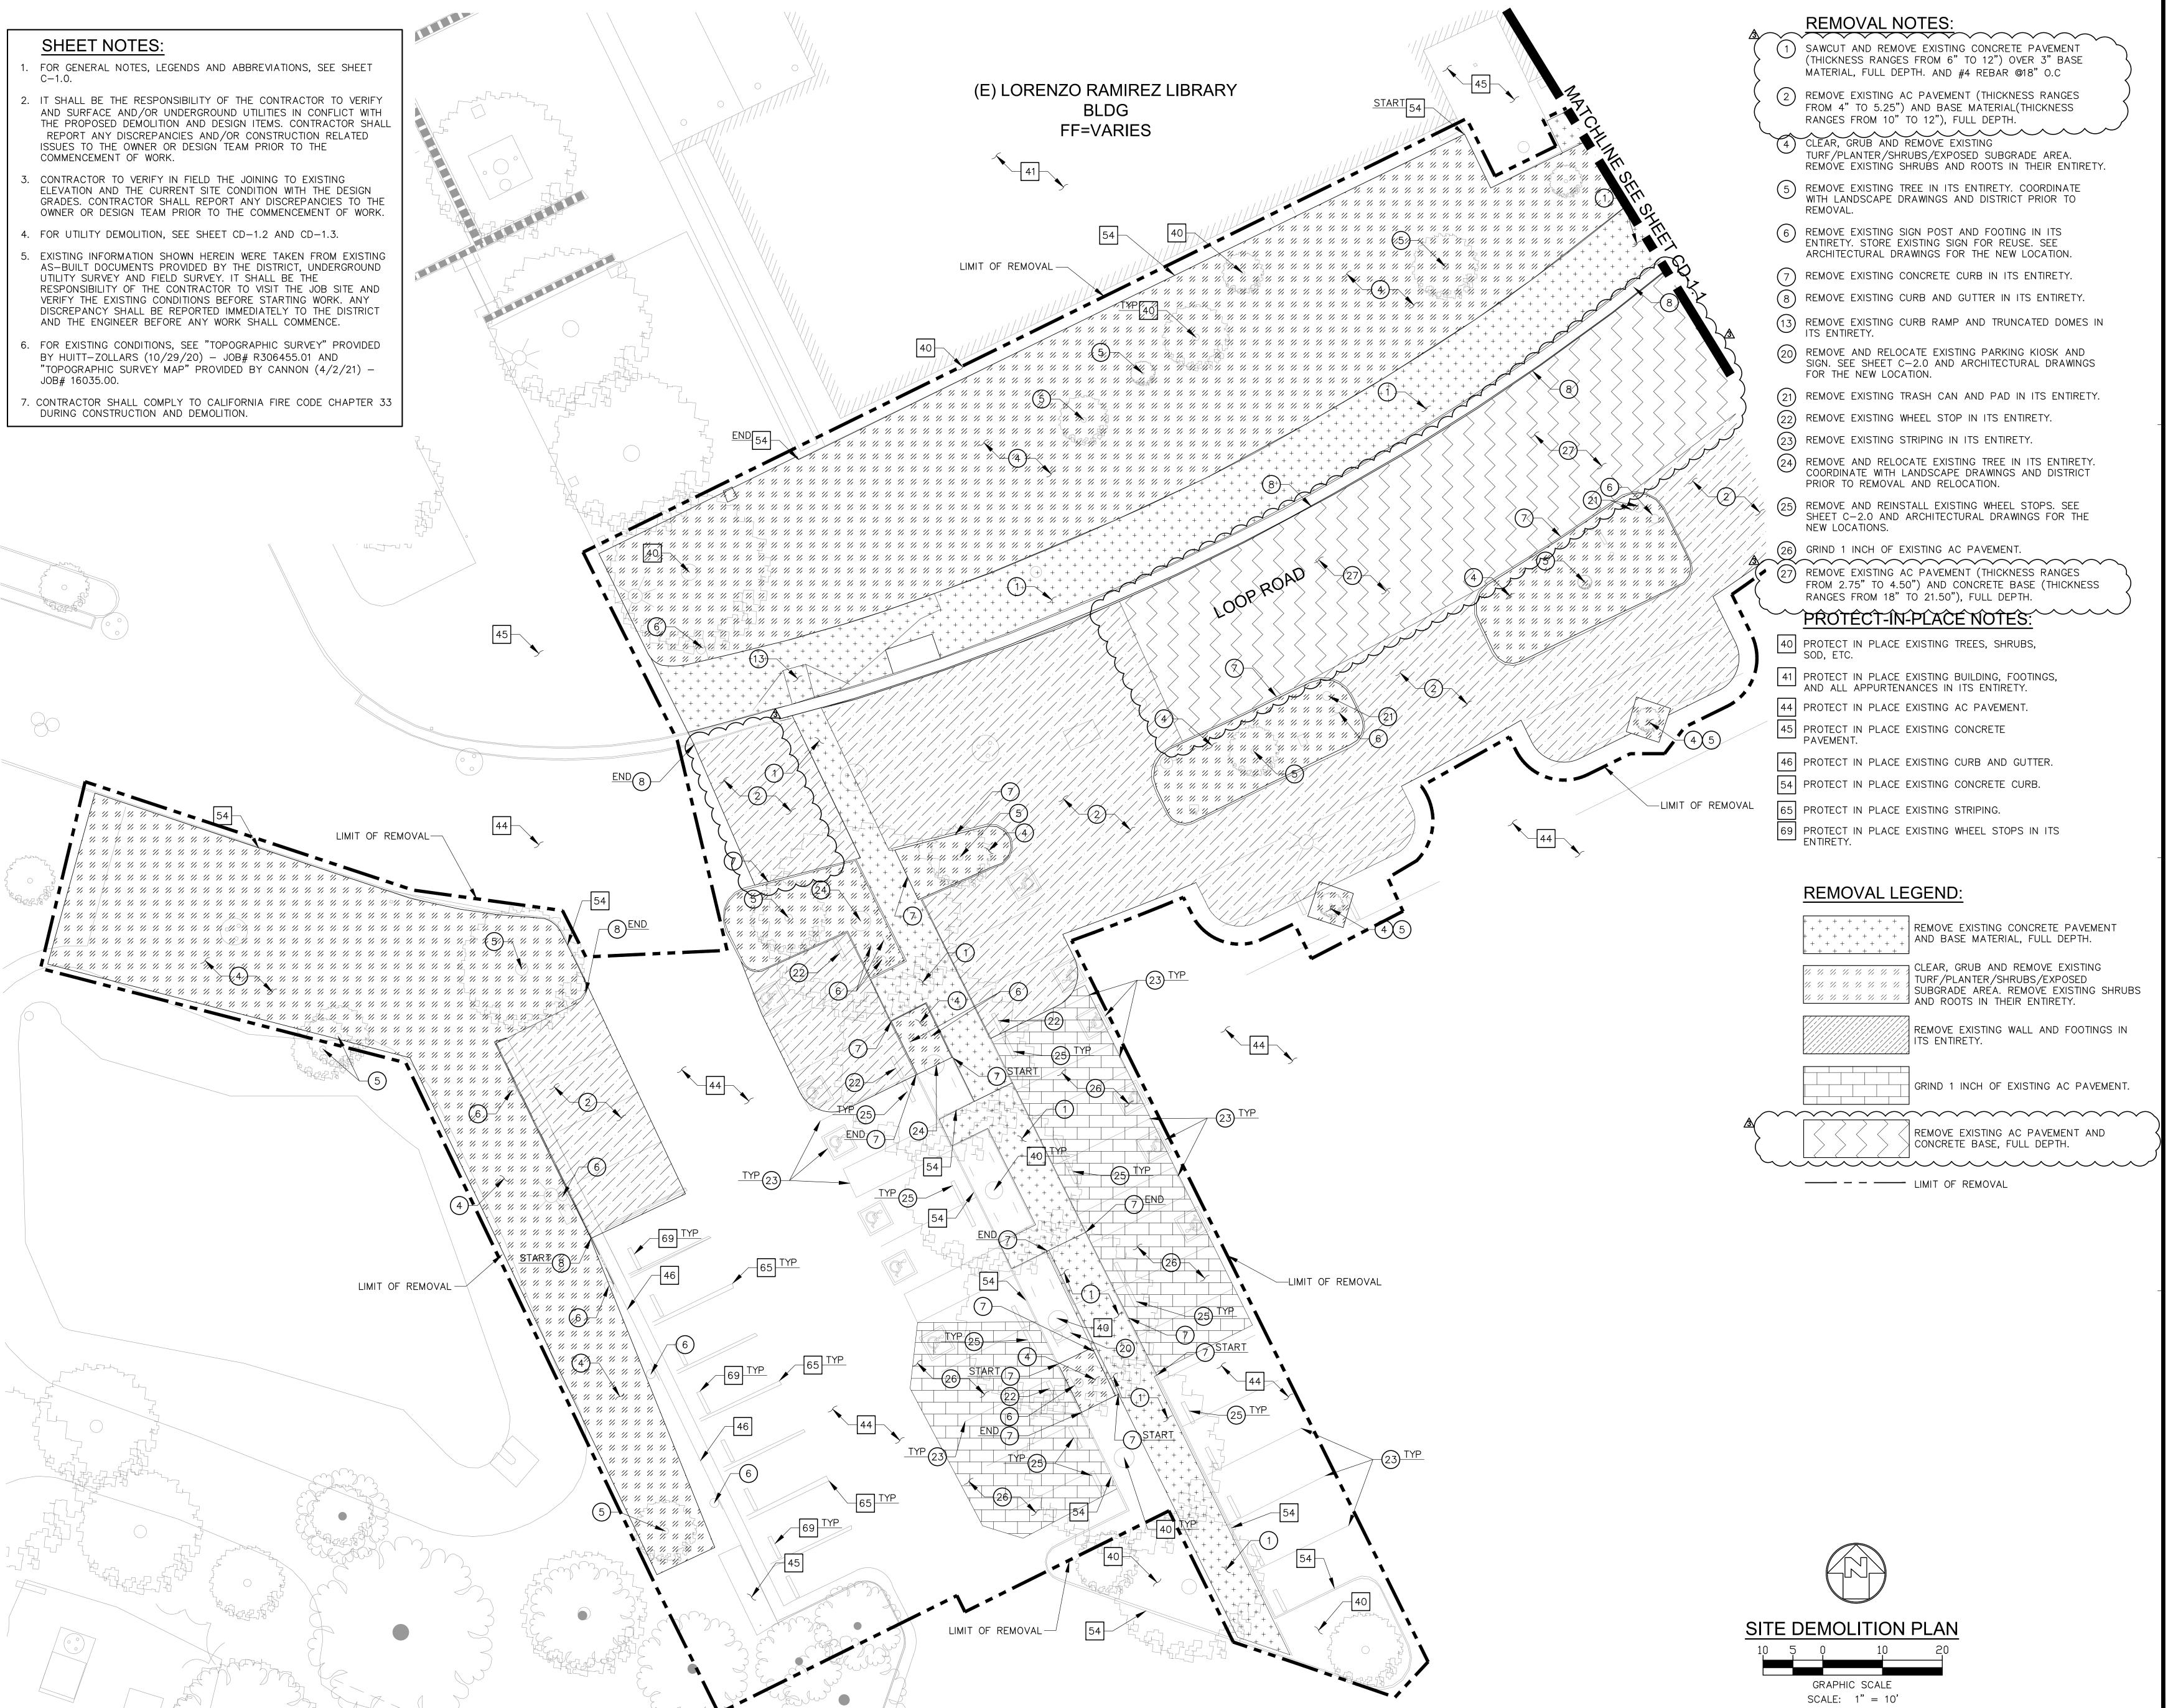
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**DATE ISSUED:** 2018-11-19 **PROJECT NO:** 2018-40167 **DSA APPLICATION NO:** 04-121029 SCALE: As indicated A-0.60SHEET **NUMBER:** 

**ACCESSIBILITY PARKING PLANS AND DETAILS** 



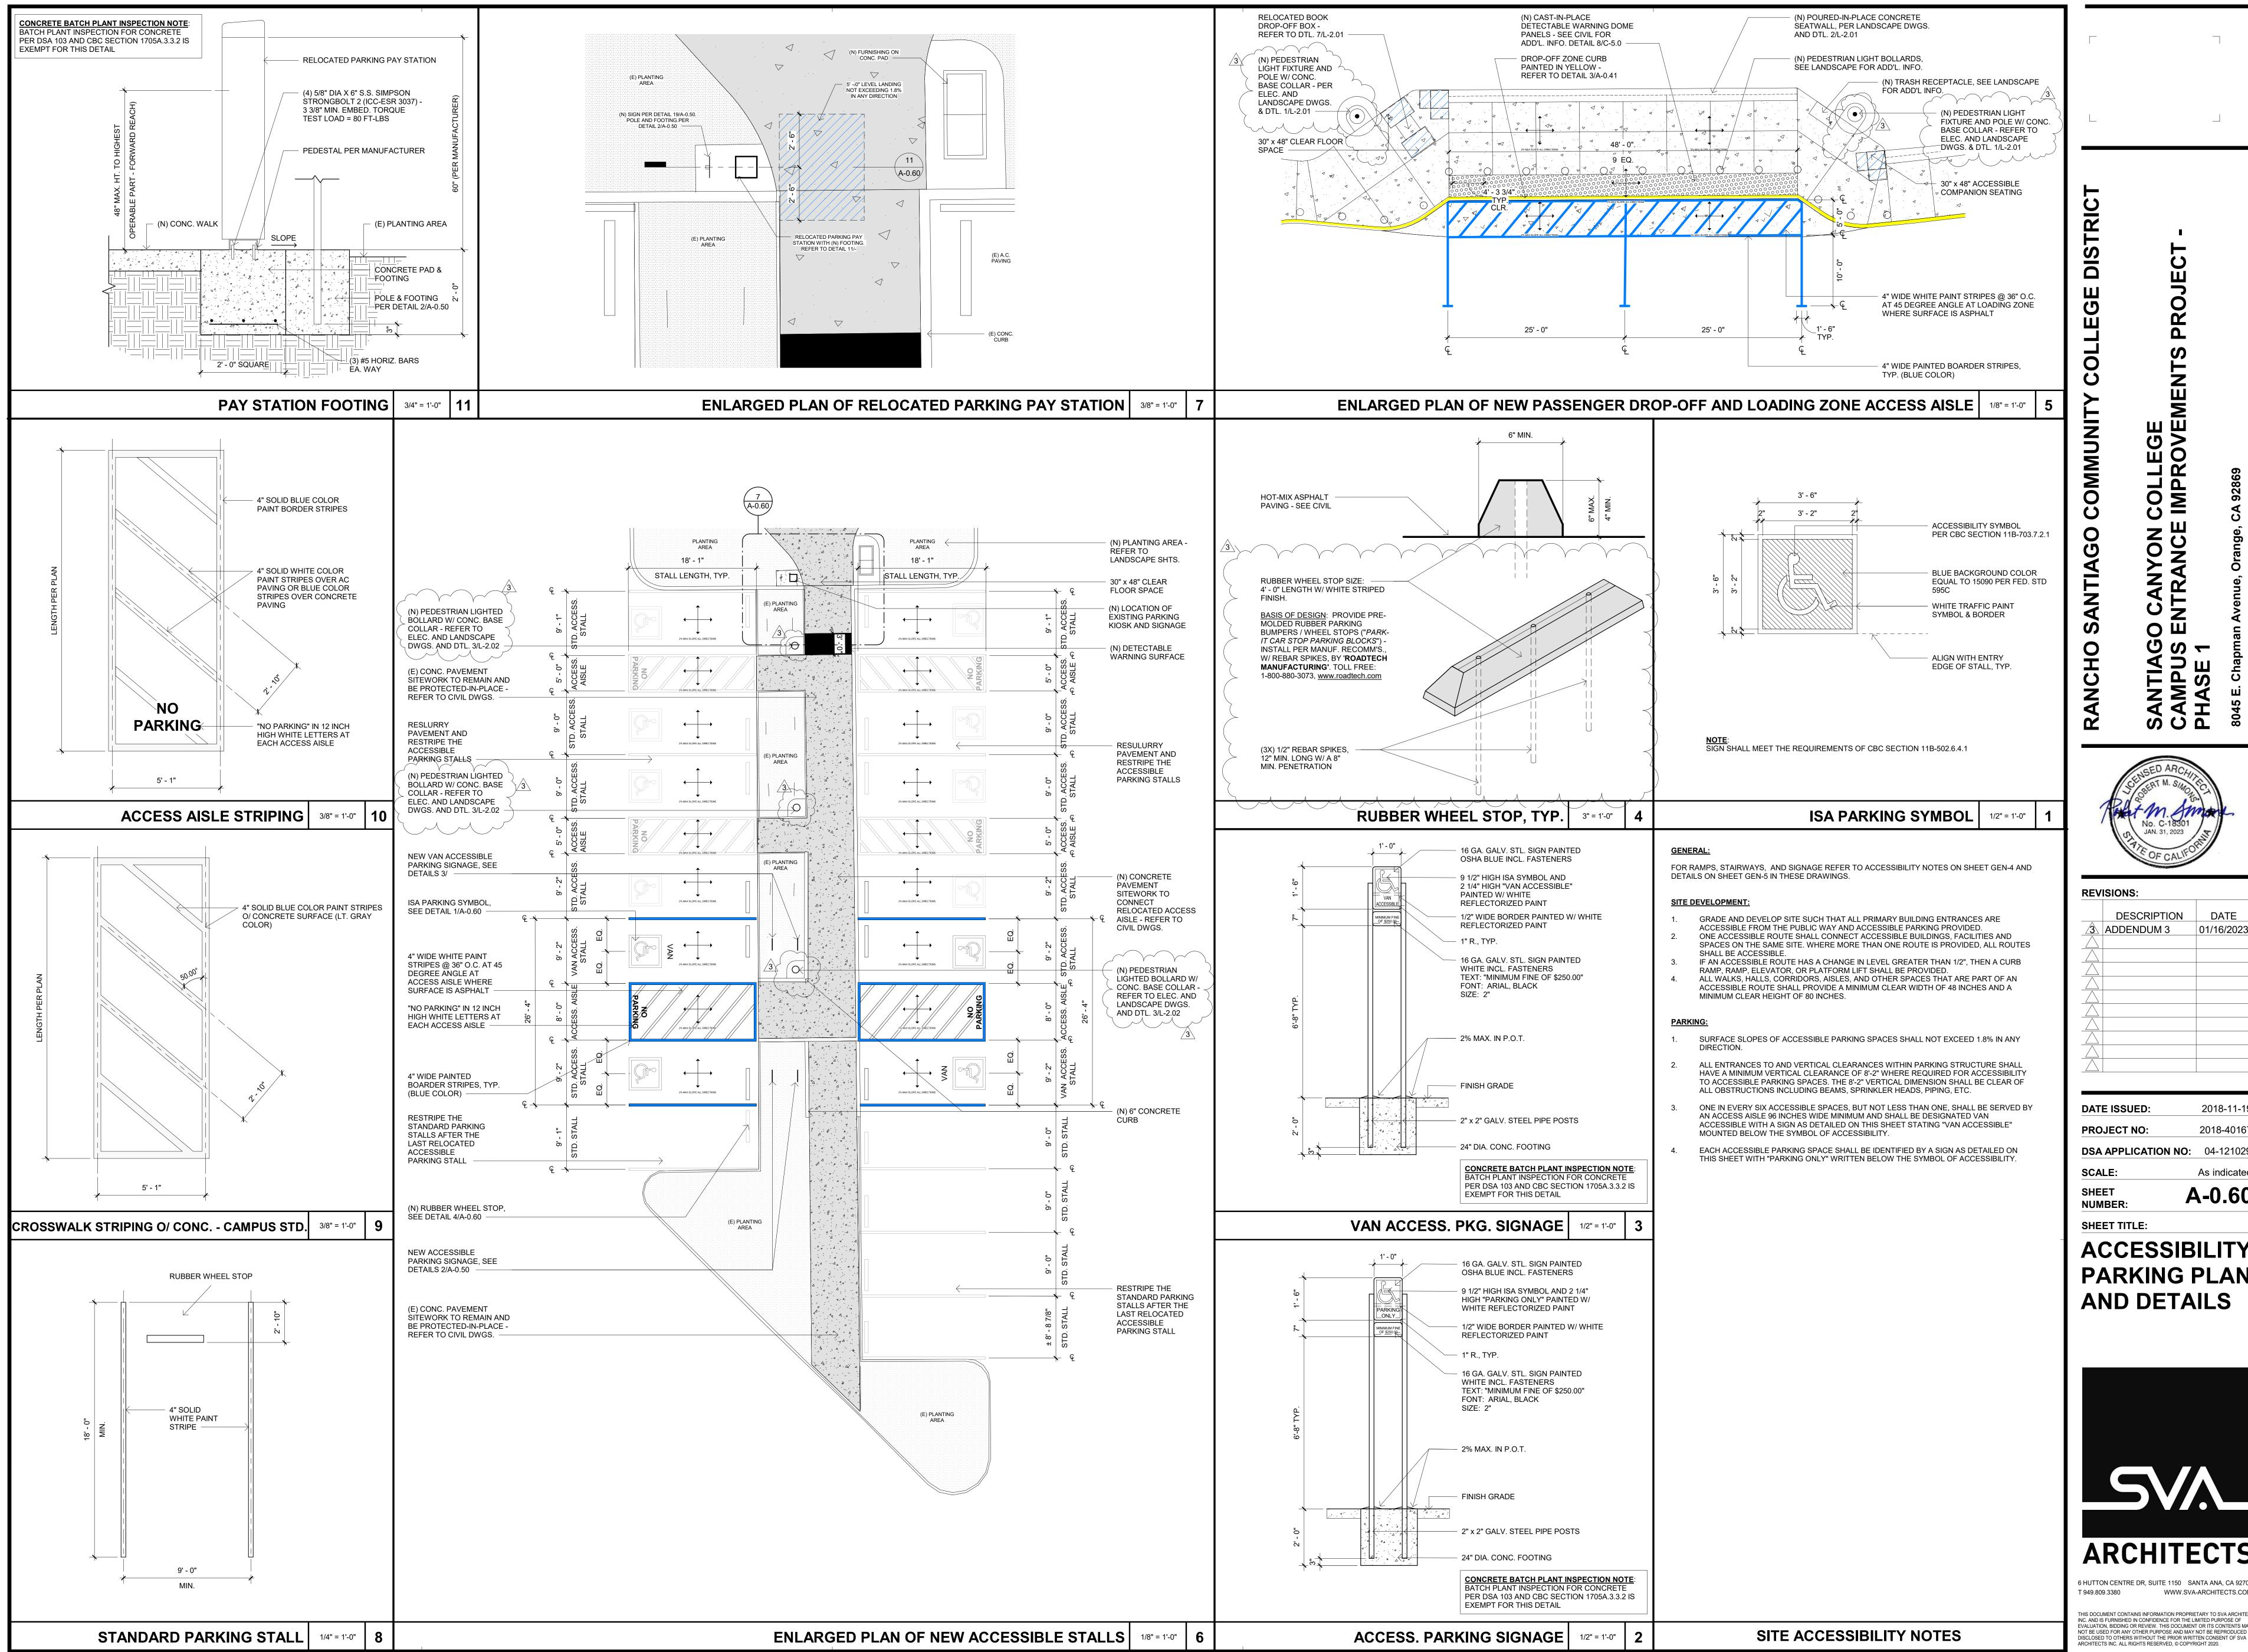

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No. C36079

Exp. 6/30/24

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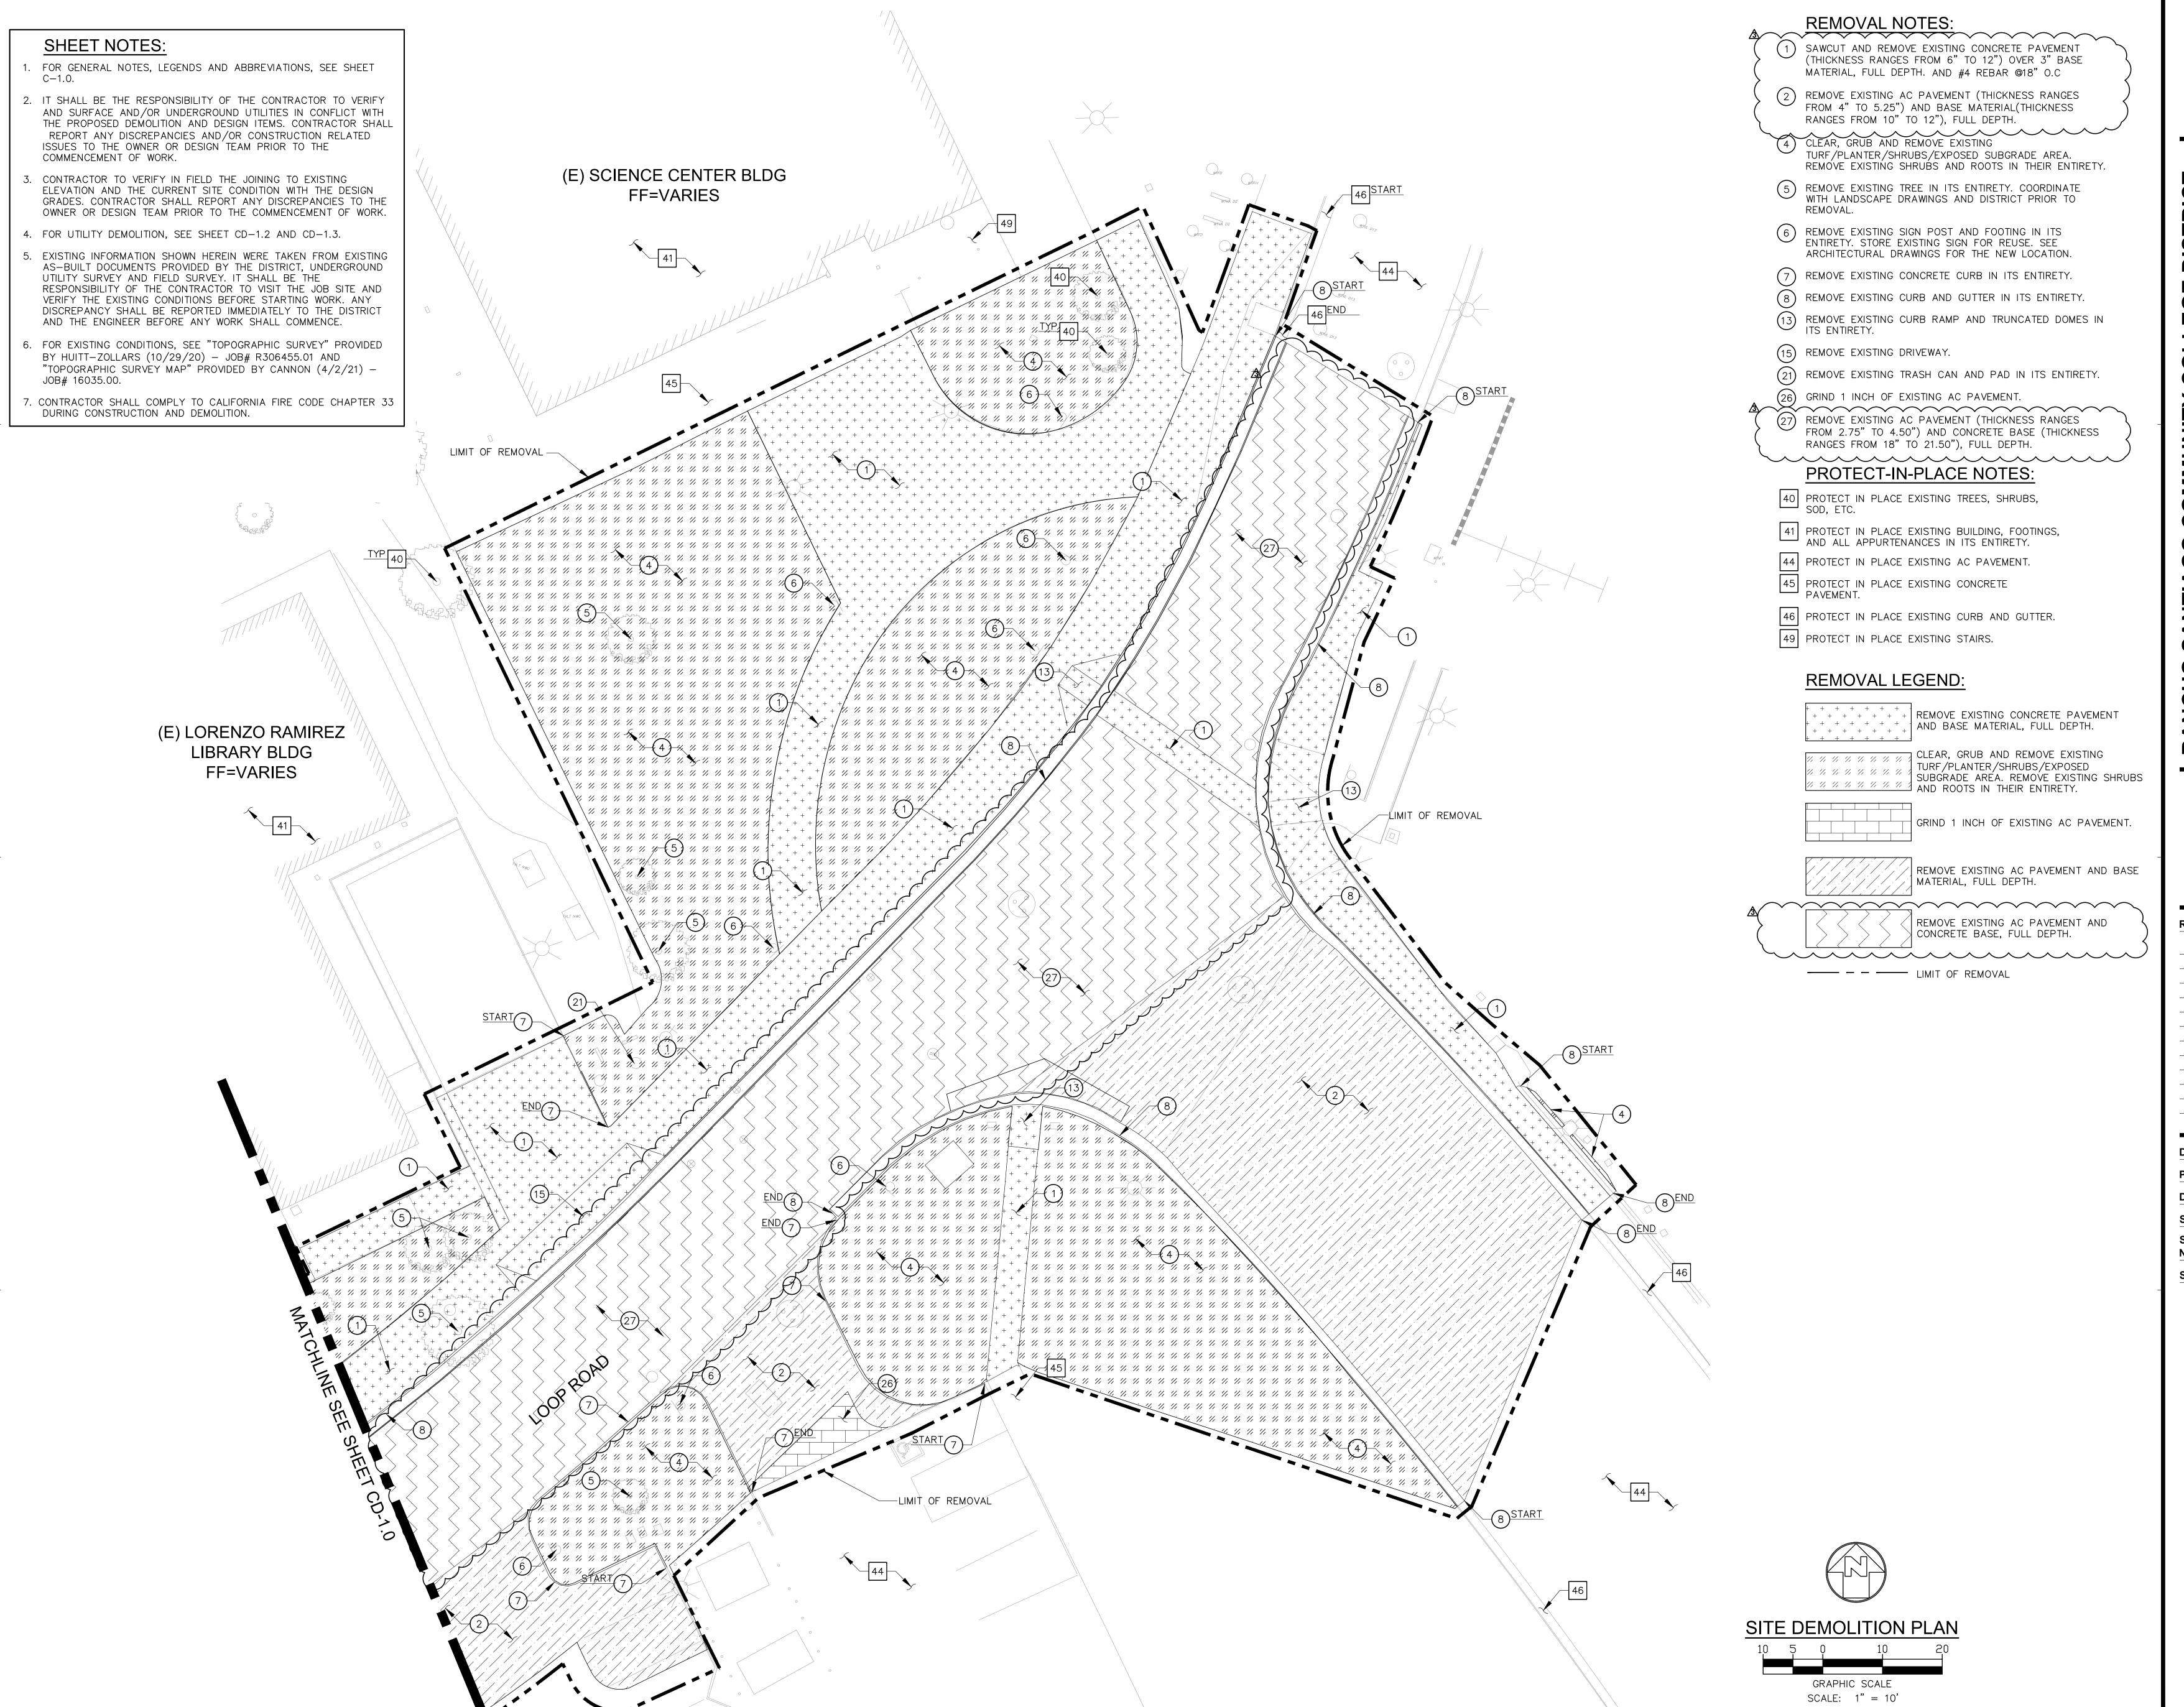
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DATE ISSUED:2018-11-19PROJECT NO:2018-40167DSA APPLICATION NO:04-121029SCALE:As indicated

NUMBER: CD-1.0
SHEET TITLE:

SITE DEMOLITION PLAN





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 2018-11-19

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 2018-40167

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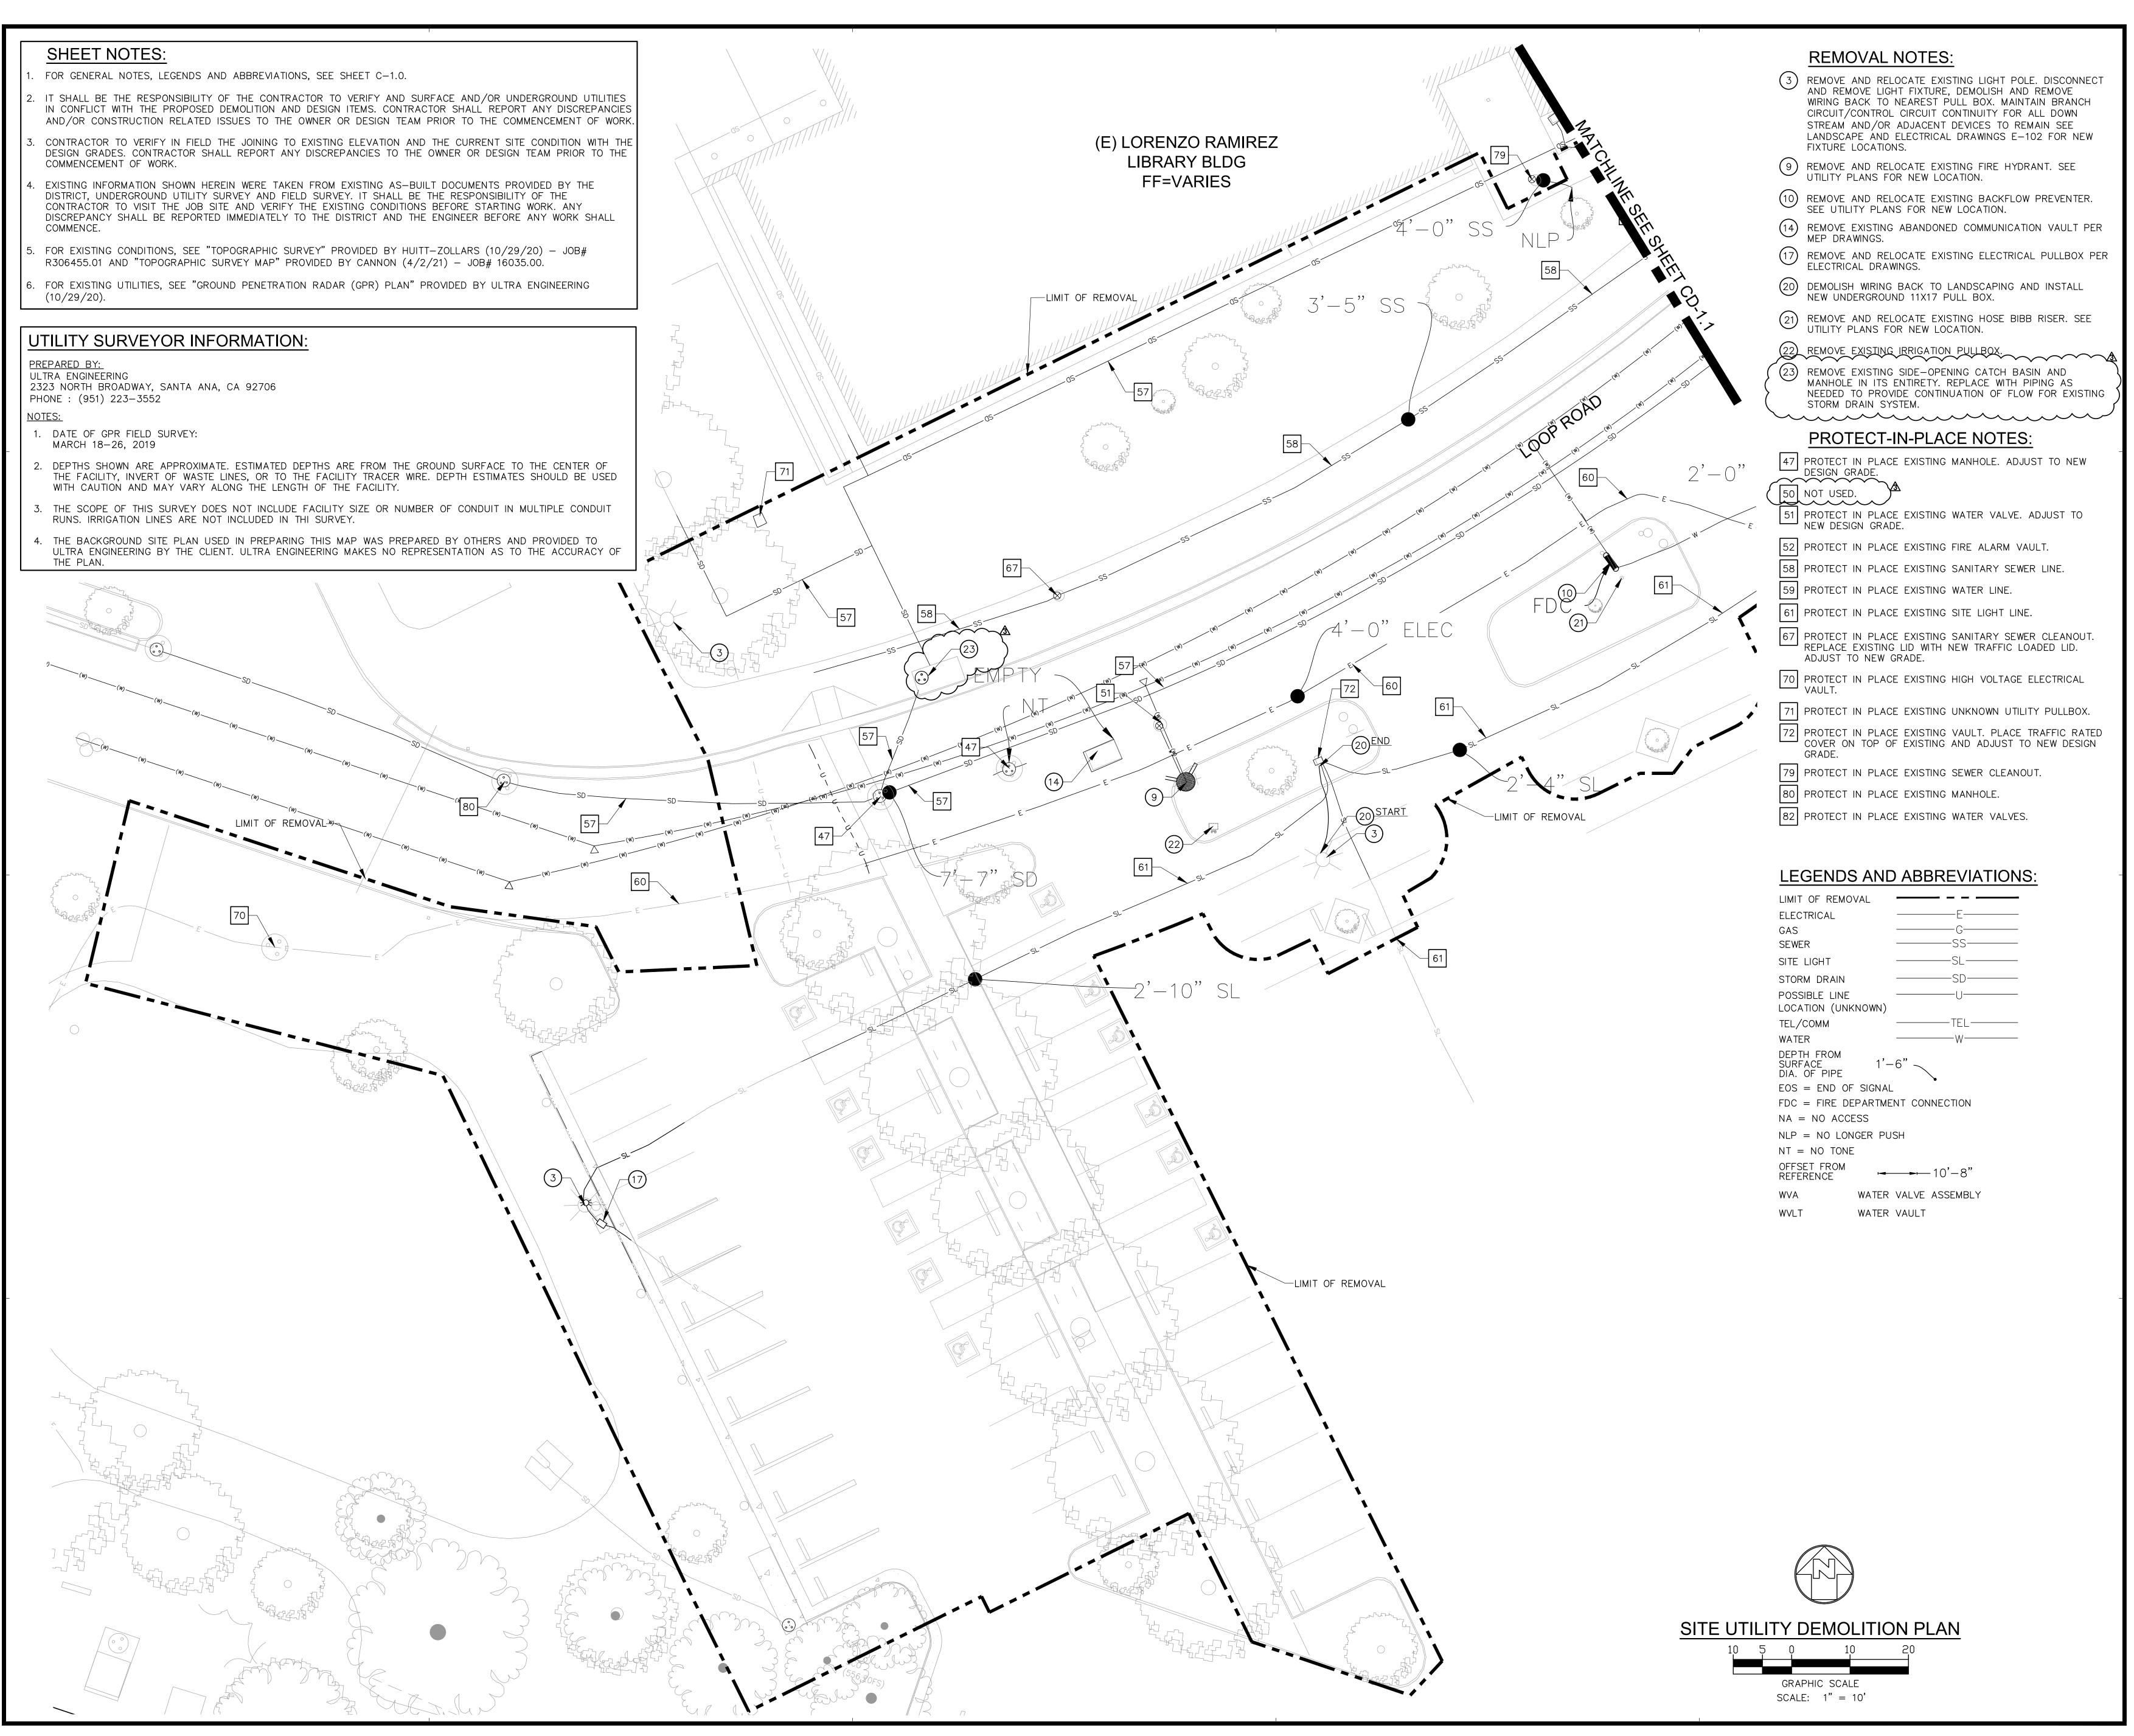
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SHEET CD-1.1

SHEET TITLE:

SITE DEMOLITION PLAN





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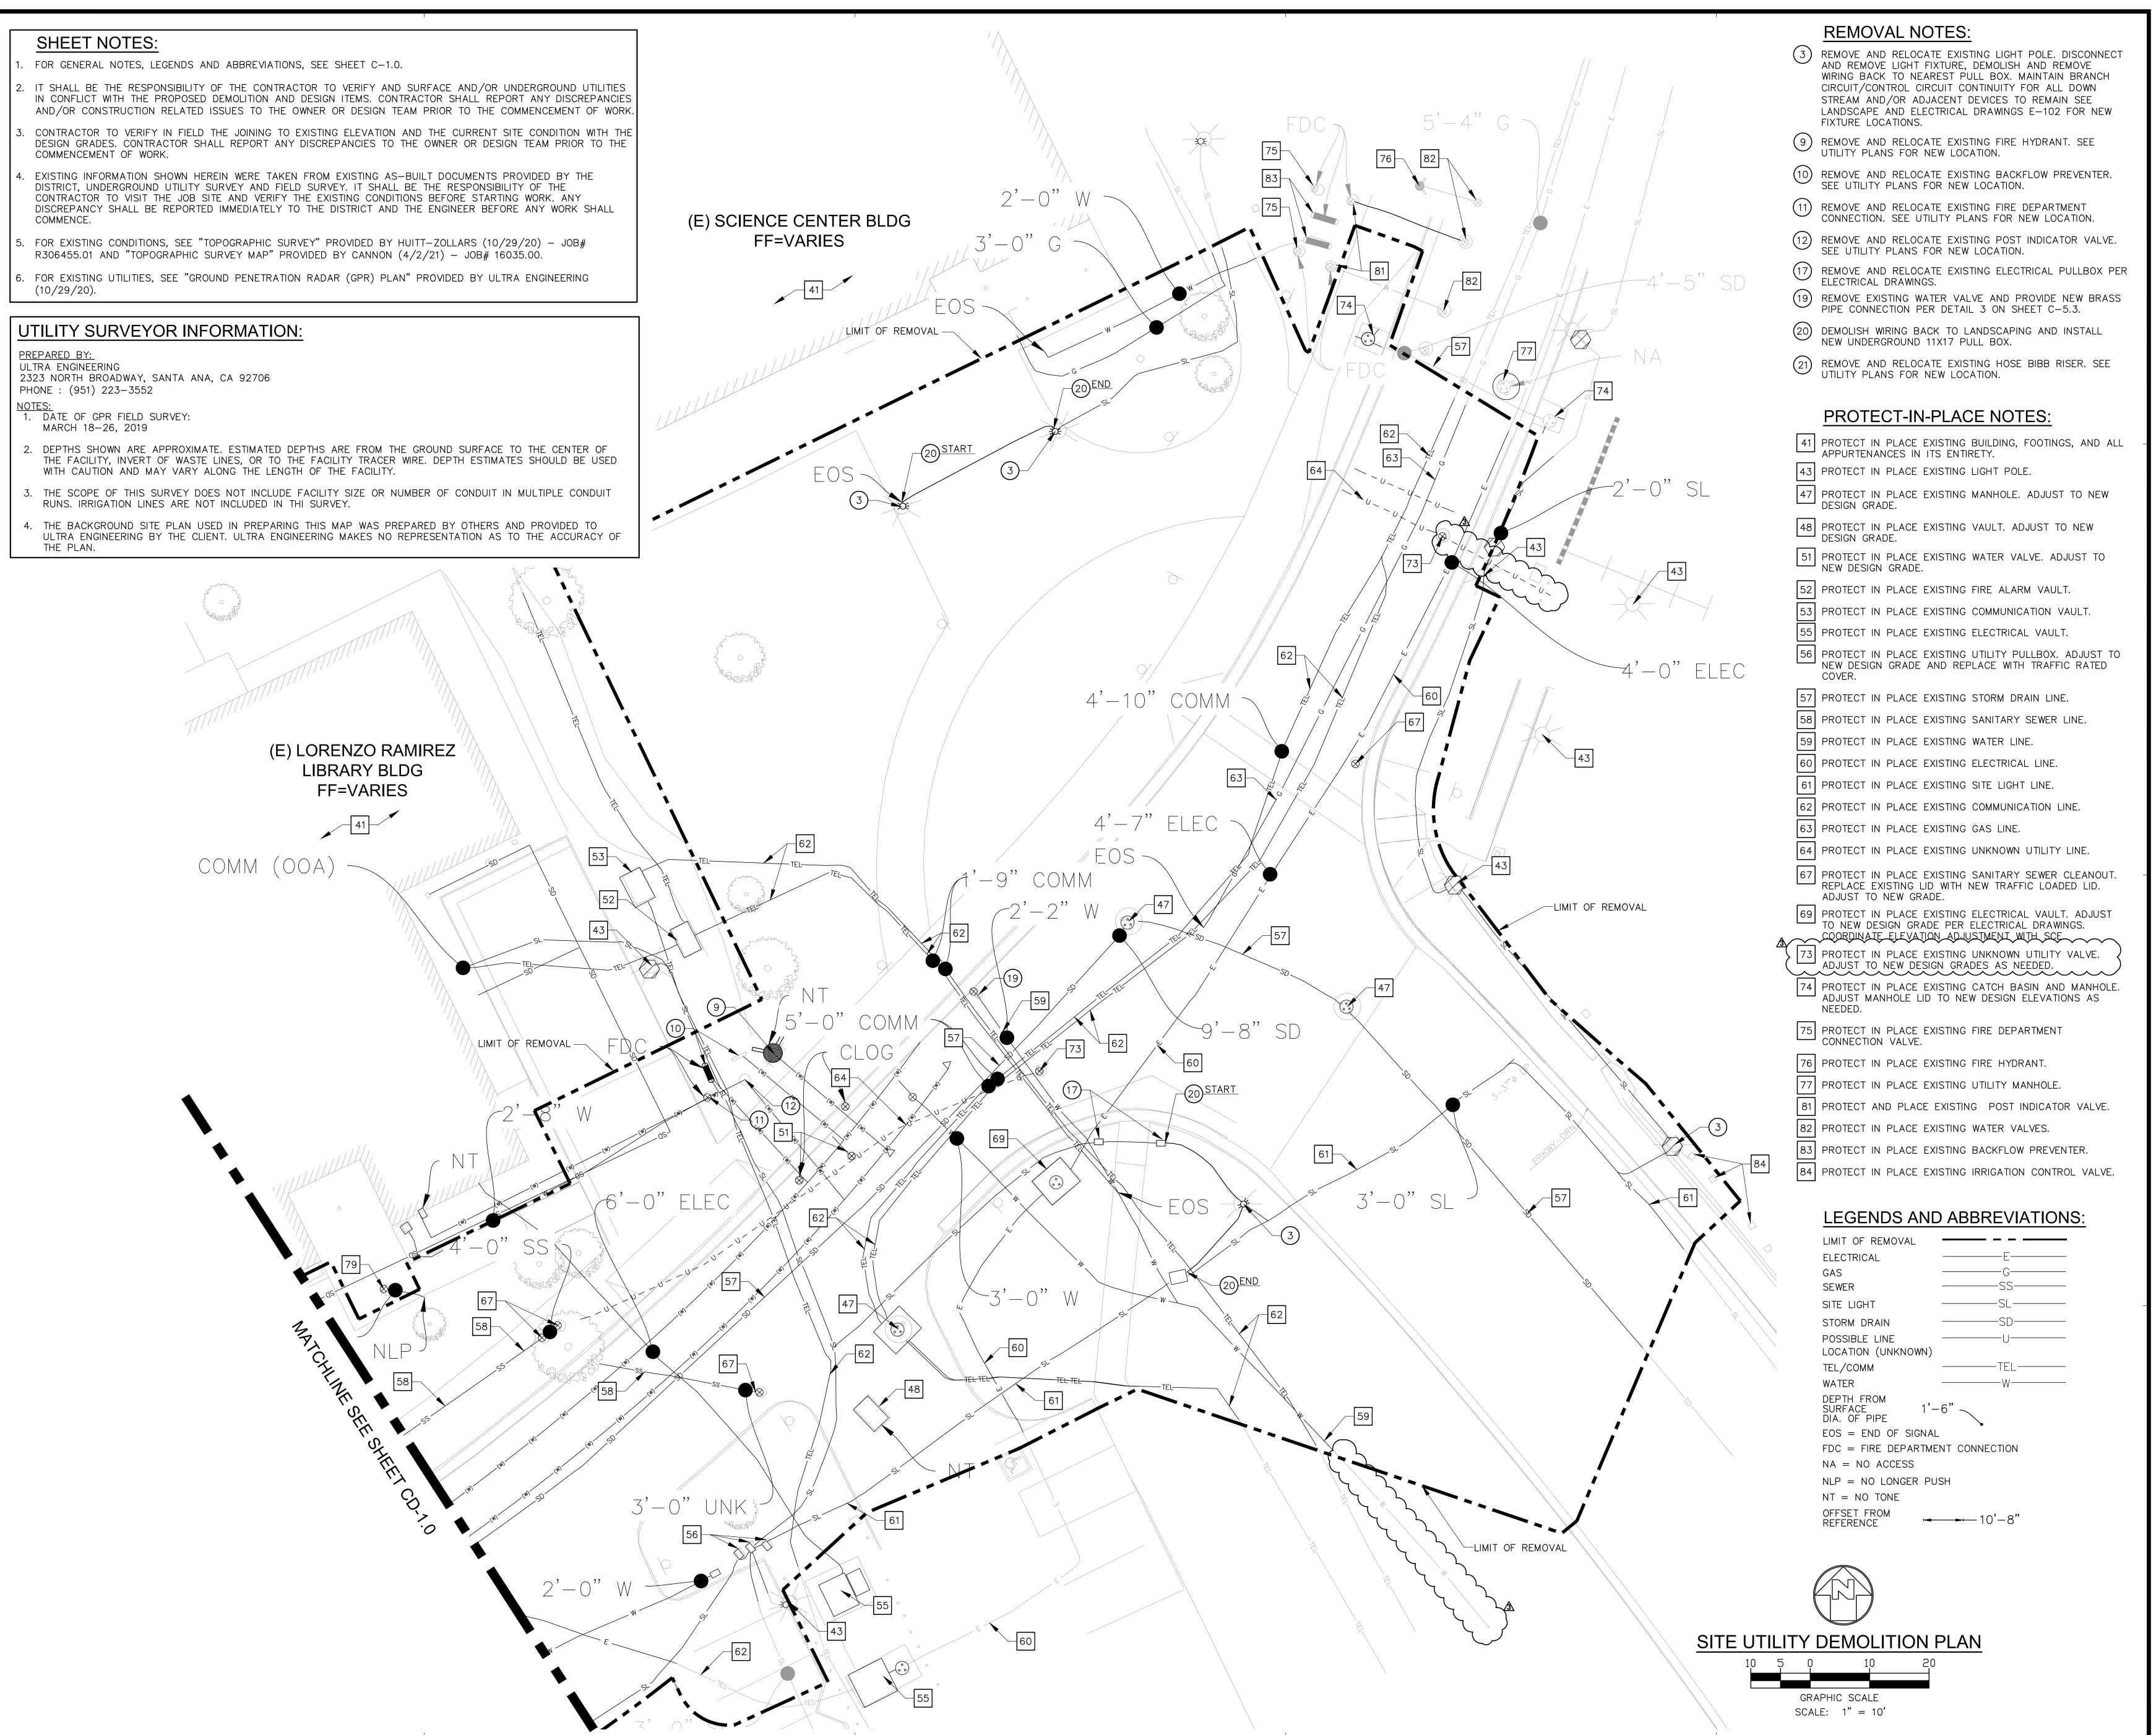
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SHEET TITLE:

SITE UTILITY DEMOLITION PLAN





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 2018-40167

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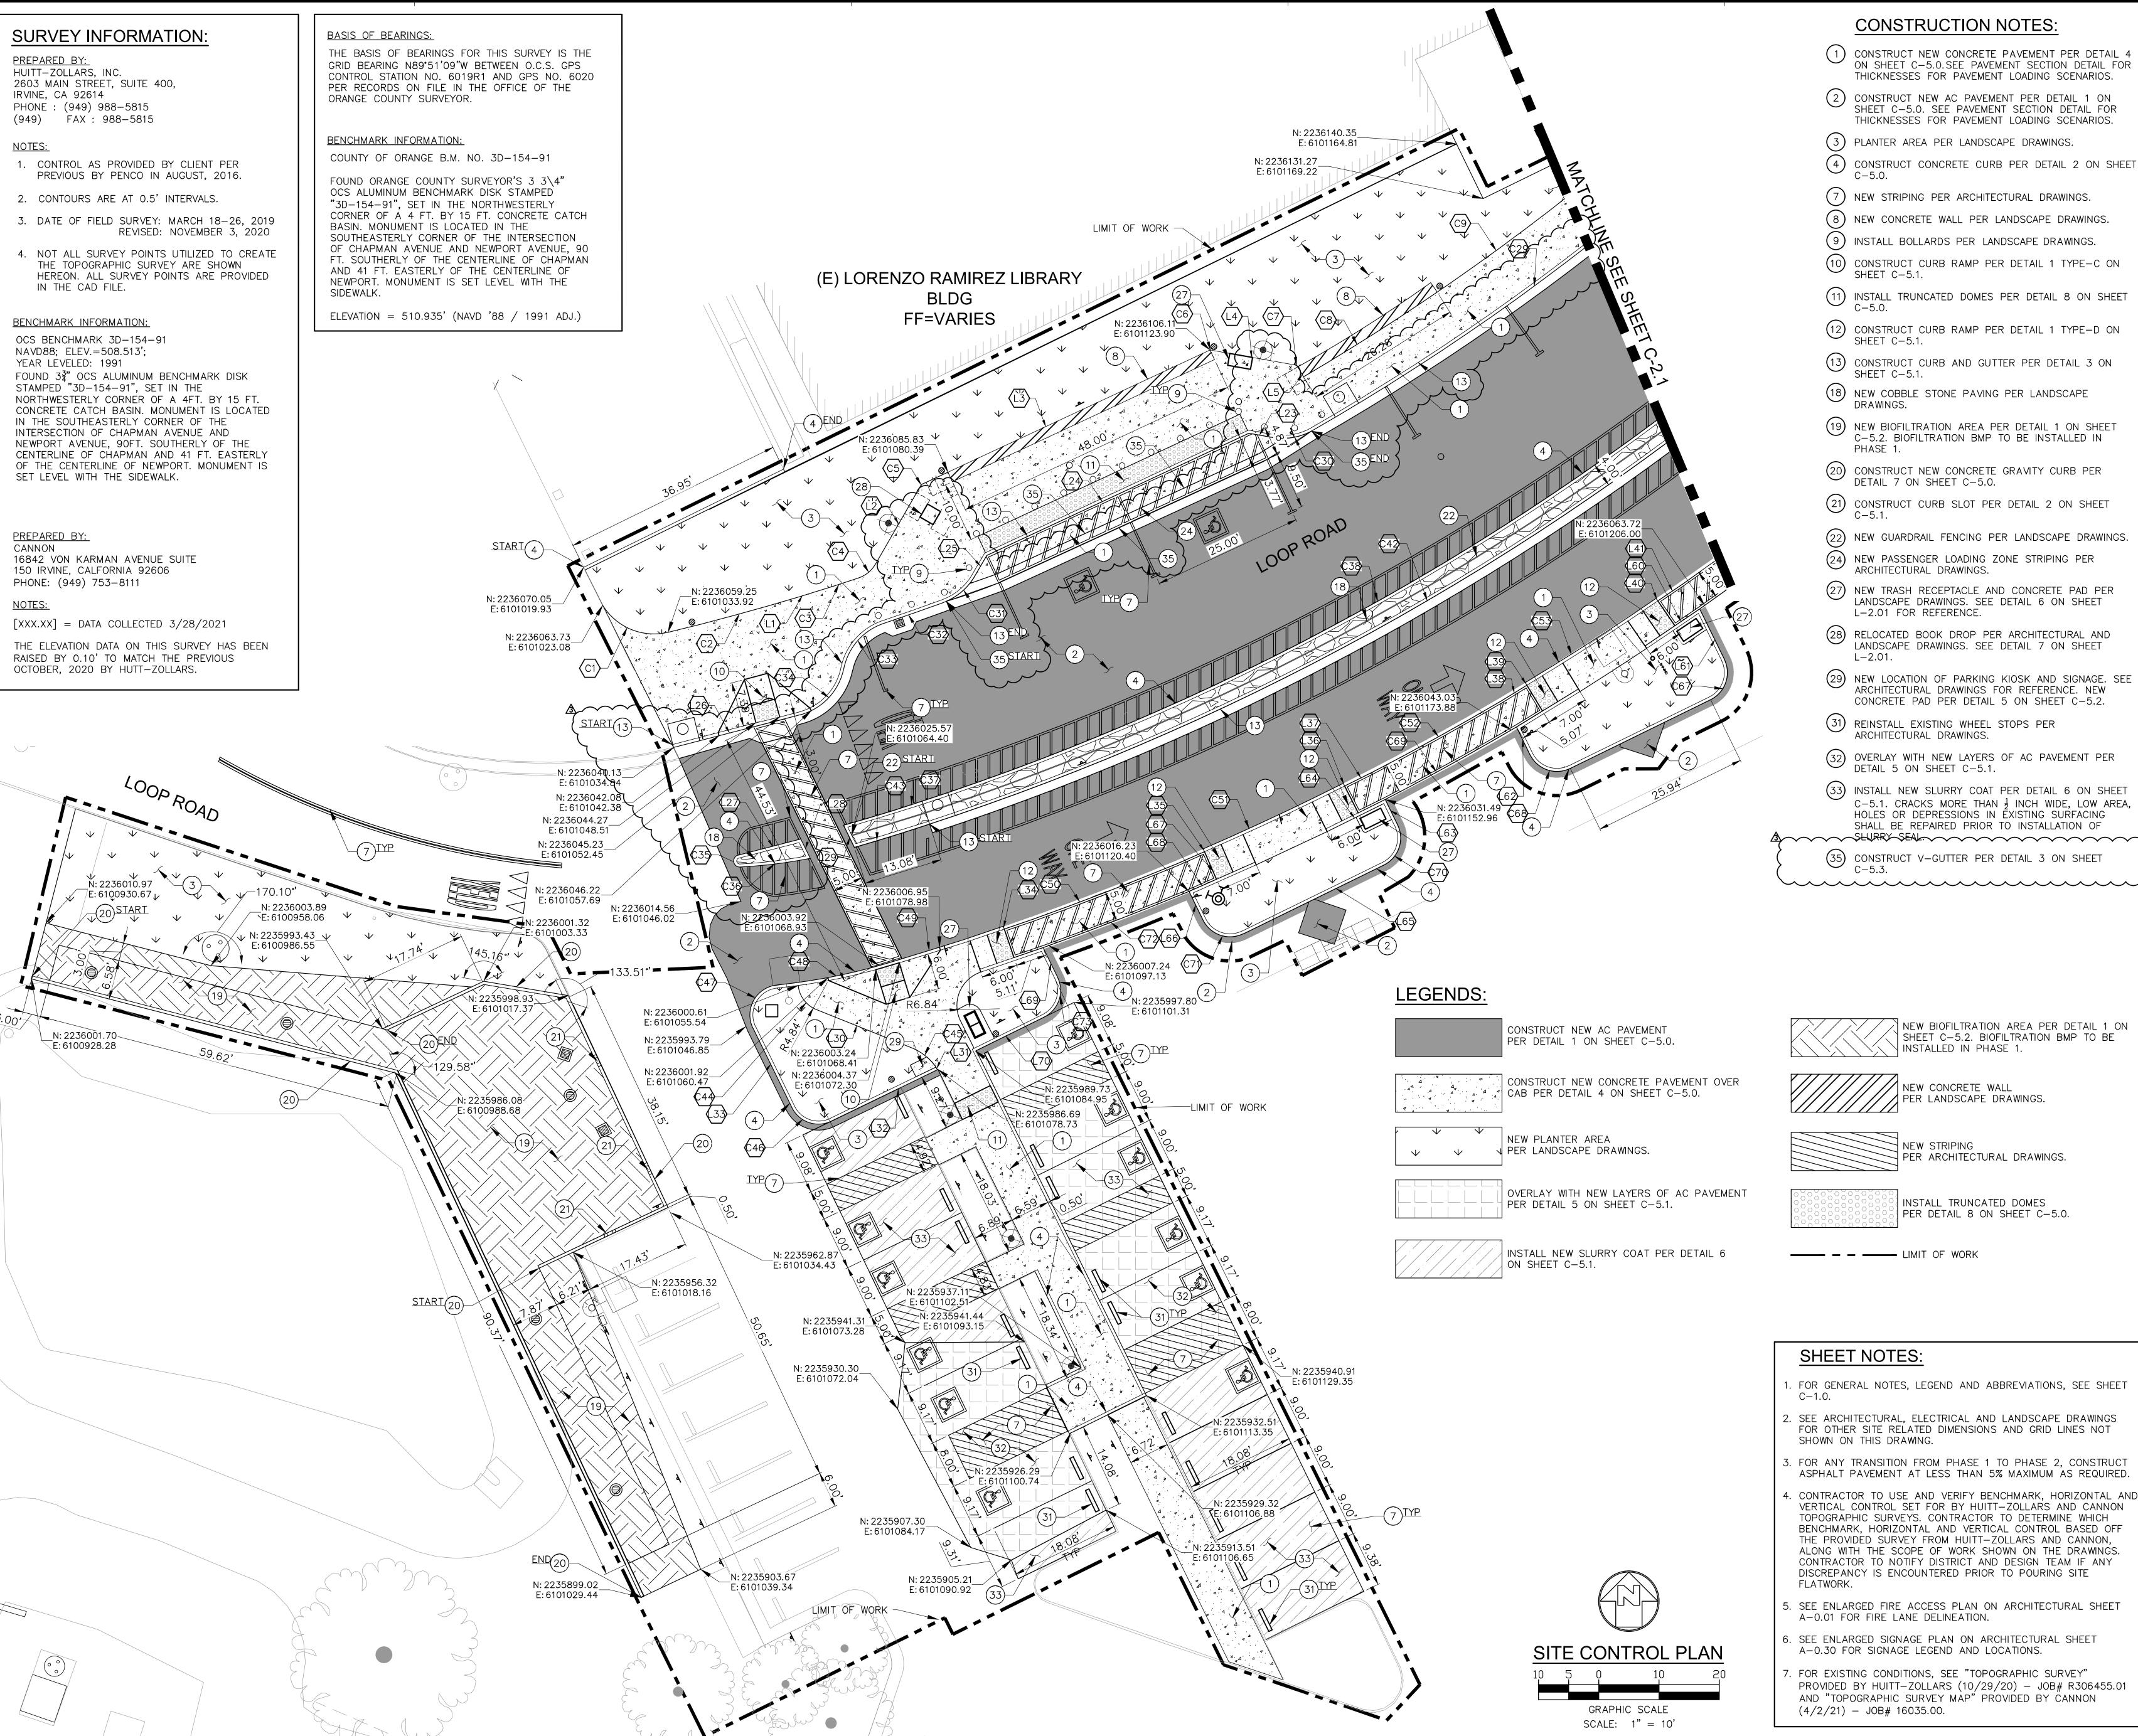
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SITE UTILITY DEMOLITION PLAN






### **CONSTRUCTION NOTES:**

- (1) CONSTRUCT NEW CONCRETE PAVEMENT PER DETAIL 4 ON SHEET C-5.0. SEE PAVEMENT SECTION DETAIL FOR THICKNESSES FOR PAVEMENT LOADING SCENARIOS.
- (2) CONSTRUCT NEW AC PAVEMENT PER DETAIL 1 ON SHEET C-5.0. SEE PAVEMENT SECTION DETAIL FOR THICKNESSES FOR PAVEMENT LOADING SCENARIOS.
- (3) PLANTER AREA PER LANDSCAPE DRAWINGS.
- (4) CONSTRUCT CONCRETE CURB PER DETAIL 2 ON SHEET
- (7) NEW STRIPING PER ARCHITECTURAL DRAWINGS.
- (8) NEW CONCRETE WALL PER LANDSCAPE DRAWINGS.
- (9) INSTALL BOLLARDS PER LANDSCAPE DRAWINGS.
- (10) CONSTRUCT CURB RAMP PER DETAIL 1 TYPE-C ON SHEET C-5.1.
- 11) INSTALL TRUNCATED DOMES PER DETAIL 8 ON SHEET
- (12) CONSTRUCT CURB RAMP PER DETAIL 1 TYPE-D ON
- (13) CONSTRUCT CURB AND GUTTER PER DETAIL 3 ON
- SHEET C-5.1. 18) NEW COBBLE STONE PAVING PER LANDSCAPE

SHEET C-5.1.

- DRAWINGS. (19) NEW BIOFILTRATION AREA PER DETAIL 1 ON SHEET
- C-5.2. BIOFILTRATION BMP TO BE INSTALLED IN PHASE 1.
- (20) CONSTRUCT NEW CONCRETE GRAVITY CURB PER DETAIL 7 ON SHEET C-5.0.
- (21) CONSTRUCT CURB SLOT PER DETAIL 2 ON SHEET
- (22) NEW GUARDRAIL FENCING PER LANDSCAPE DRAWINGS.
- NEW PASSENGER LOADING ZONE STRIPING PER ARCHITECTURAL DRAWINGS.
- (27) NEW TRASH RECEPTACLE AND CONCRETE PAD PER LANDSCAPE DRAWINGS. SEE DETAIL 6 ON SHEET L-2.01 FOR REFERENCE.
- 28 RELOCATED BOOK DROP PER ARCHITECTURAL AND LANDSCAPE DRAWINGS. SEE DETAIL 7 ON SHEET
- NEW LOCATION OF PARKING KIOSK AND SIGNAGE. SEE ARCHITECTURAL DRAWINGS FOR REFERENCE. NEW CONCRETE PAD PER DETAIL 5 ON SHEET C-5.2.
- 31) REINSTALL EXISTING WHEEL STOPS PER ARCHITECTURAL DRAWINGS.
- (32) OVERLAY WITH NEW LAYERS OF AC PAVEMENT PER DETAIL 5 ON SHEET C-5.1.
- (33) INSTALL NEW SLURRY COAT PER DETAIL 6 ON SHEET C-5.1. CRACKS MORE THAN  $\frac{1}{2}$  INCH WIDE, LOW AREA, HOLES OR DEPRESSIONS IN EXISTING SURFACING SHALL BE REPAIRED PRIOR TO INSTALLATION OF A SLURRY SEAL.
  - 35) CONSTRUCT V-GUTTER PER DETAIL 3 ON SHEET

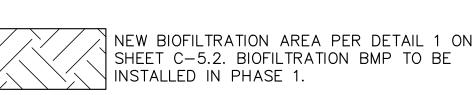

SHEET C-5.2. BIOFILTRATION BMP TO BE

NEW CONCRETE WALL PER LANDSCAPE DRAWINGS.

> NEW STRIPING PER ARCHITECTURAL DRAWINGS.

INSTALL TRUNCATED DOMES PER DETAIL 8 ON SHEET C-5.0.

### SHEET NOTES:

- . FOR GENERAL NOTES, LEGEND AND ABBREVIATIONS, SEE SHEET
- 2. SEE ARCHITECTURAL, ELECTRICAL AND LANDSCAPE DRAWINGS FOR OTHER SITE RELATED DIMENSIONS AND GRID LINES NOT SHOWN ON THIS DRAWING.
- 3. FOR ANY TRANSITION FROM PHASE 1 TO PHASE 2, CONSTRUCT ASPHALT PAVEMENT AT LESS THAN 5% MAXIMUM AS REQUIRED.
- 1. CONTRACTOR TO USE AND VERIFY BENCHMARK, HORIZONTAL AND VERTICAL CONTROL SET FOR BY HUITT-ZOLLARS AND CANNON TOPOGRAPHIC SURVEYS. CONTRACTOR TO DETERMINE WHICH BENCHMARK, HORIZONTAL AND VERTICAL CONTROL BASED OFF THE PROVIDED SURVEY FROM HUITT-ZOLLARS AND CANNON. ALONG WITH THE SCOPE OF WORK SHOWN ON THE DRAWINGS. CONTRACTOR TO NOTIFY DISTRICT AND DESIGN TEAM IF ANY DISCREPANCY IS ENCOUNTERED PRIOR TO POURING SITE FLATWORK.
- 5. SEE ENLARGED FIRE ACCESS PLAN ON ARCHITECTURAL SHEET A-0.01 FOR FIRE LANE DELINEATION.
- 6. SEE ENLARGED SIGNAGE PLAN ON ARCHITECTURAL SHEET A-0.30 FOR SIGNAGE LEGEND AND LOCATIONS.
- 7. FOR EXISTING CONDITIONS, SEE "TOPOGRAPHIC SURVEY" PROVIDED BY HUITT-ZOLLARS (10/29/20) - JOB# R306455.01 AND "TOPOGRAPHIC SURVEY MAP" PROVIDED BY CANNON (4/2/21) - JOB# 16035.00.

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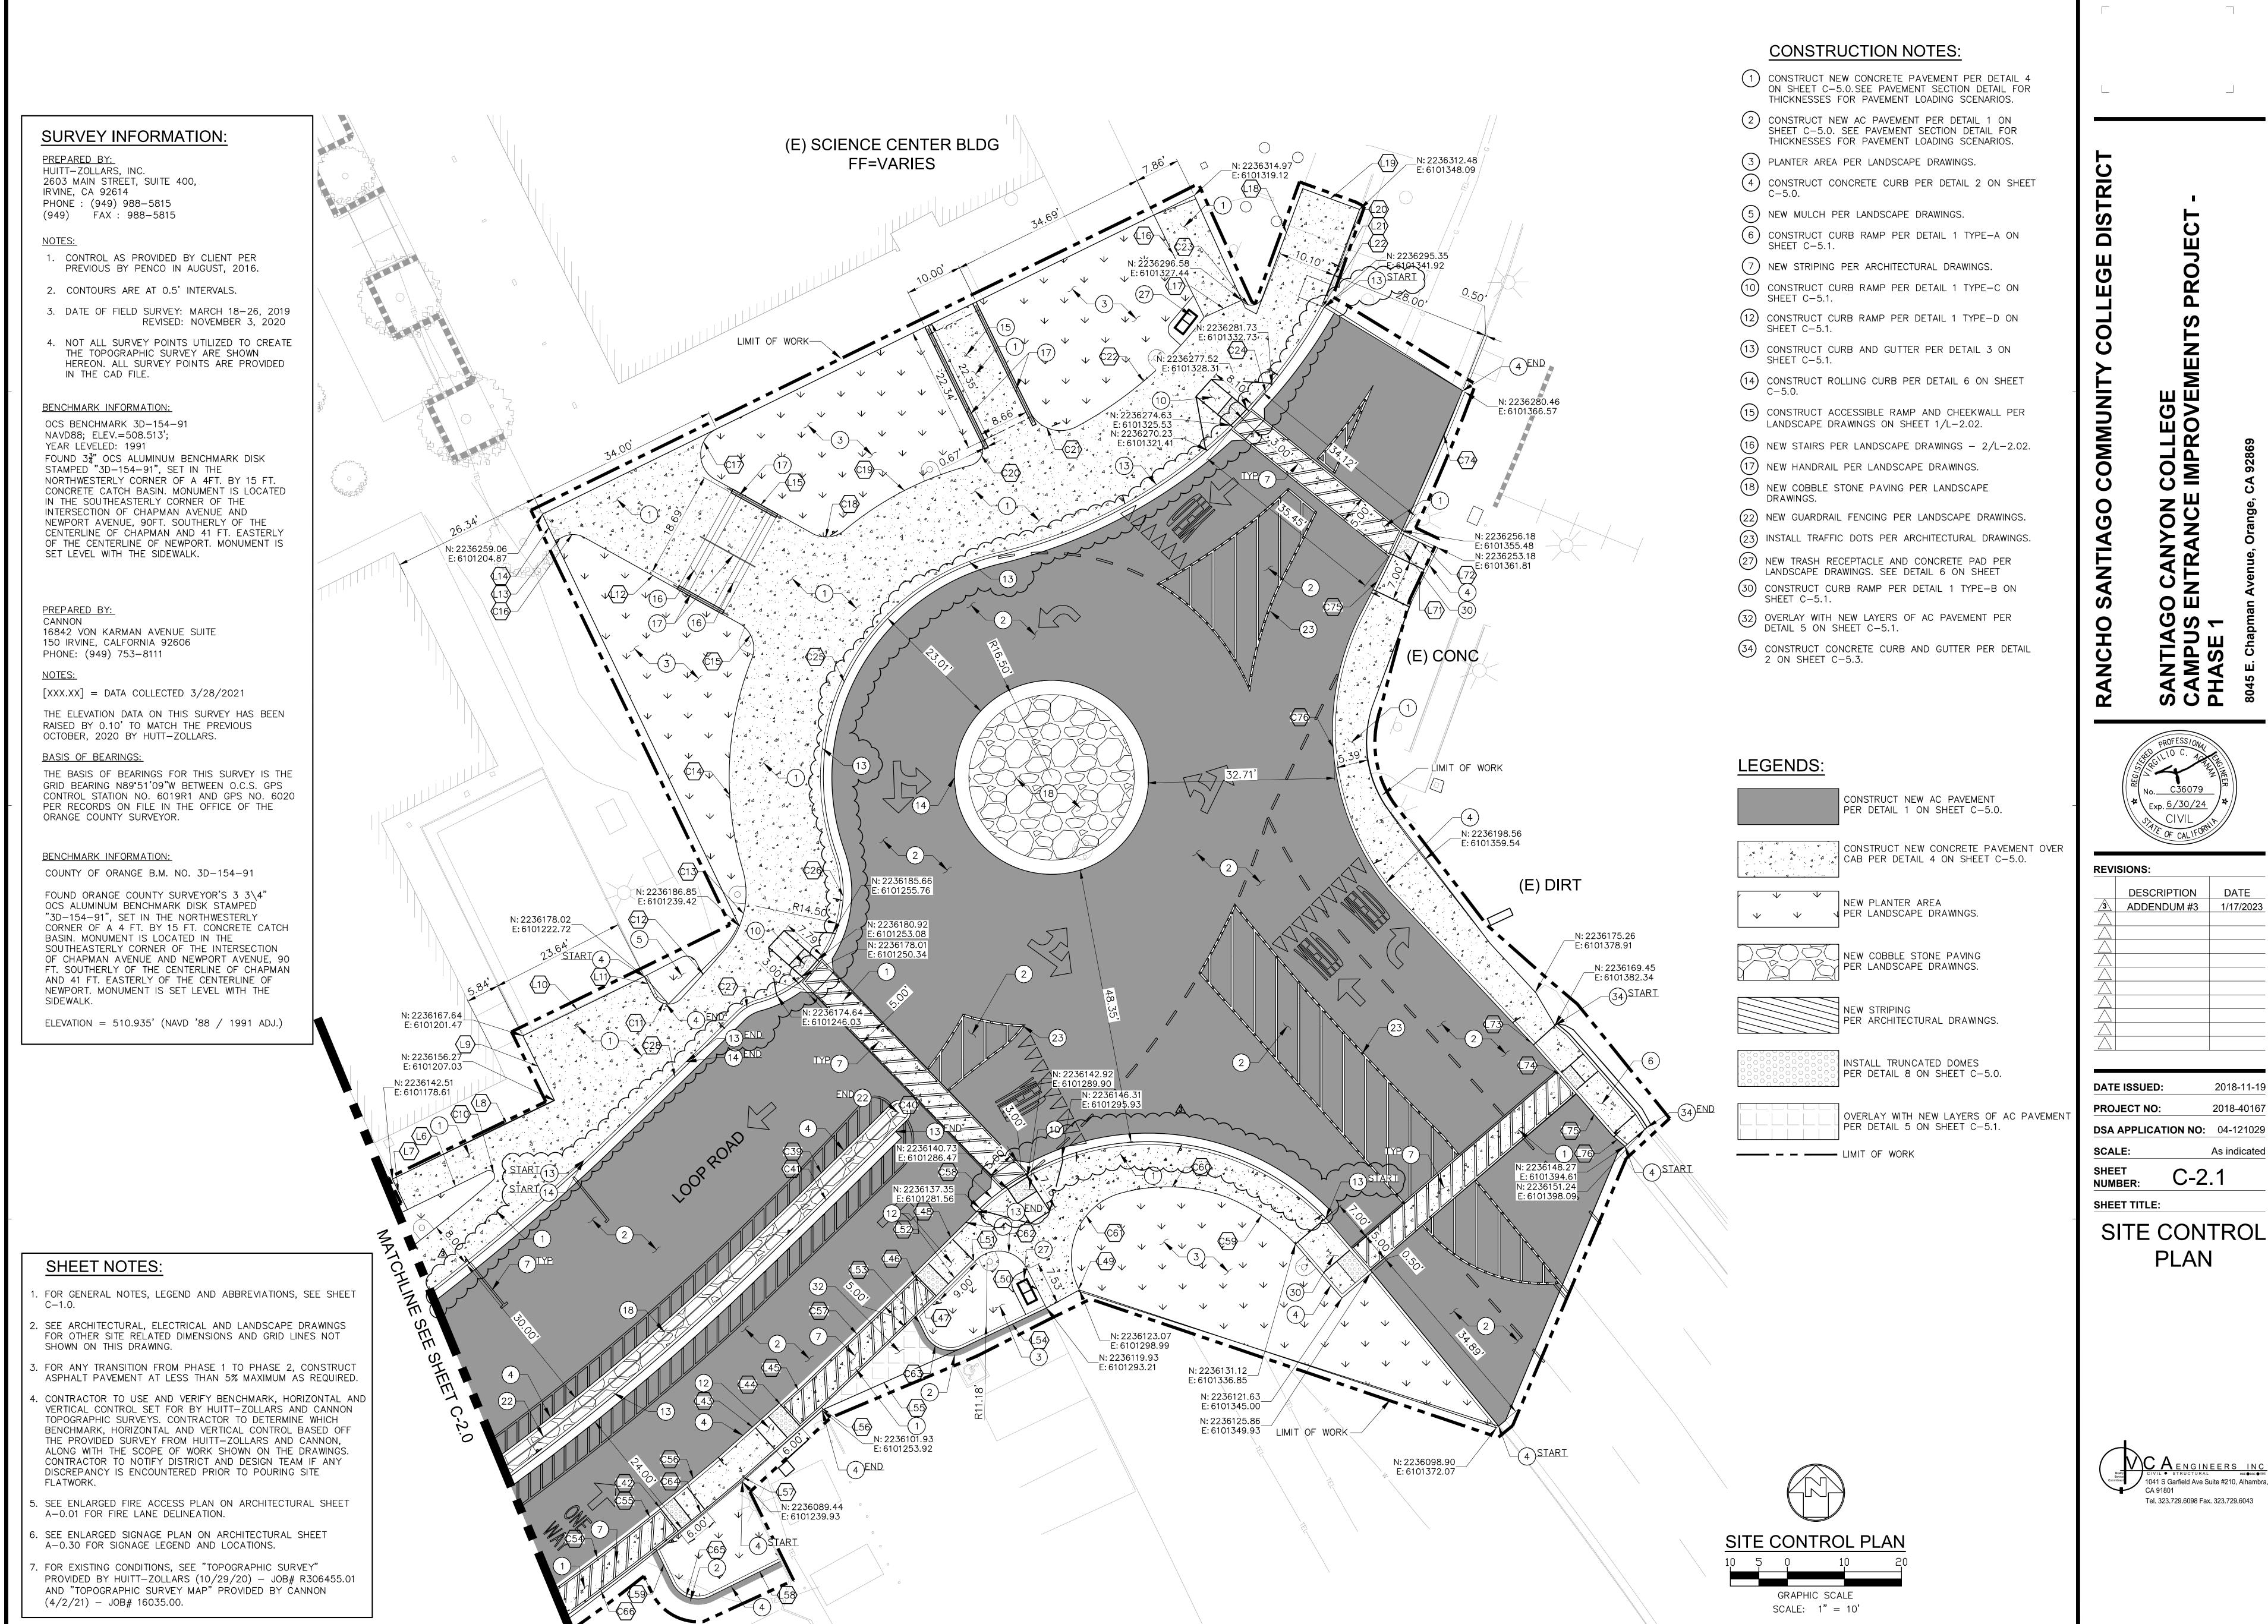
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2018-11-19 **DATE ISSUED: PROJECT NO:** 2018-40167 **DSA APPLICATION NO:** 04-121029 **SCALE:** As indicated

C-2.0 **NUMBER:** SHEET TITLE:

SITE CONTROL PLAN





C-2.1 NUMBER: SHEET TITLE:

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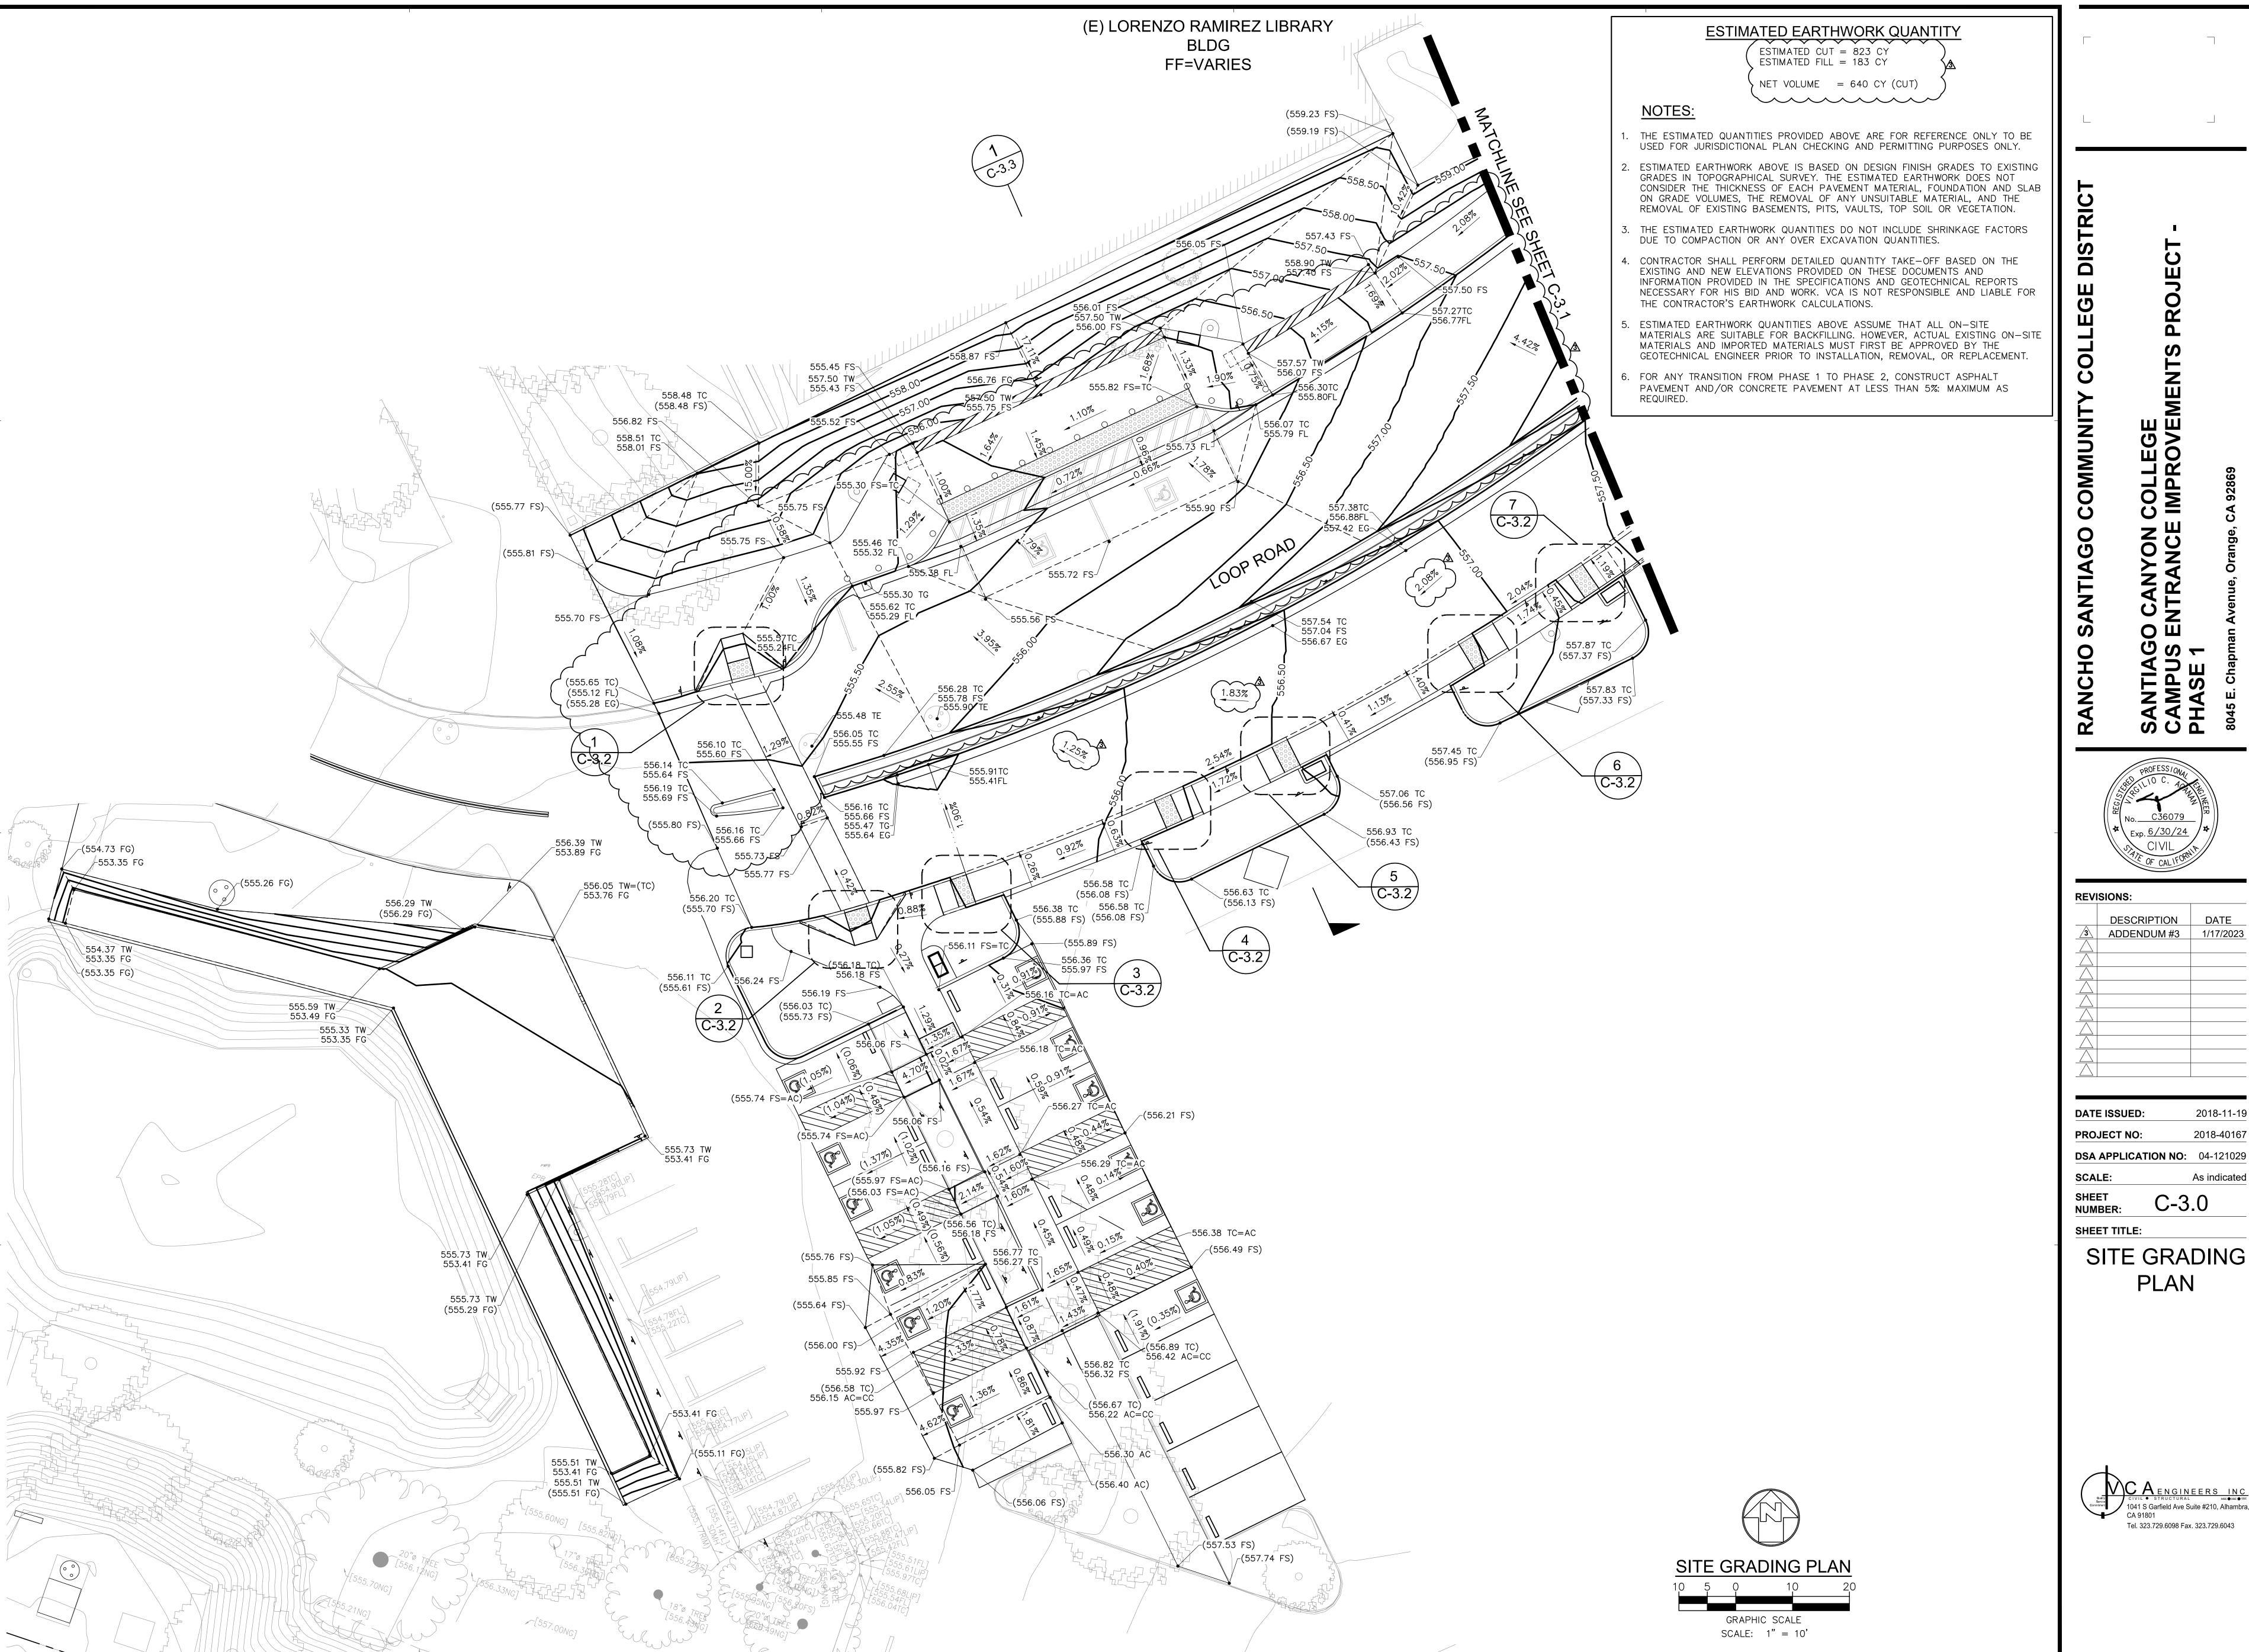
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SITE CONTROL PLAN





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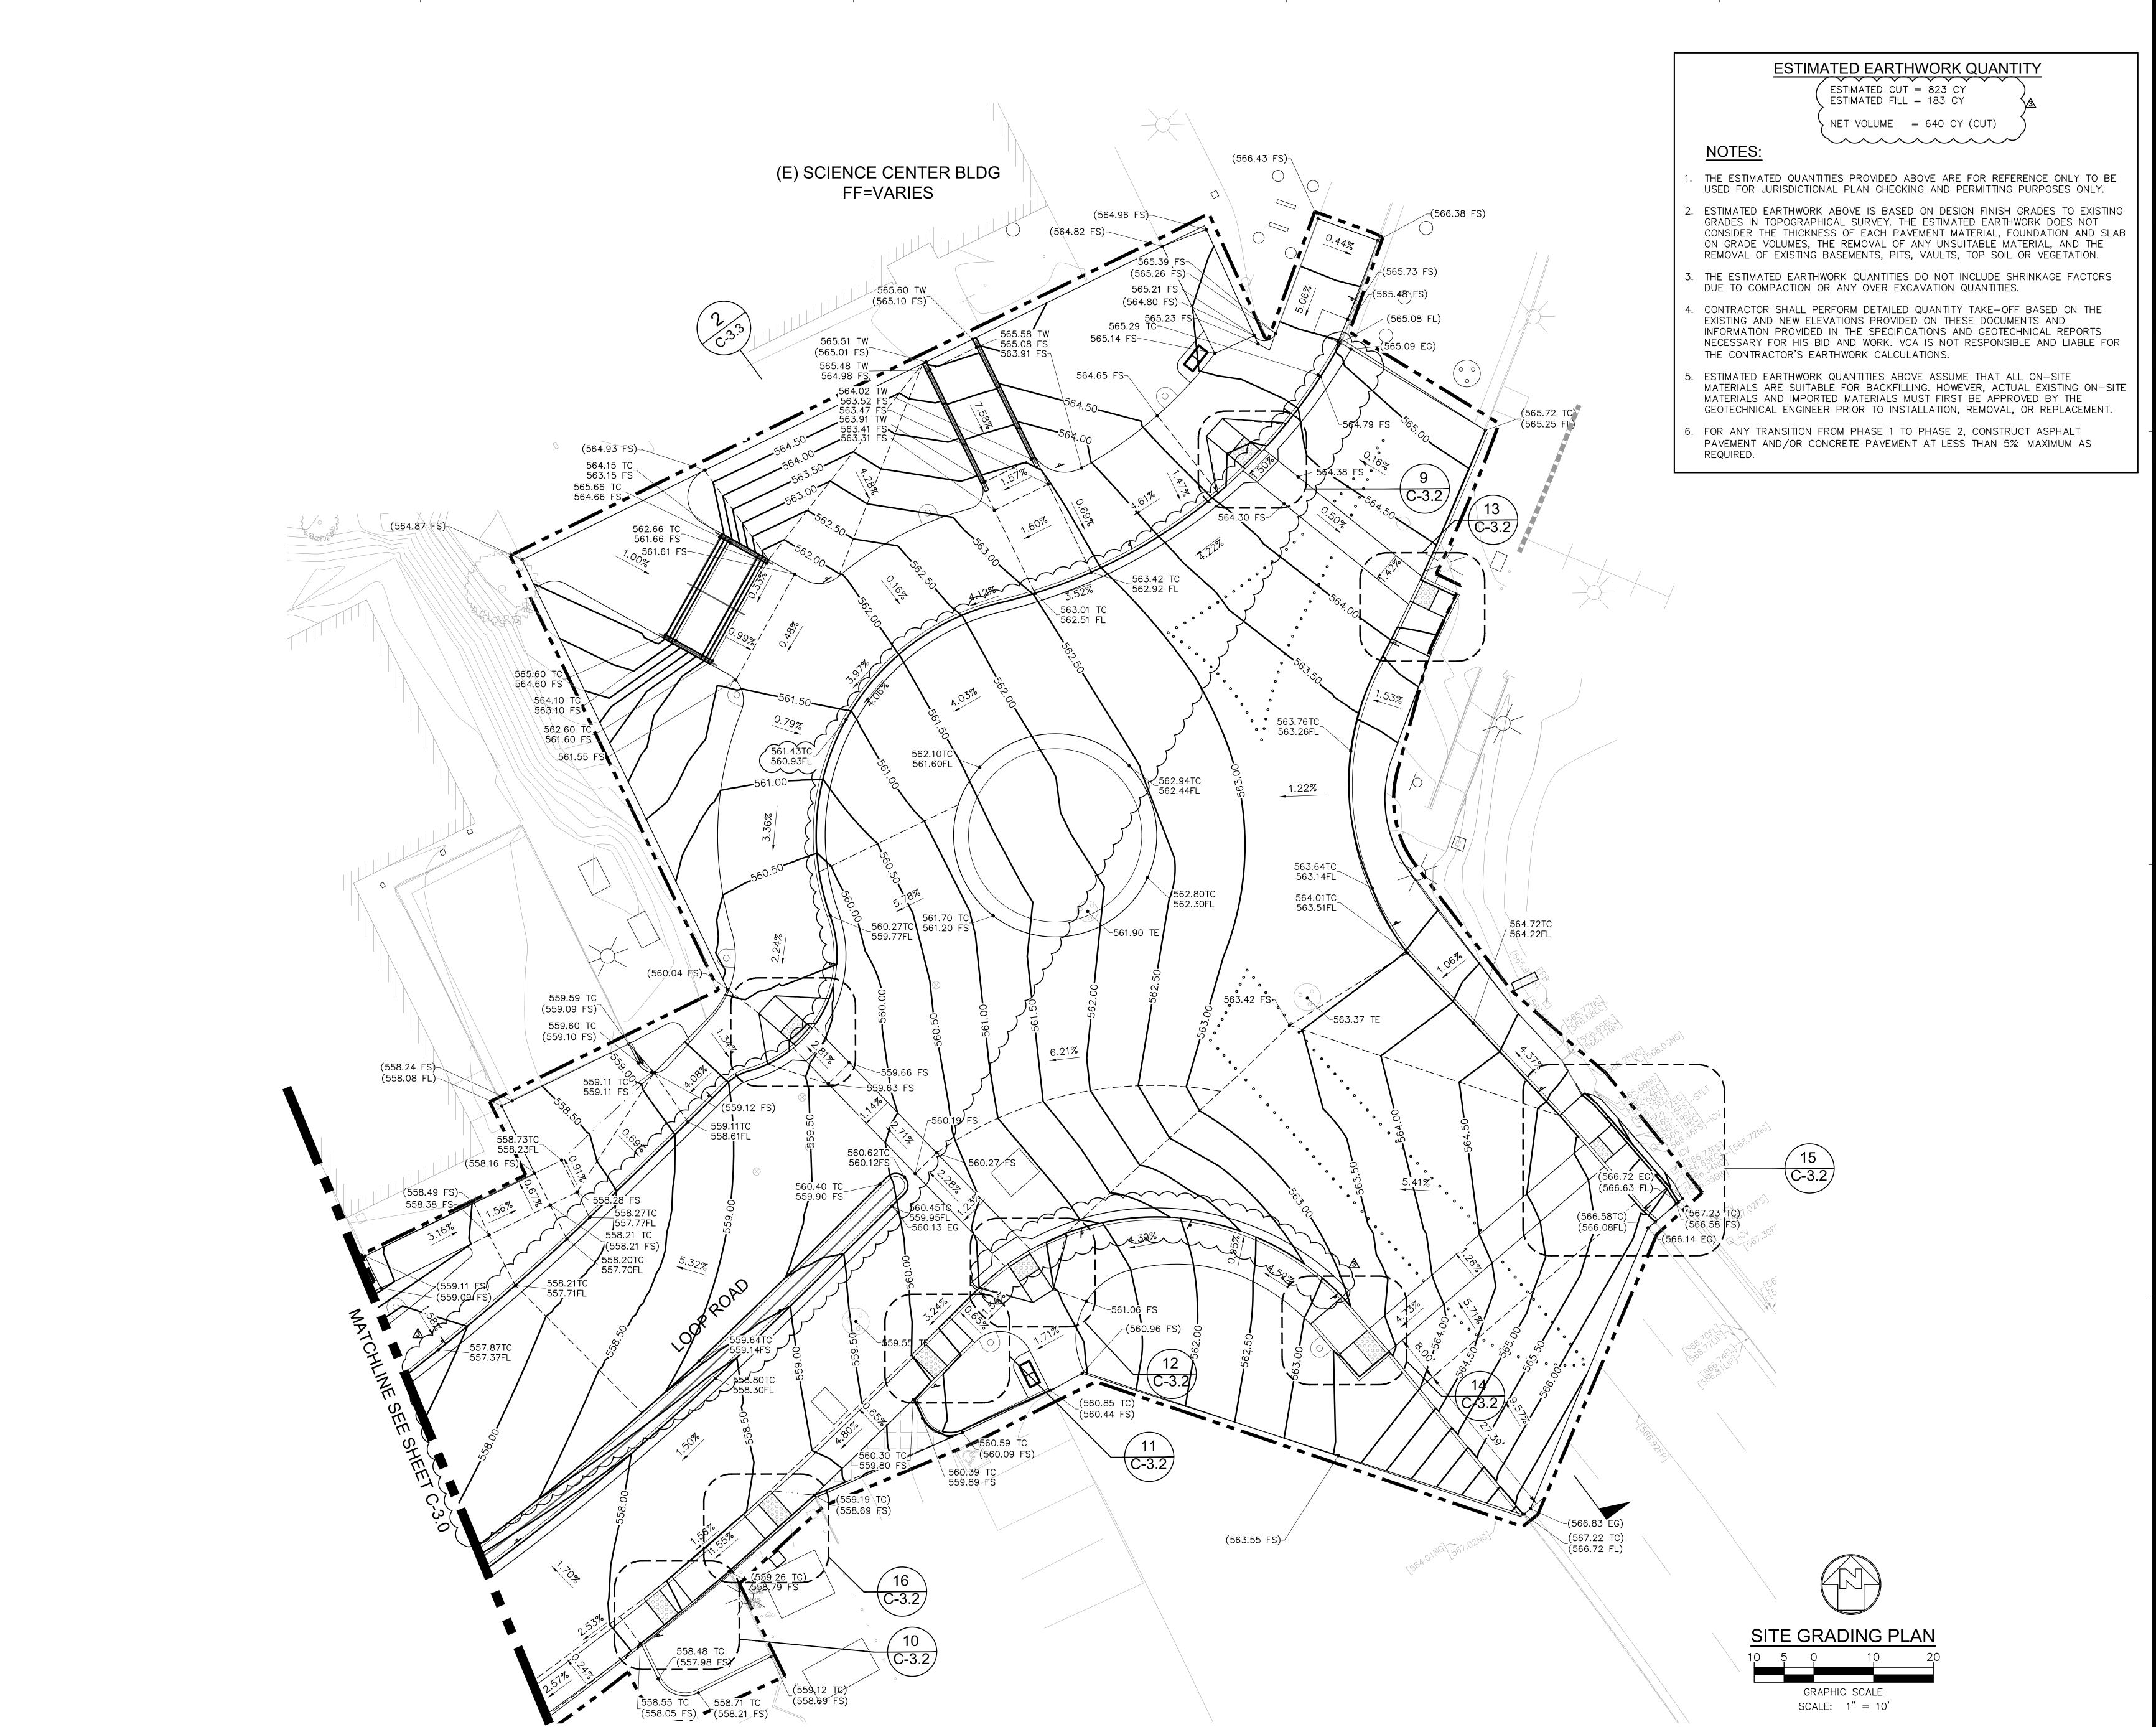
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**DATE ISSUED:** 2018-11-19 PROJECT NO: 2018-40167

As indicated C-3.0

SITE GRADING PLAN





## RANCHO SAN HAGO COMIMUNI Y COLLEGE DISTRI

SANTIAGO CANYON COLLEGE
CAMPUS ENTRANCE IMPROVEM
PHASE 1

REVISIONS:

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 DATE ISSUED:
 2018-11-19

 PROJECT NO:
 2018-40167


 DSA APPLICATION NO:
 04-121029

SHEET TITLE:

SHEET TITLE:

SITE GRADING PLAN



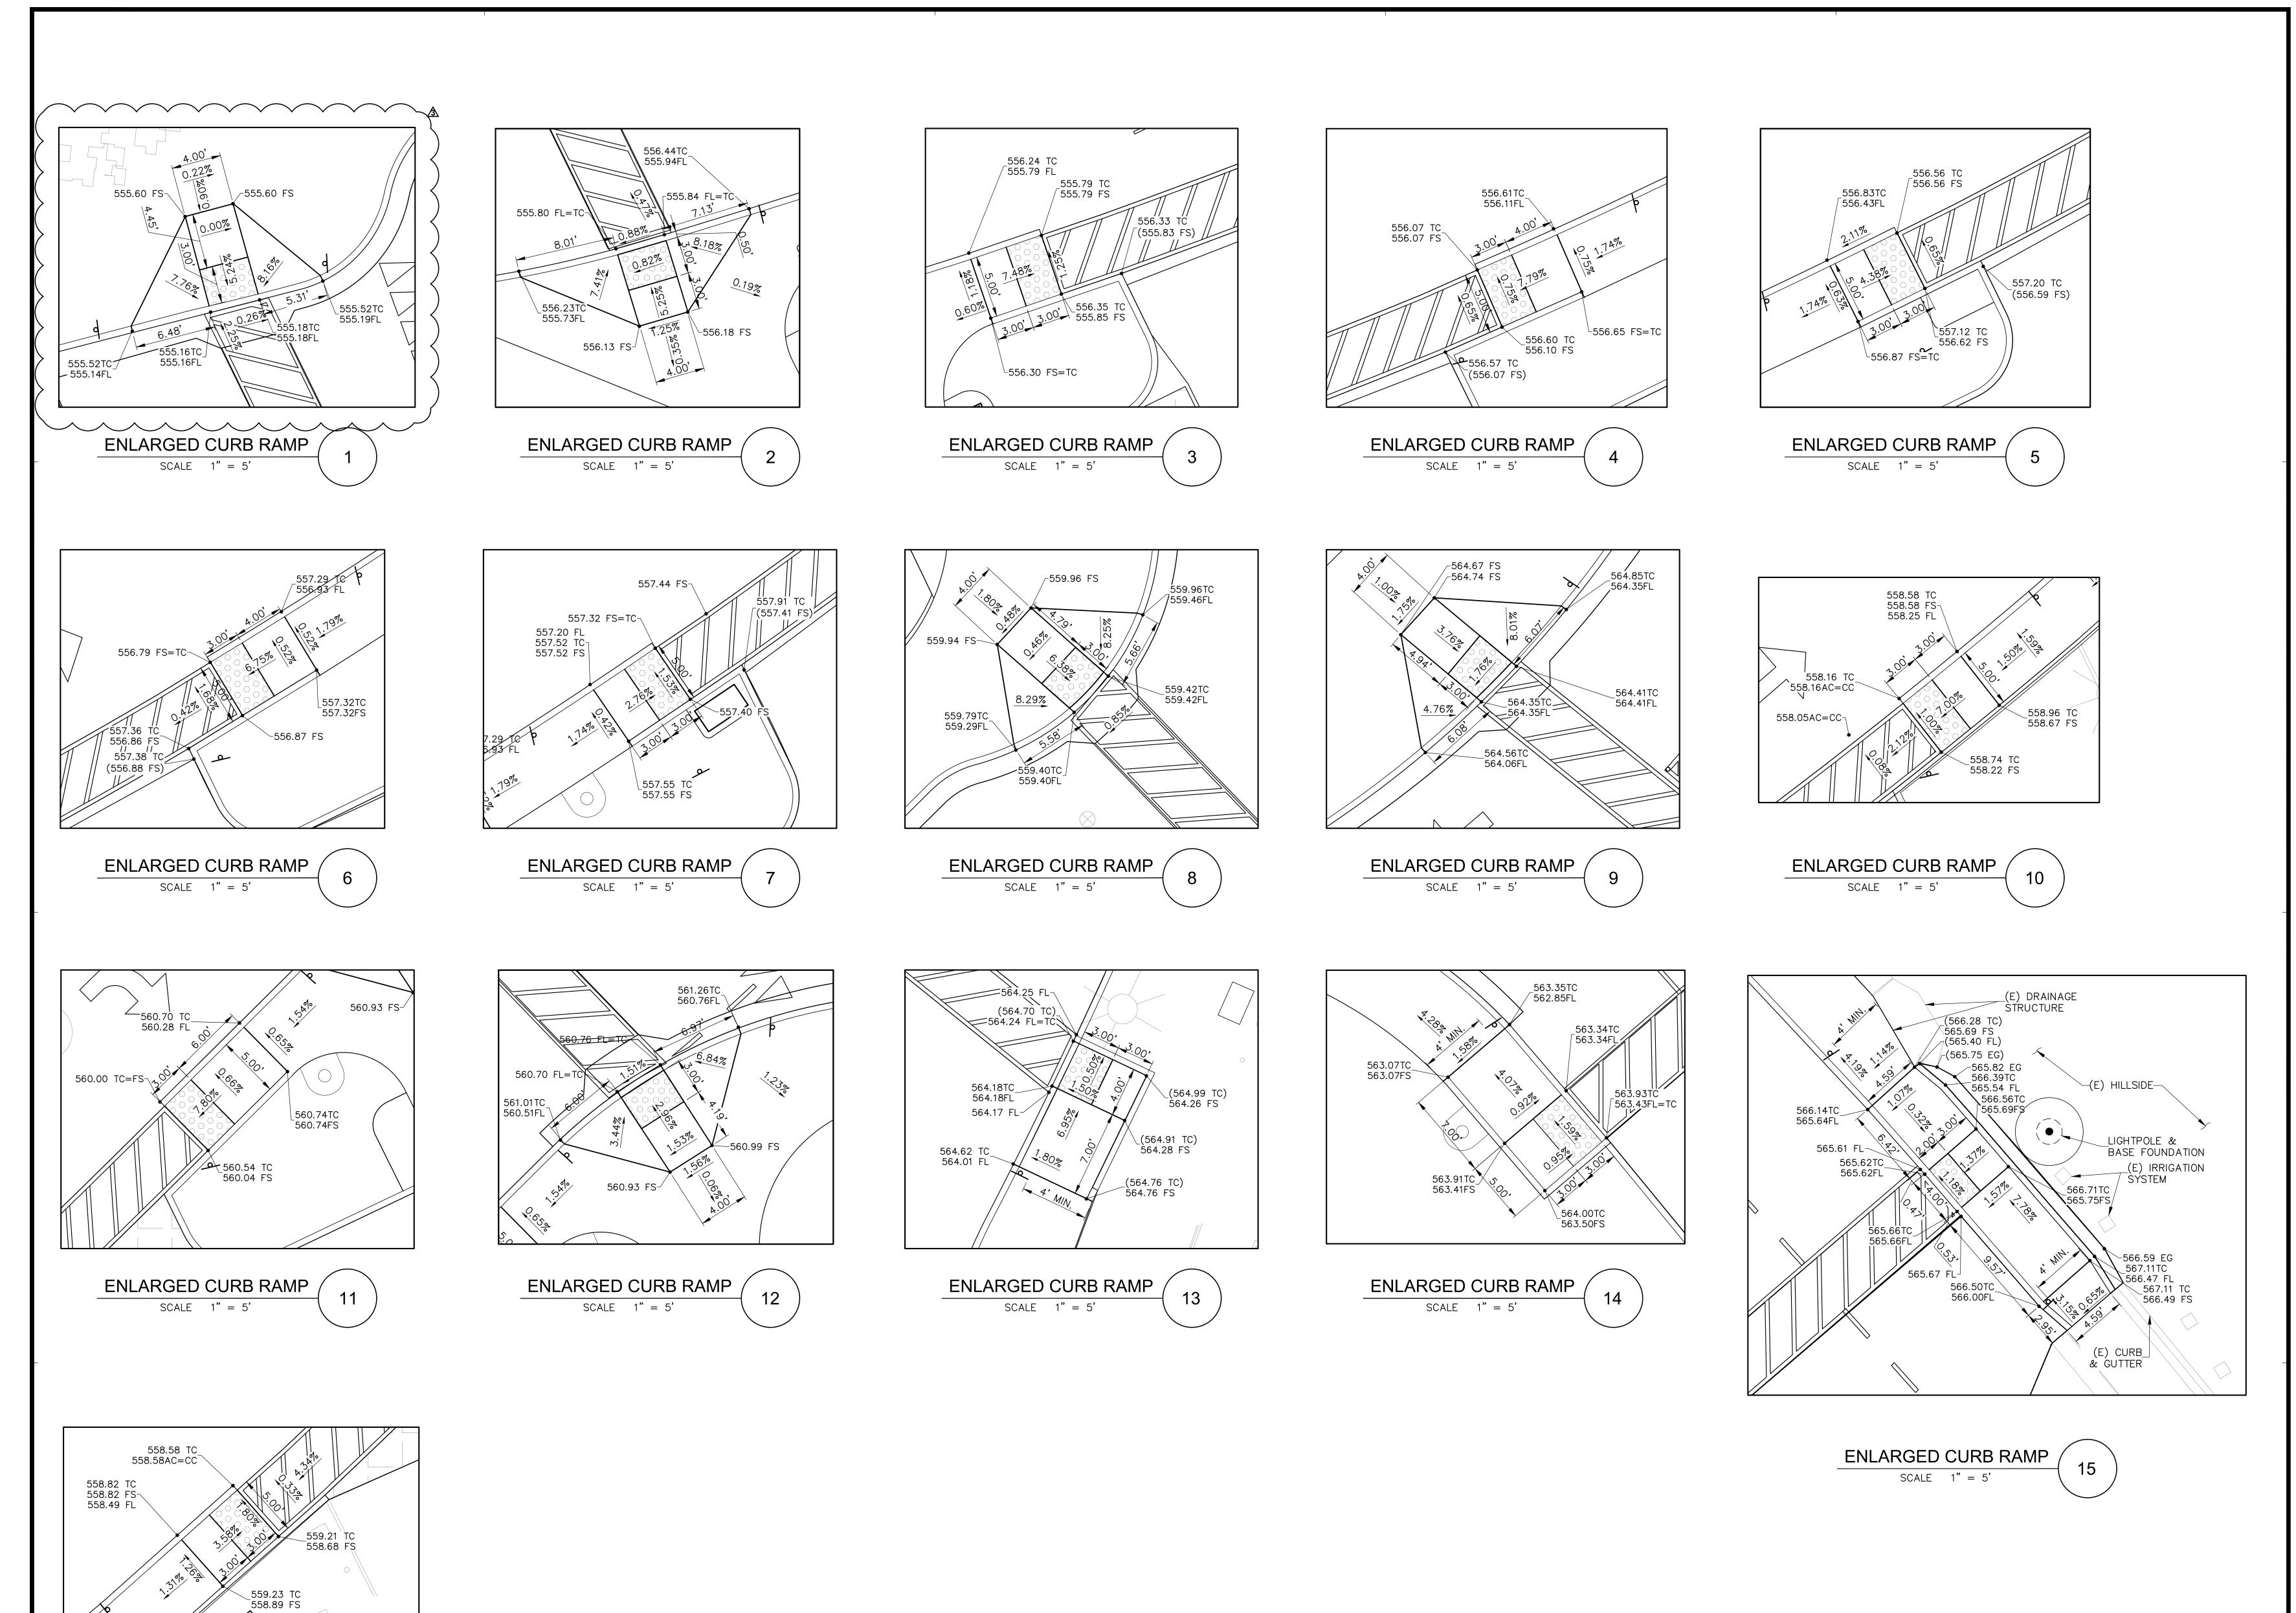

**ENLARGED CURB RAMP** 

# RANCHO SANTIAGO COMMUNITY COLLEGE DISTRIC SANTIAGO CANYON COLLEGE CAMPUS ENTRANCE IMPROVEMENTS PROJECT -

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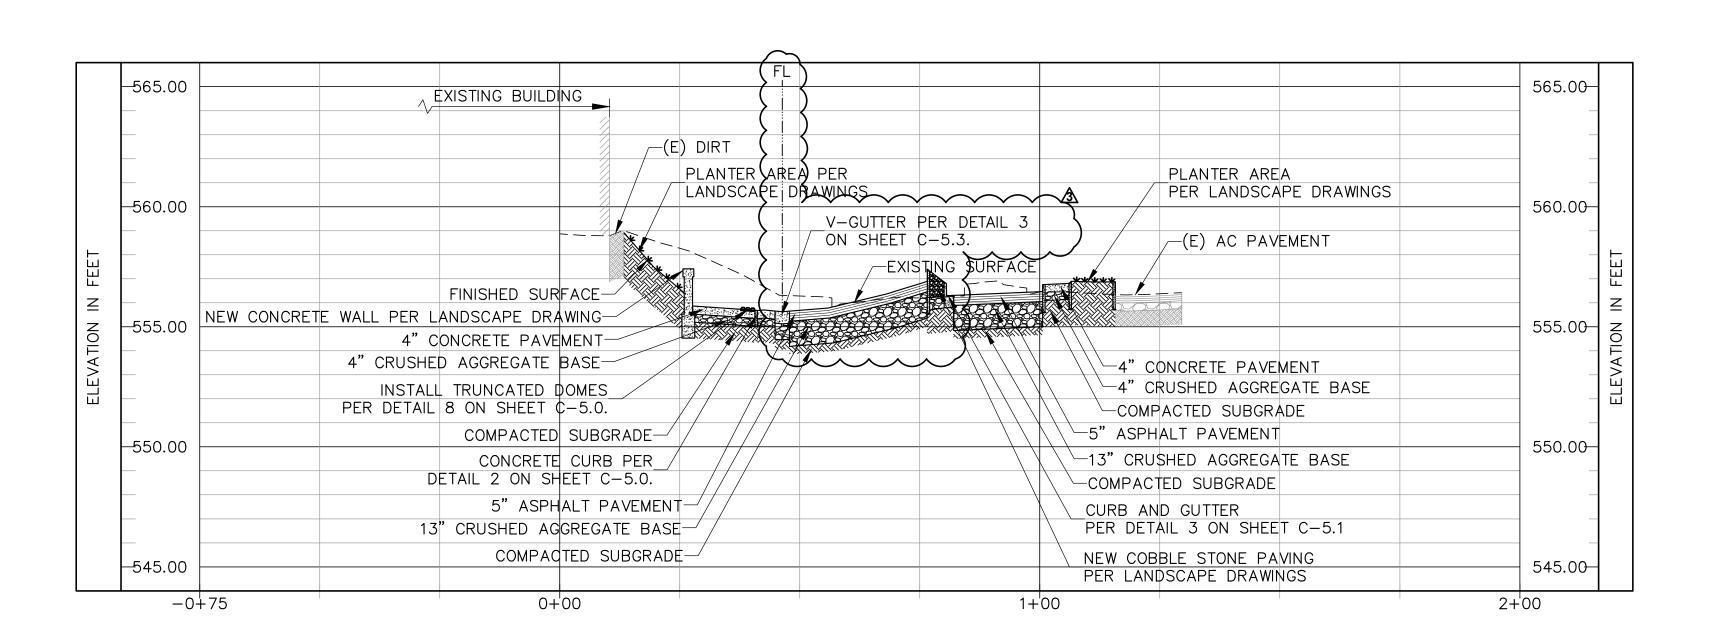
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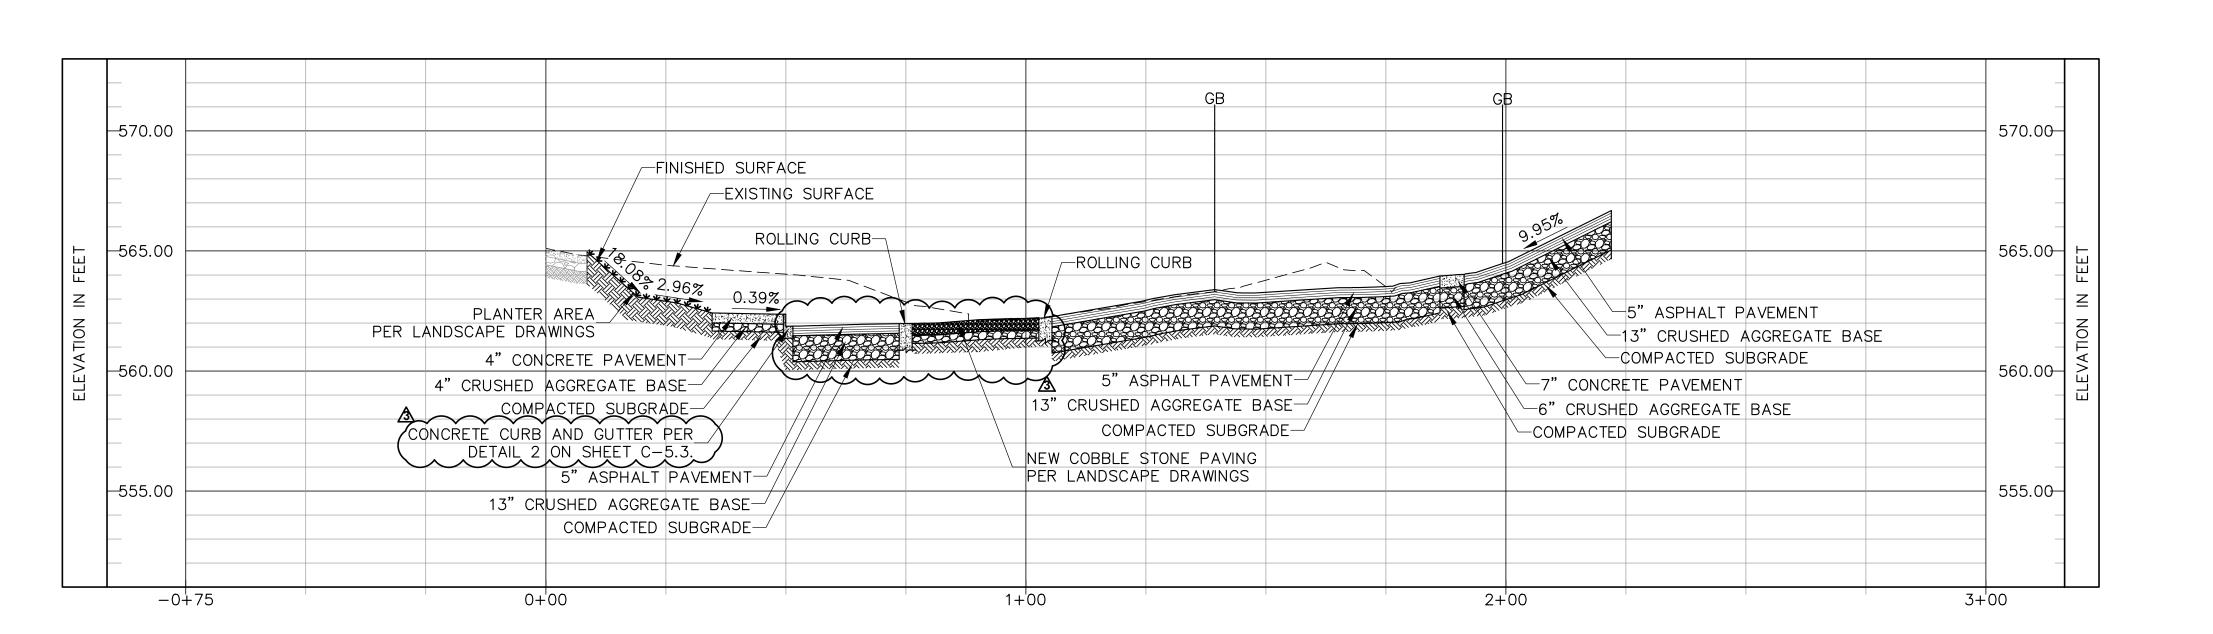
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ENLARGED SITE GRADING PLAN











# RANCHO SANTIAGO COMMUNITY COLLEGE DISTRICT

SANTIAGO CANYON COLLEGE
CAMPUS ENTRANCE IMPROVEMENTS PRO
PHASE 1

STATE OF CALL

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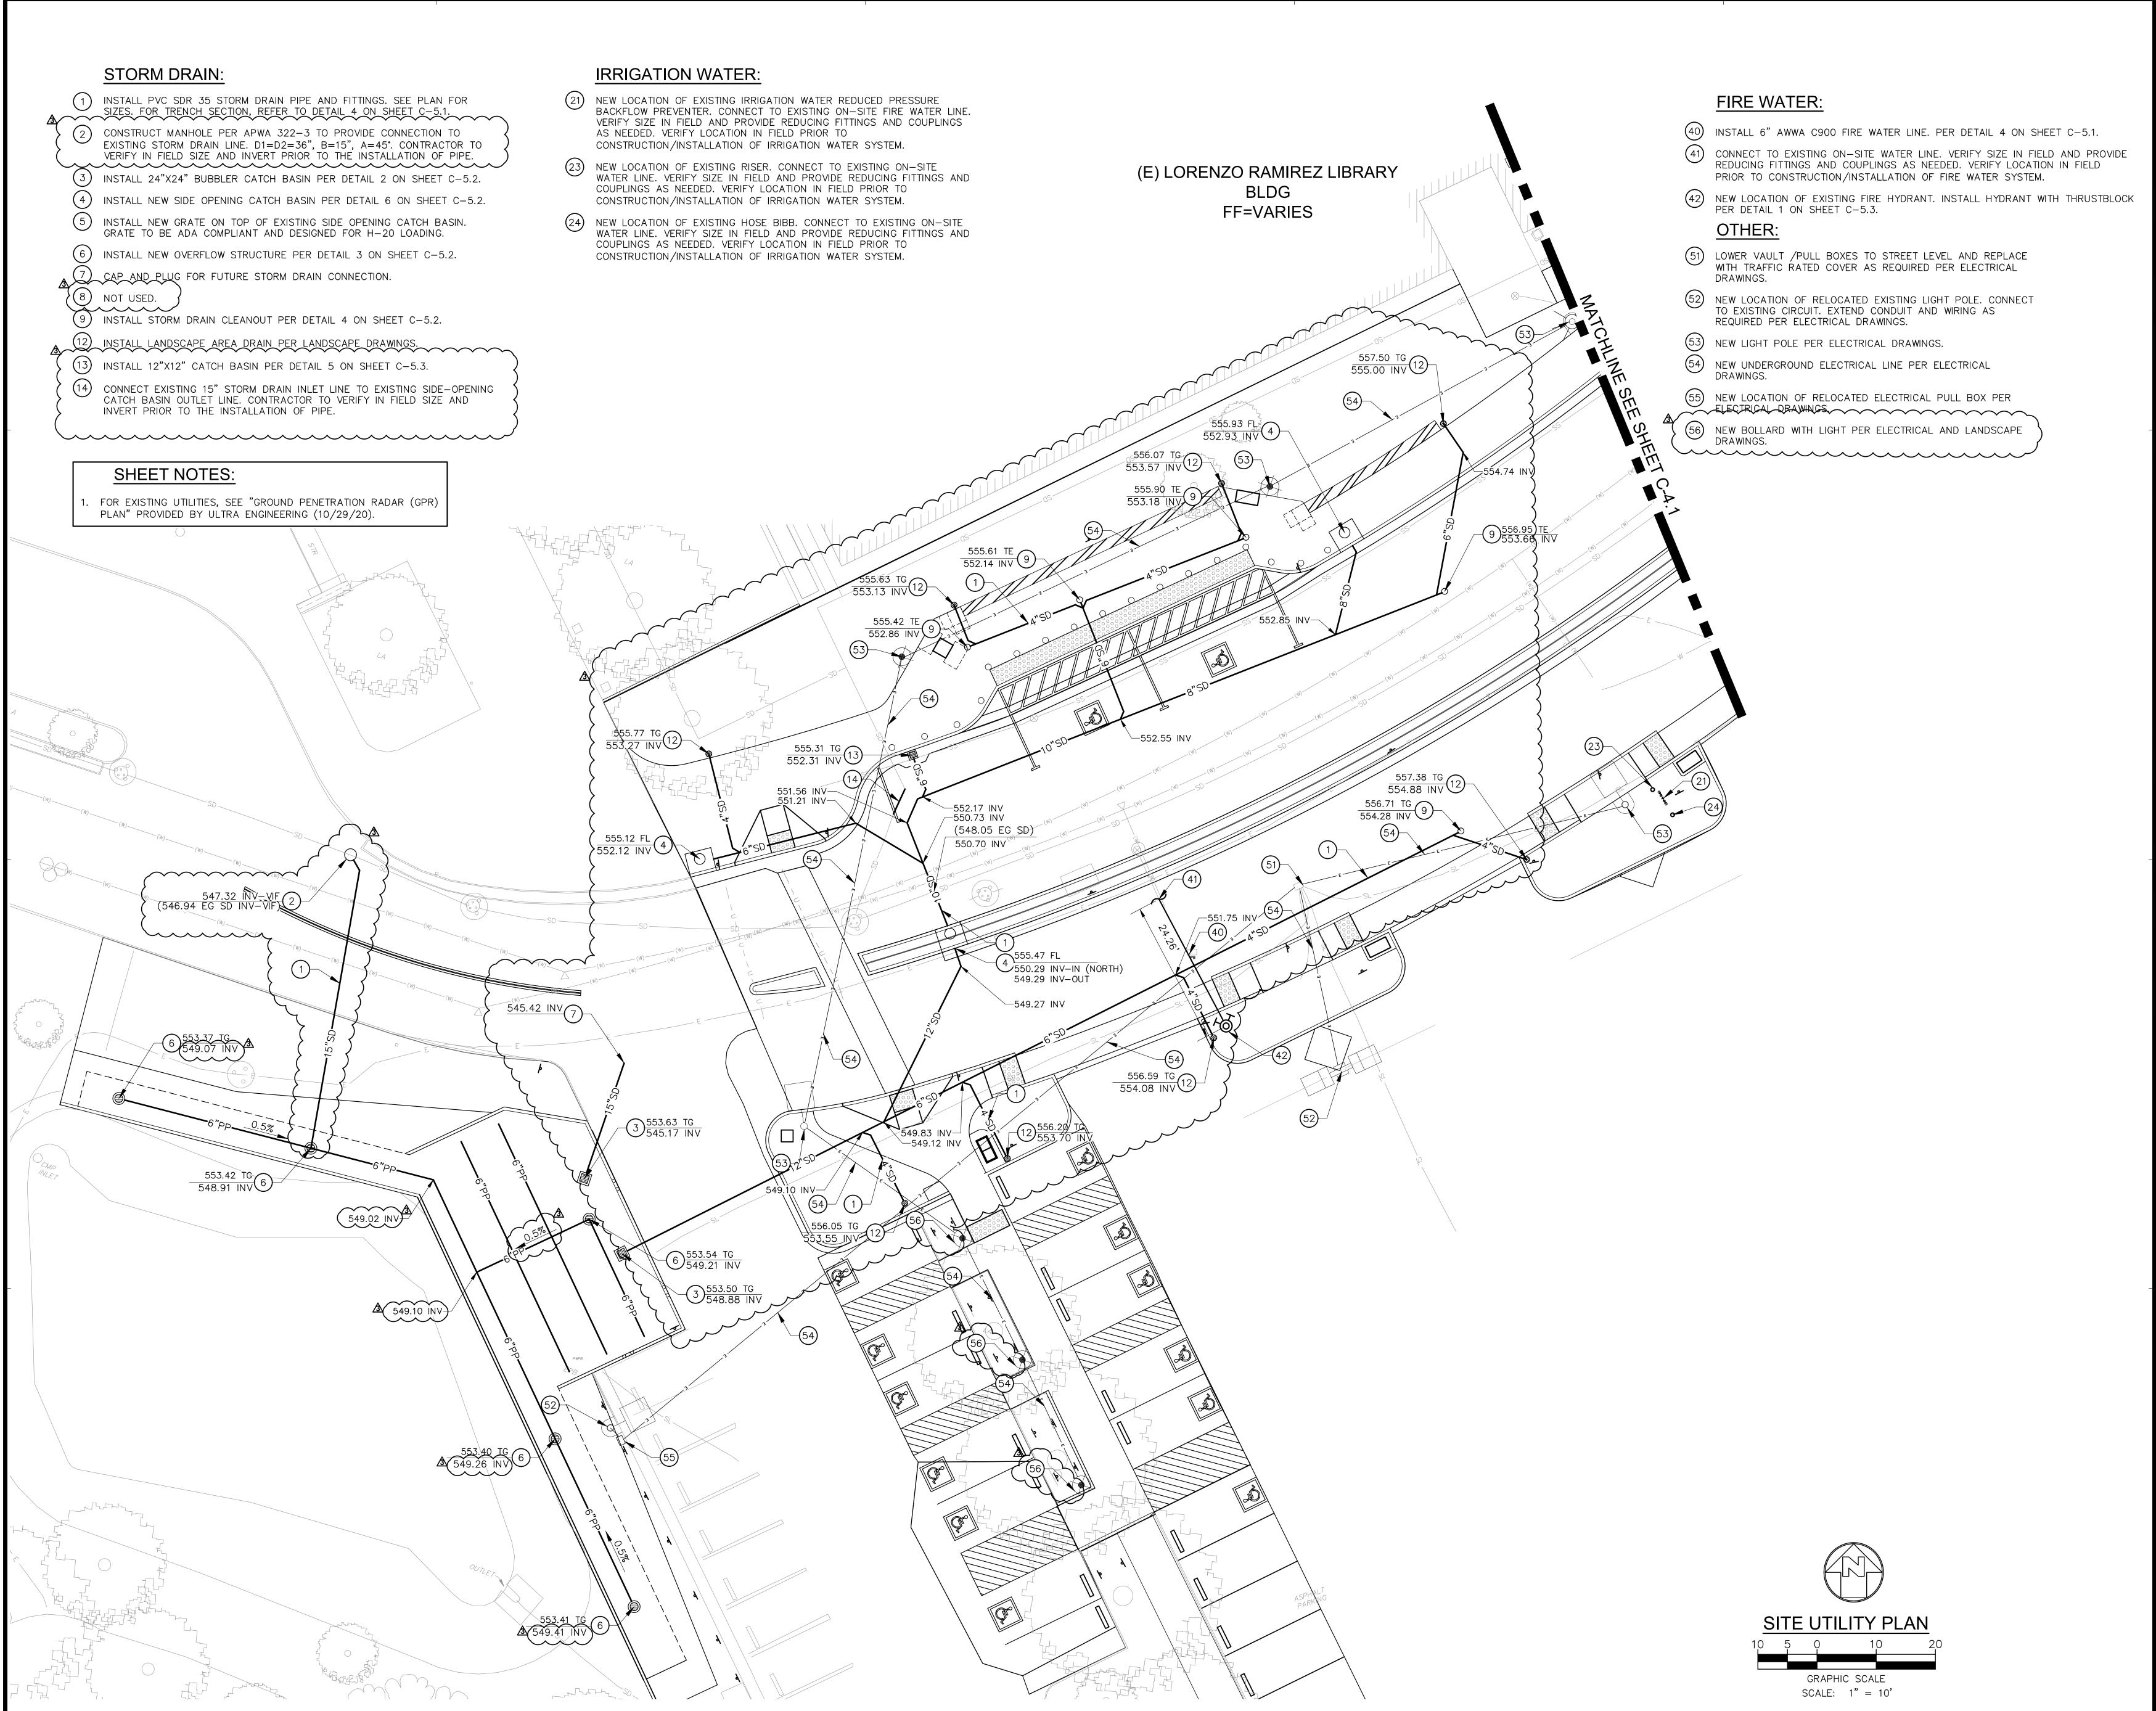
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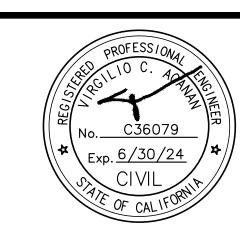
SITE GRADING SECTIONS

C-3.3





SANTIAGO CANYON COLLEGE
CAMPUS ENTRANCE IMPROVEMENTS



DESCRIPTION

ADDENDUM #3

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PROJECT NO: 2018-40167

DSA APPLICATION NO: 04-121029


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NUMBER: SHEET TITLE:

SITE UTILITY PLAN





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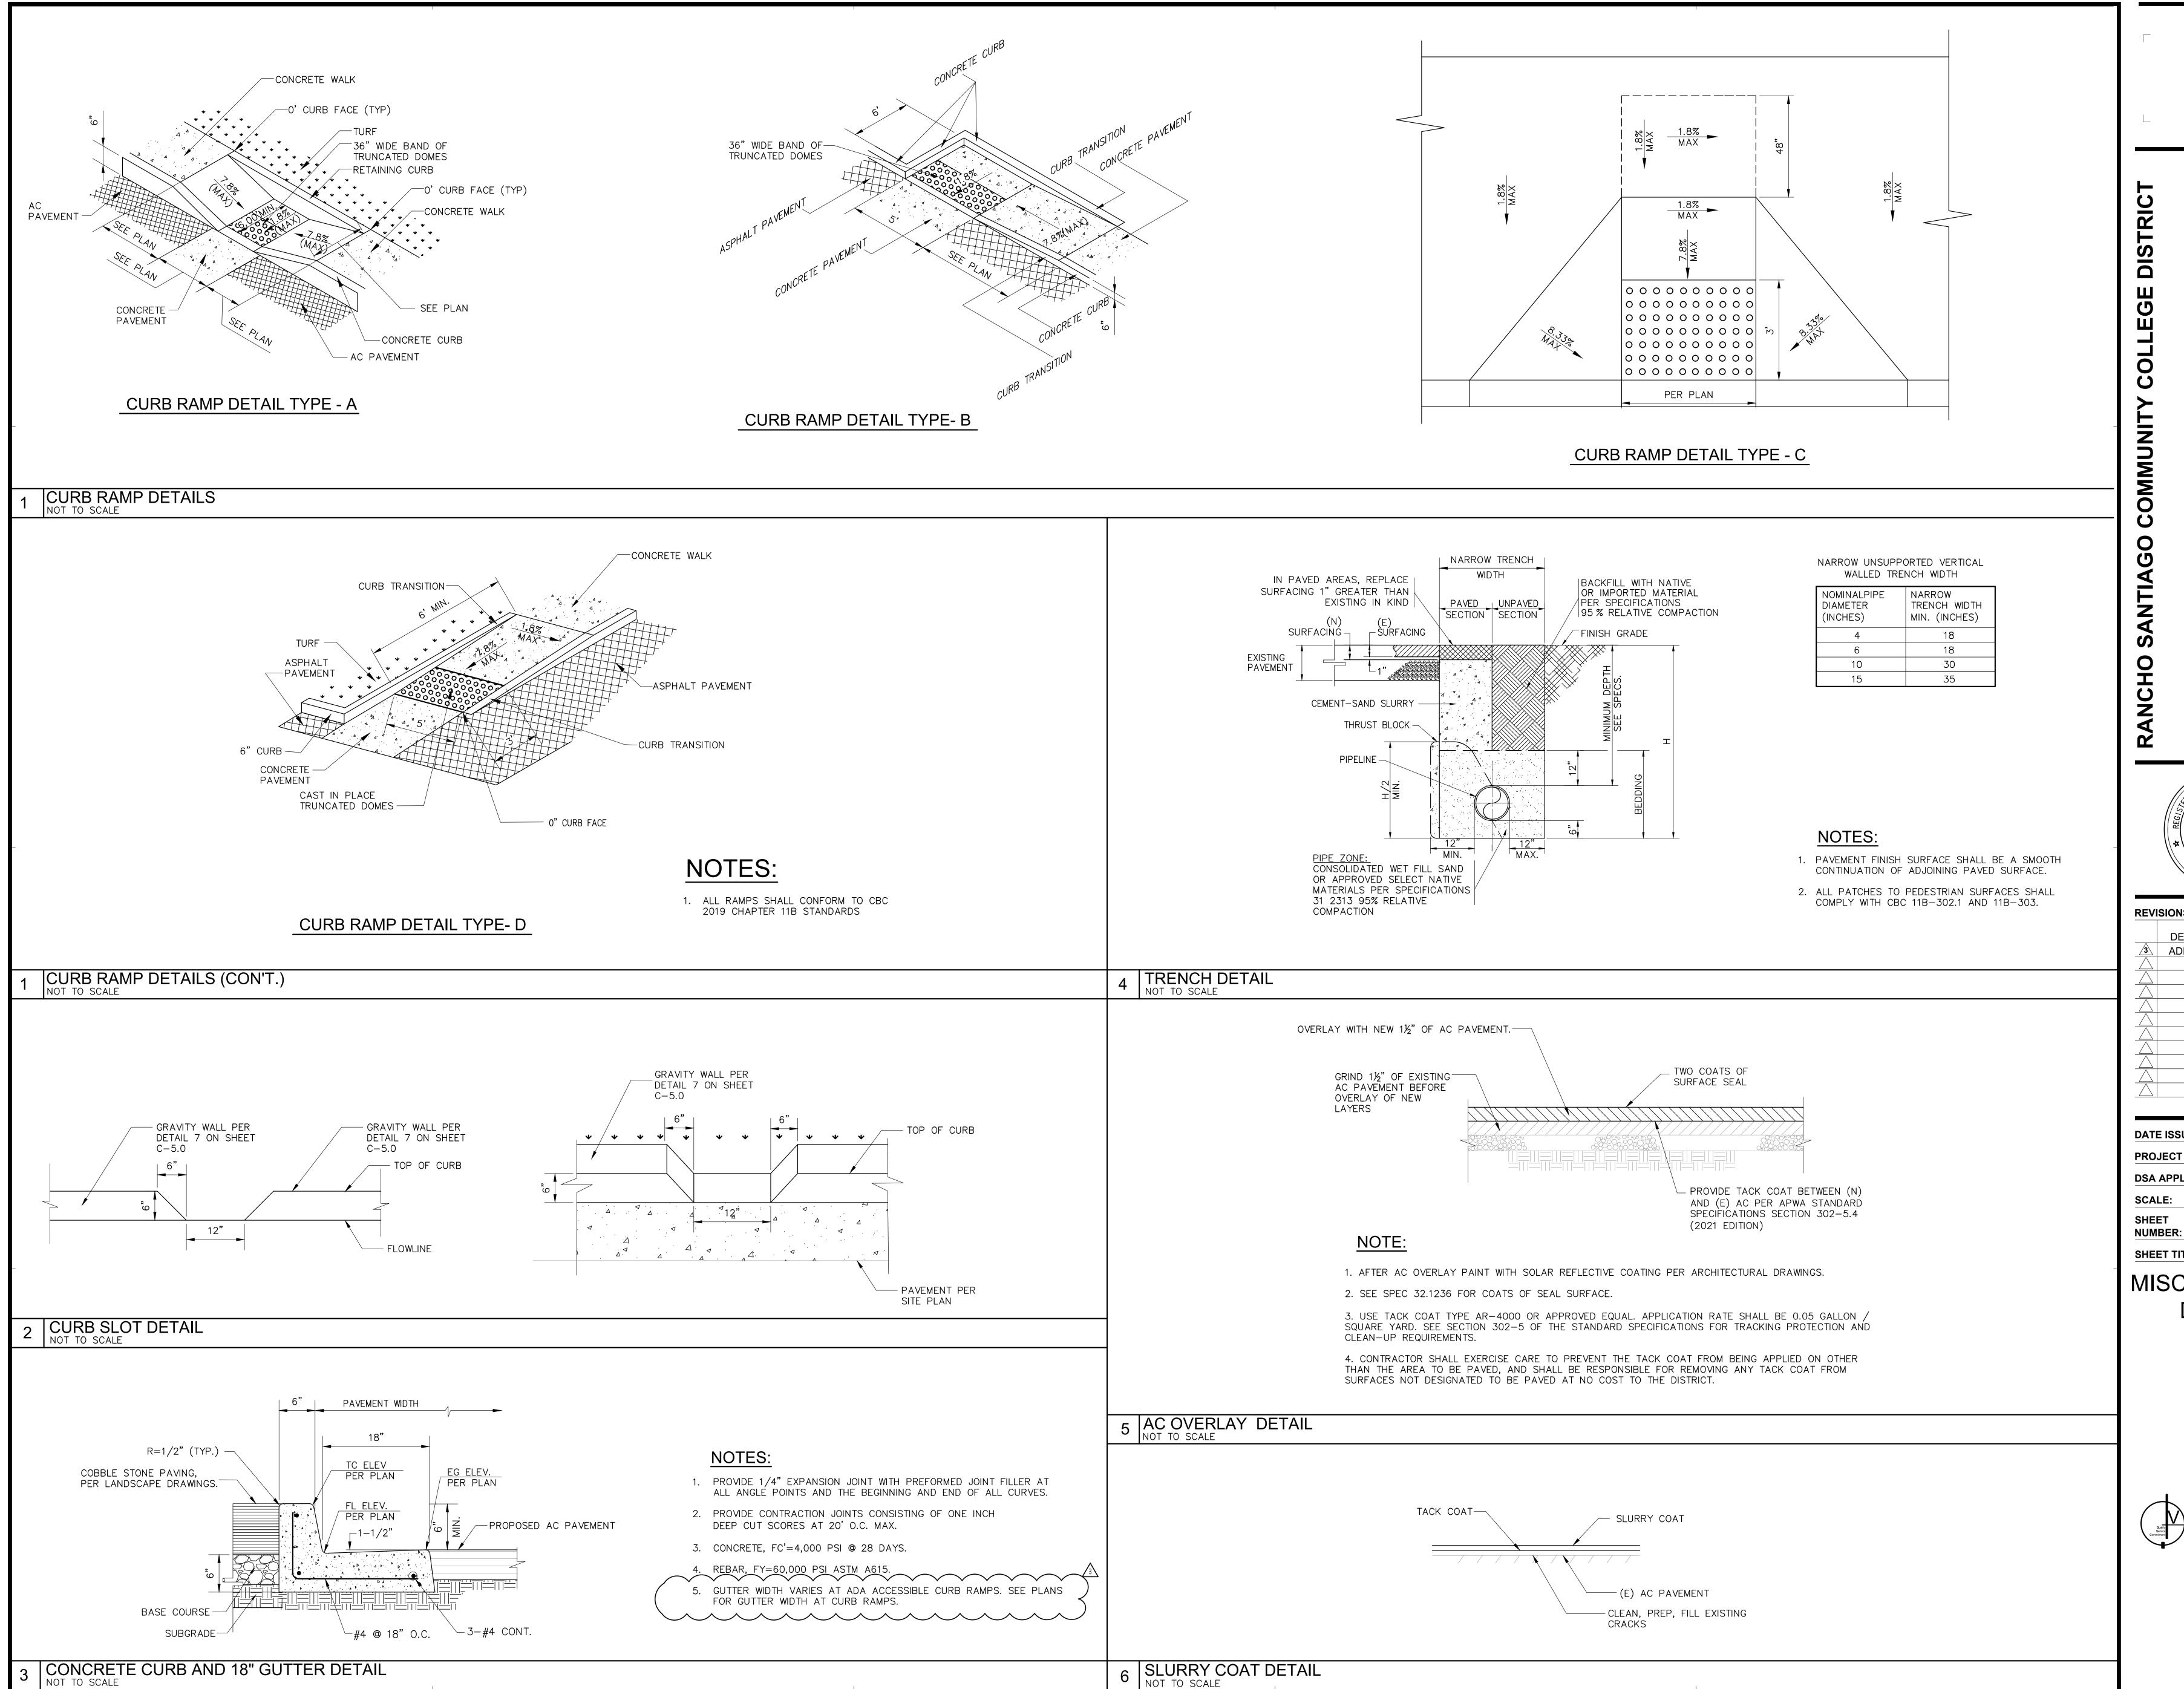
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SCALE: As indicated C-4.1 NUMBER:
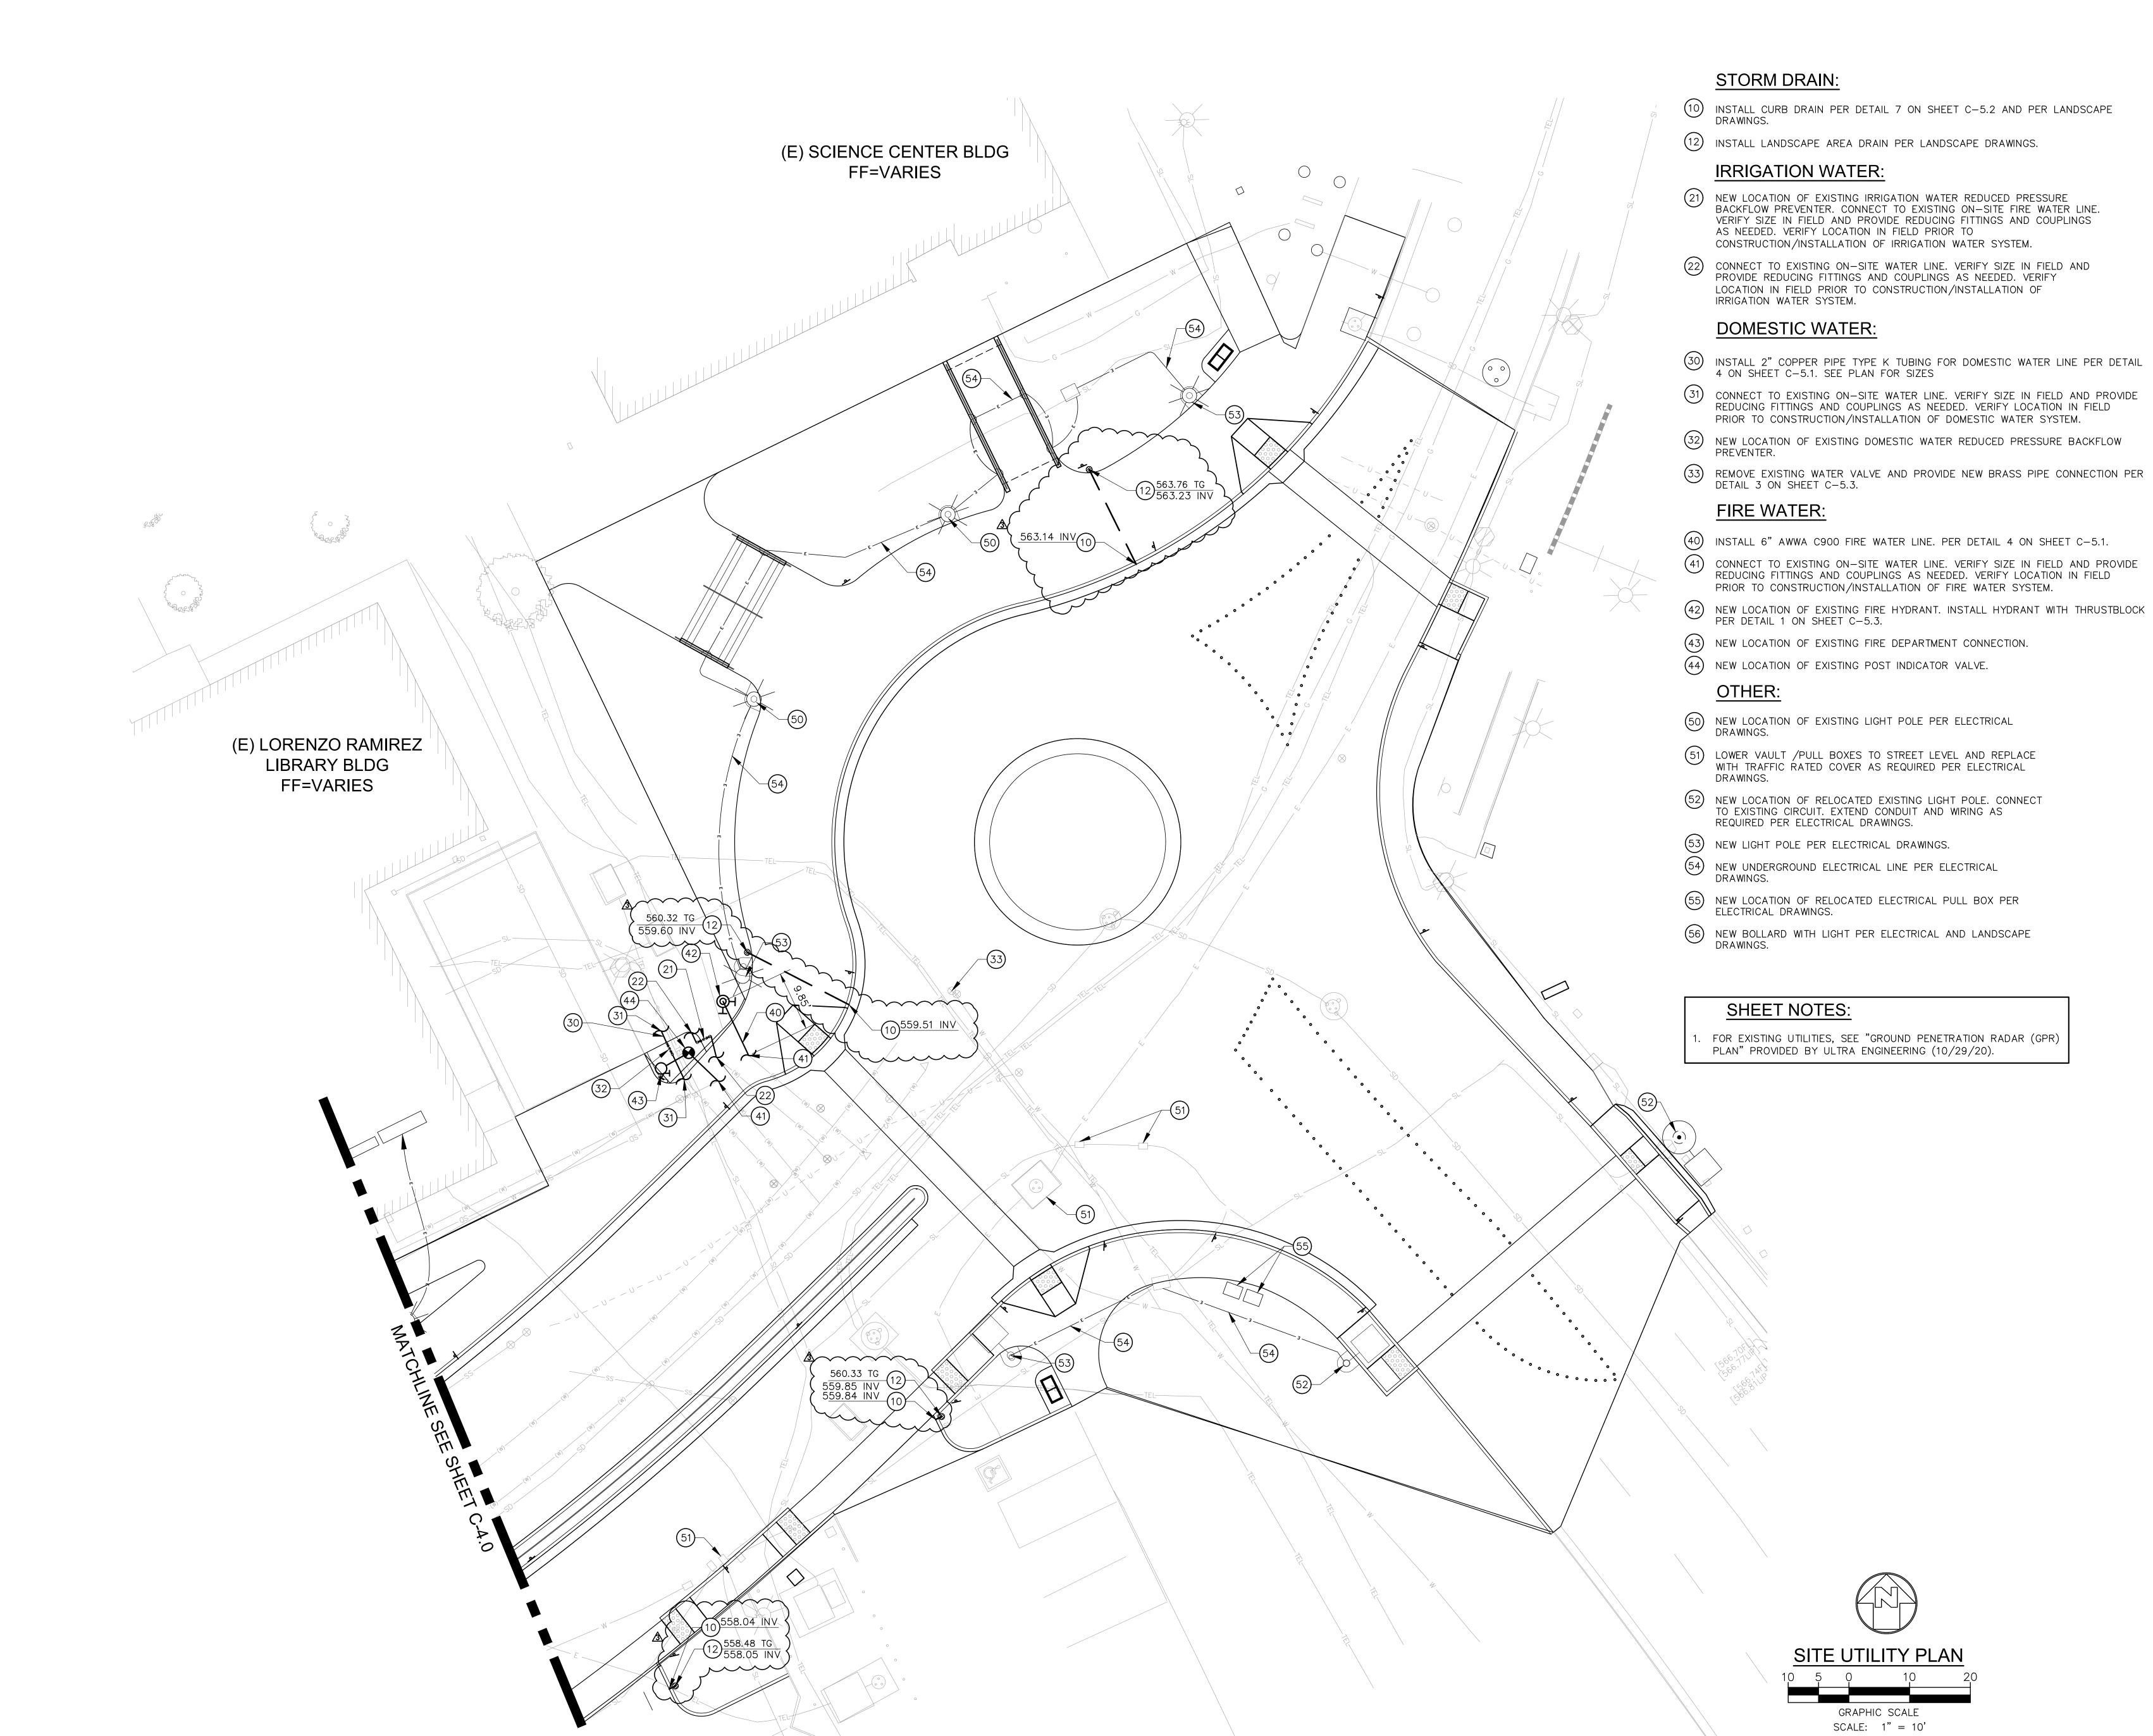
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SITE UTILITY PLAN





SANTIAGO CANYON COLLEGE
CAMPUS ENTRANCE IMPROVEMENTS PROJECT -

No. <u>C36079</u>
Exp. <u>6/30/24</u>

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DESCRIPTION DATE

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 2018-11-19

 PROJECT NO:
 2018-40167

 DSA APPLICATION NO:
 04-121029

 SCALE:
 As indicated

SHEET NUMBER: C-5.1
SHEET TITLE:

MISCELLANEOUS DETAILS


CA ENGINEERS INC

CIVIL ● STRUCTURAL

MEL® DEL ● SSE

1041 S Garfield Ave Suite #210, Alhambra,
CA 91801

Tel. 323.729.6098 Fax. 323.729.6043

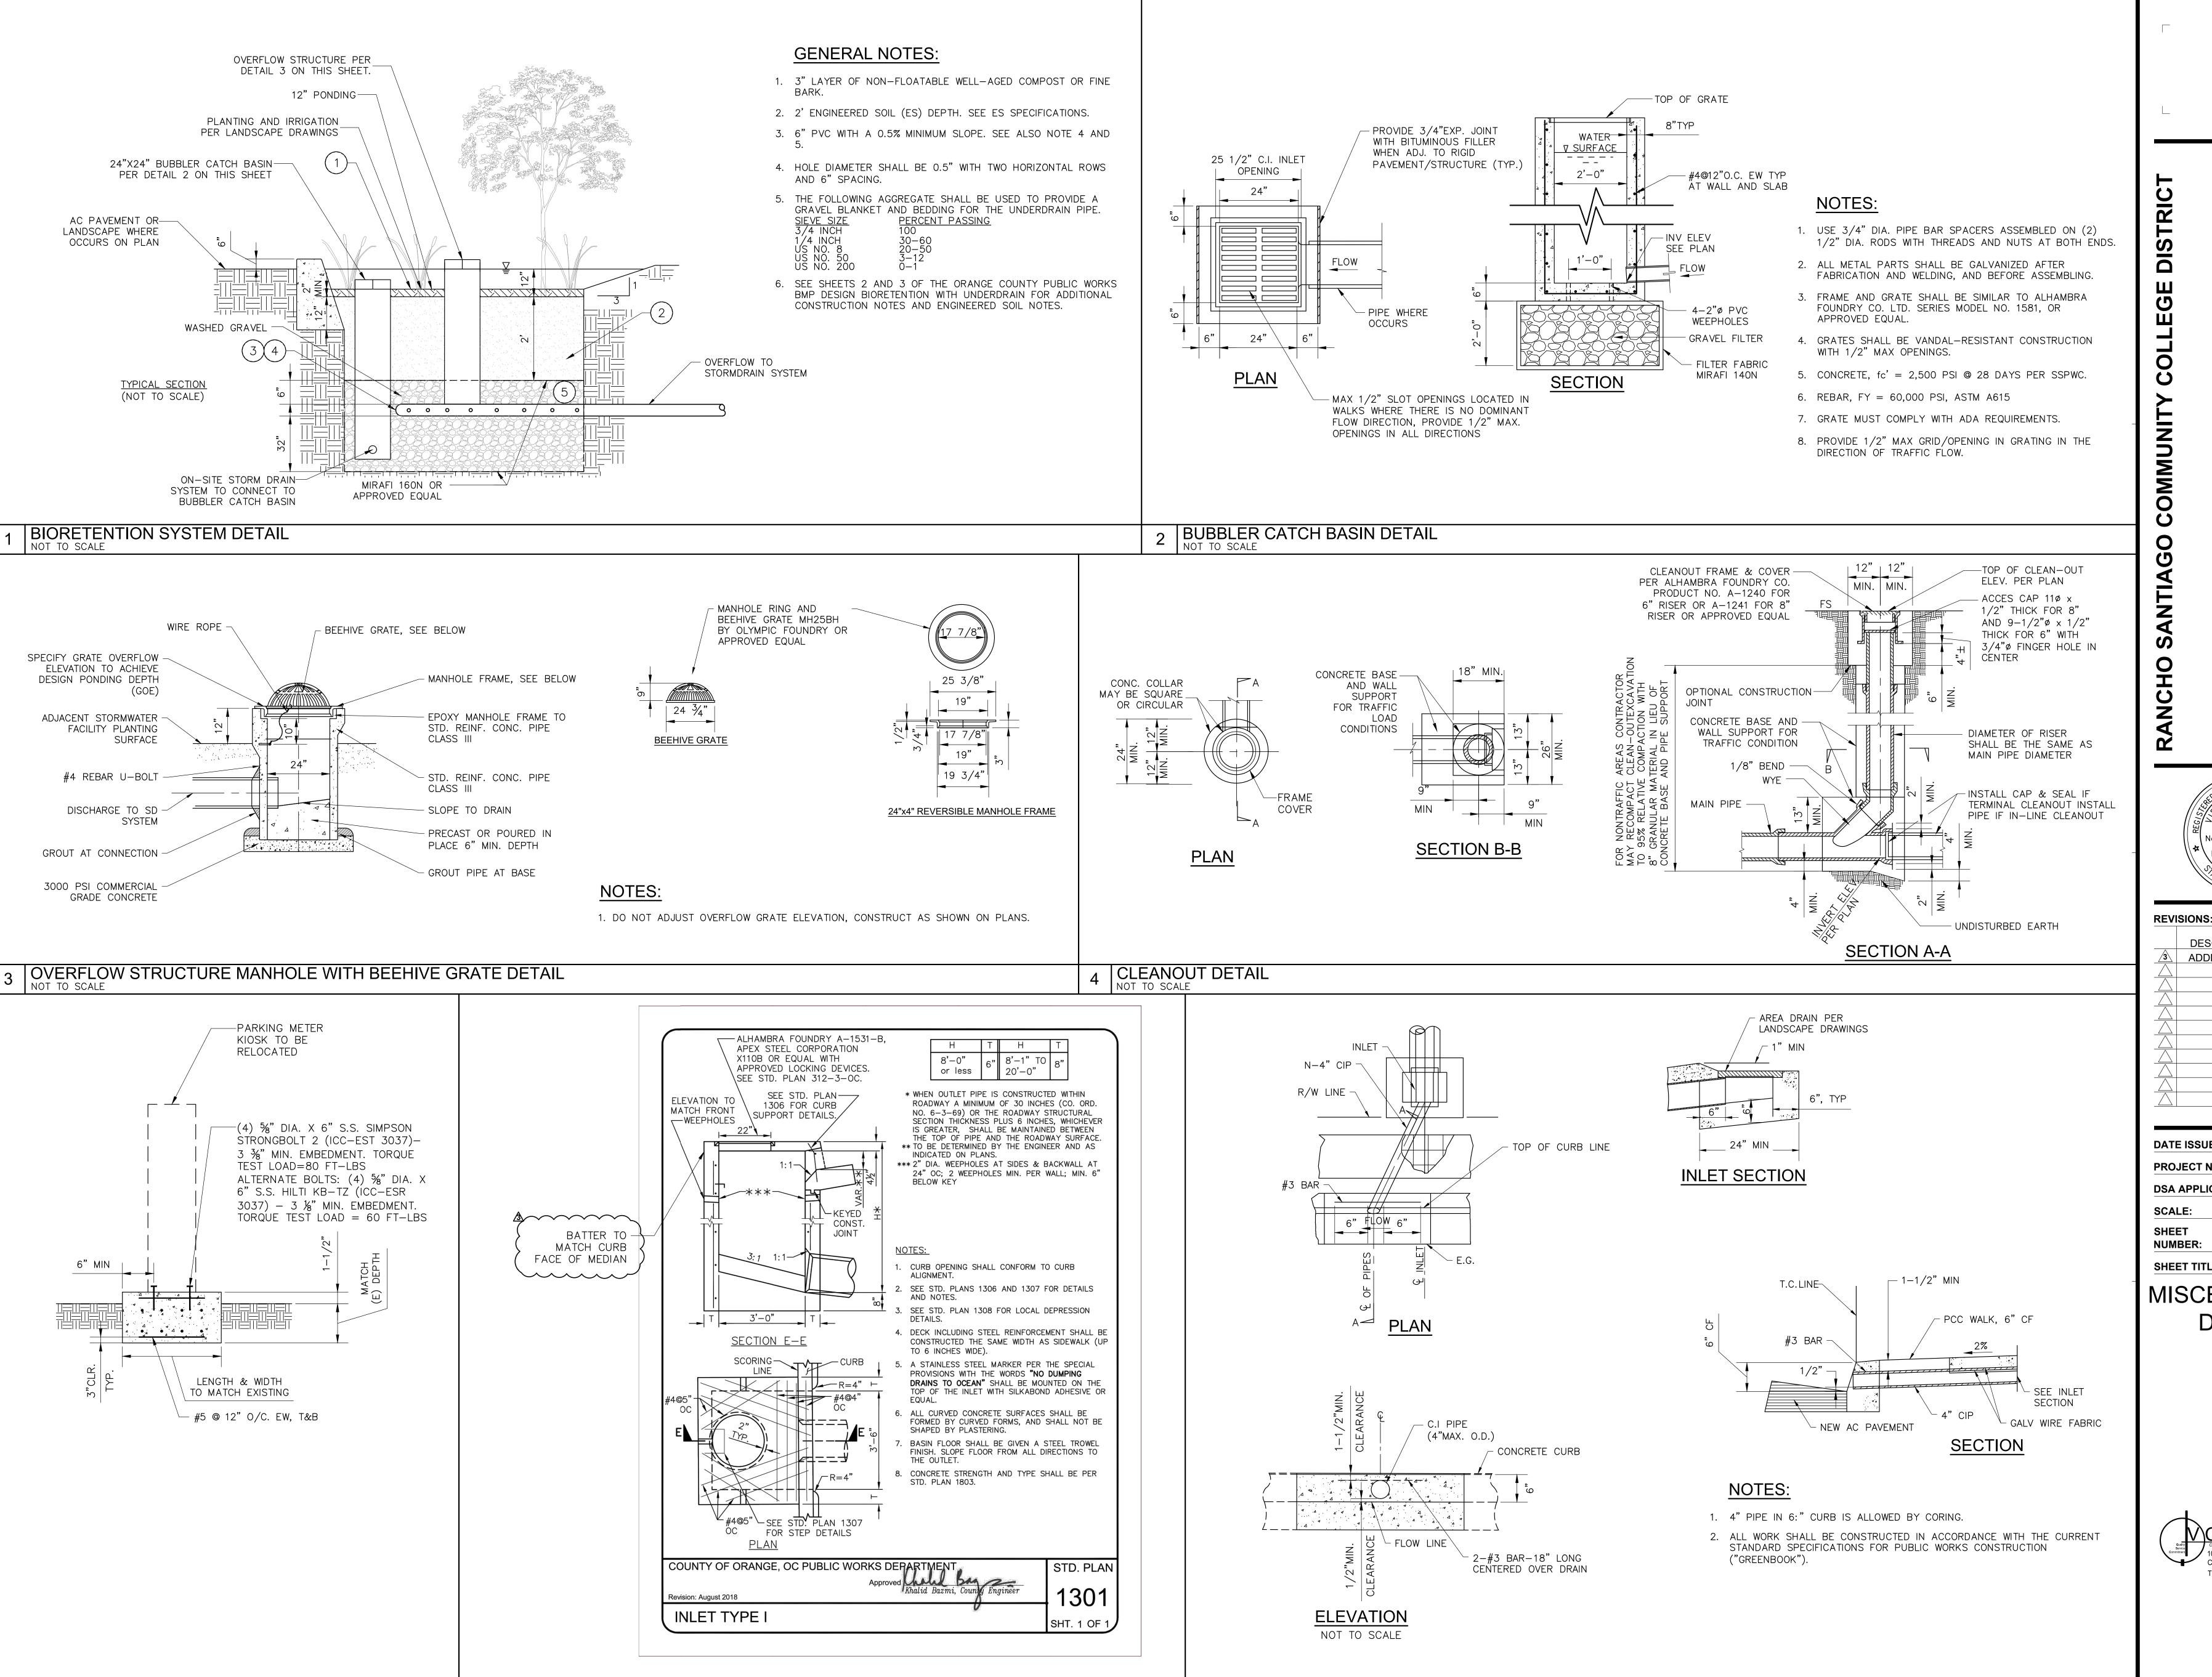

CURB DRAIN DETAIL

NOT TO SCALE

SIDE-OPENING CATCH BASIN DETAILS

PARKING KIOSK PAD DETAIL

NOT TO SCALE

8 ≥ ОШ Q V T ĀĎΠ S D

**REVISIONS:** 


DESCRIPTION DATE ADDENDUM #3 1/17/2023

**DATE ISSUED:** 2018-11-19 **PROJECT NO:** 2018-40167 **DSA APPLICATION NO:** 04-121029 As indicated C-5.2

SHEET TITLE:

MISCELLANEOUS DETAILS

A ENGINEERS INC 1041 S Garfield Ave Suite #210, Alhambra, Tel. 323.729.6098 Fax. 323.729.6043

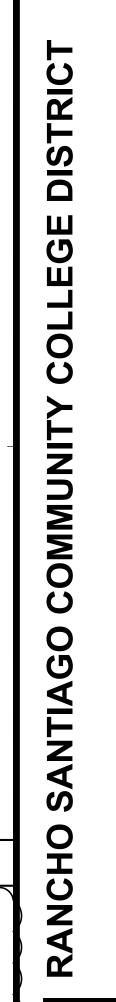

- CURB AND GUTTER

PROVIDE 1/2"EXP. JOINT

WITH BITUMINOUS FILLER

PAVEMENT/STRUCTURE

 $_{\sim}$  WHEN ADJ. TO RIGID

- MAX 1/2" SLOT

— FLOWLINE

■ OPENINGS

CATCH BASIN

PLAN

1/2" C.I. INLET OPENING

24"

PLAN

WHERE-OCCURS



**REVISIONS:** DESCRIPTION DATE ADDENDUM #3 1/17/2023

DATE ISSUED:	2018-11-19
PROJECT NO:	2018-4016
DSA APPLICATION NO:	04-121029
SCALE:	As indicated
SHEET -	

C-5.3NUMBER: SHEET TITLE:

MISCELLANEOUS **DETAILS** 

> CIVIL • STRUCTURAL MEGODE SEE 041 S Garfield Ave Suite #210, Alhambra, Tel. 323.729.6098 Fax. 323.729.6043

TABLE 1

MINIMUM BEARING AREAS IN SQ.FT MAIN | TEE | 90° | 45° 22 1/2 SIZE | BEND | BEND | BEND 4 | 4 | 4 | 10" | 9 | 12 | 6 12

BASED ON 150 PSI W.W.R. PRESSURE & SOIL BEARING LOADS OF 2000 PSF THE RATIO OF WIDTH TO HEIGHT SHALL NOT EXCEED 1 1/2 TO 1

TEES, PLUGS, CAPS & HYDRANTS.

ADOBE 1000 PSF COMPACT FINE SAND 2000 PSF COMPACT COARSE SAND 2000 PSF MEDIUM STIFF CLAY 2000 PSF

500 PSF

1000 PSF

TABLE II

MAX. ALLOWABLE SOIL BEARING VALUES AREAS IN TABLE

\* THE CONTRACTOR SHALL BE RESPONSIBLE FOR DETERMINING THE SAFE SOIL BEARING VALUES AND SIZE OF BEARING AREAS. BASED ON 2 FEET MINIMUM DEPTH OF COVER OVER THE PIPE.

### NOTES:

- 1. ALL ANCHOR AND THRUST BLOCKS SHALL BEAR AGAINST UNDISTURBED SOIL.
- 2. MINIMUM ALLOWABLE WATER PRESSURE FOR DESIGN OF THRUST BLOCKS IS 150 PSI. BEARING AREA INCREASE IN PRESSURE.
- 3. ALL CONCRETE USED IN THRUST BLOCKS SHALL ATTAIN 2000 PSI STRENGTH.
- 4. ALL ANCHOR RODS SHALL BE REINFORCING STEEL AND A MINIMUM OF 1/2-INCH IN DIAMETER.
- 5. USE ANCHOR BLOCKS AT VERTICAL BENDS WHEN PIPE IS ABOVE OR BELOW GROUND. SIZE OF BLOCK AND ROD SHALL BE AS SHOWN ON THE PLANS OR AS DETERMINED BY THE ENGINEER IN THE FIELD.

TRAFFIC LOAD CAST IRON

GRATE OPENING COVER

& FRAME WITH 1/2"

1-1/2"

**SECTION** 

GRATES MUST COMPLY WITH ALL ADA REQUIREMENTS.

USE 3/4" DIA. PIPE BAR SPACERS ASSEMBLED ON (2) 1/2" DIA. RODS WITH THREADS

FRAME AND GRATE SHALL BE SIMILAR TO EISEL ENTERPRISES INC. ALHAMBRA FOUNDRY CO. LTD. SERIES MODEL NO. A-2012 OR BROOKS PRODUCTS, INC. OR APPROVED EQUAL.

SLOT OPENIŃGS

— 2% MAX

IN POT (TYP)

SOIL TYPE

SOFT SANDY CLAY

LOOSE SAND

6. USE 30 POUND FELT TO INSURE COLD JOINT.

3-#4 @

(TYP.)

OVERLAP

NOTES:


AND NUTS AT BOTH ENDS.

BEFORE ASSEMBLING.


CATCH BASIN.

NOT TO SCALE

- 7. CONCRETE SHALL NOT COME INTO DIRECT WITH ASBESTOS CEMENT PIPE.
- 8. FOR PIPE 14" IN DIAMETER OR LARGER ENGINEER IS TO SUBMIT CALCULATIONS.

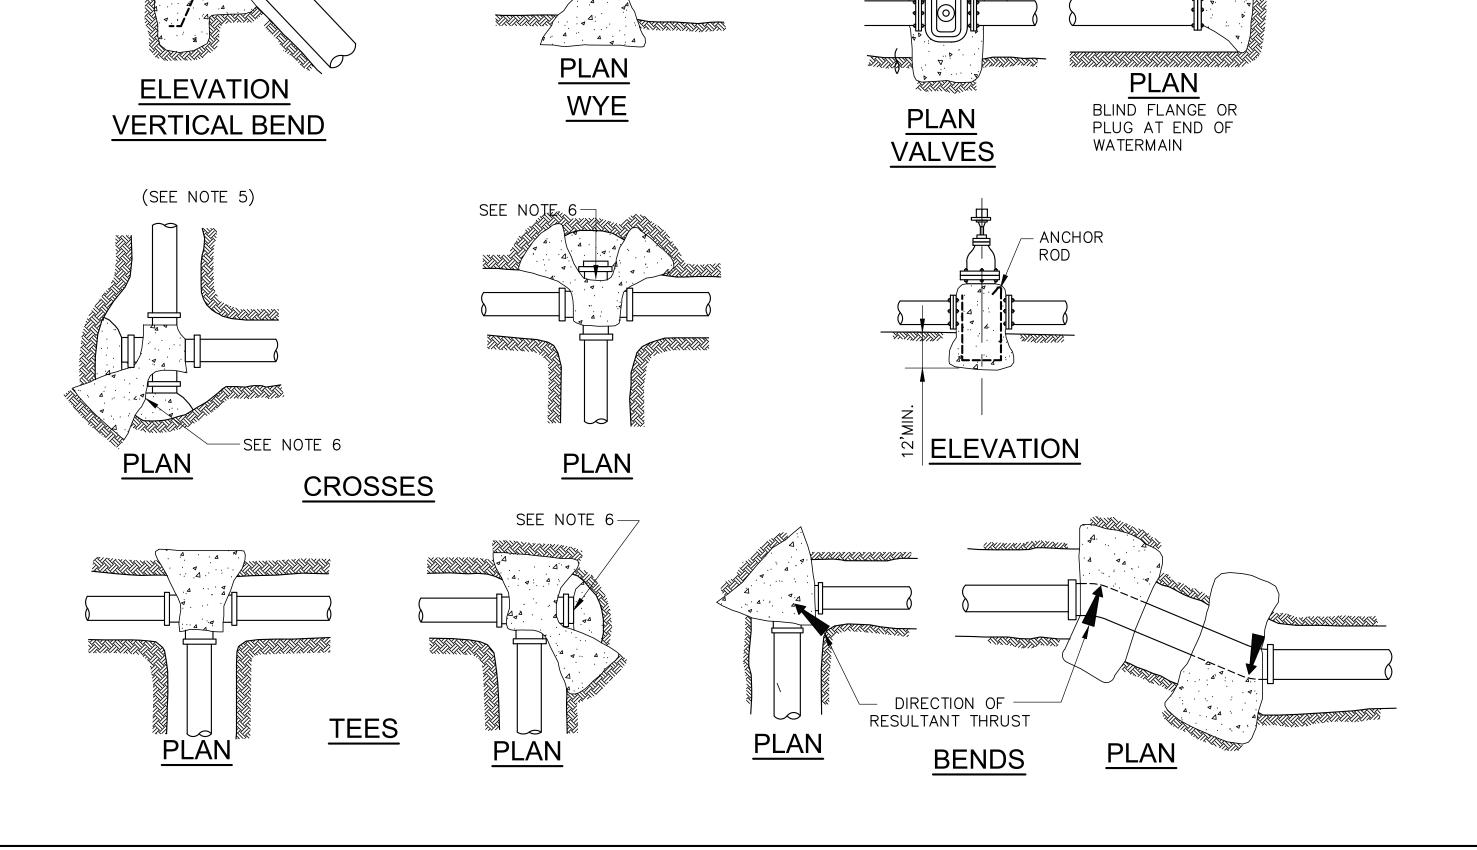

ANCHOR

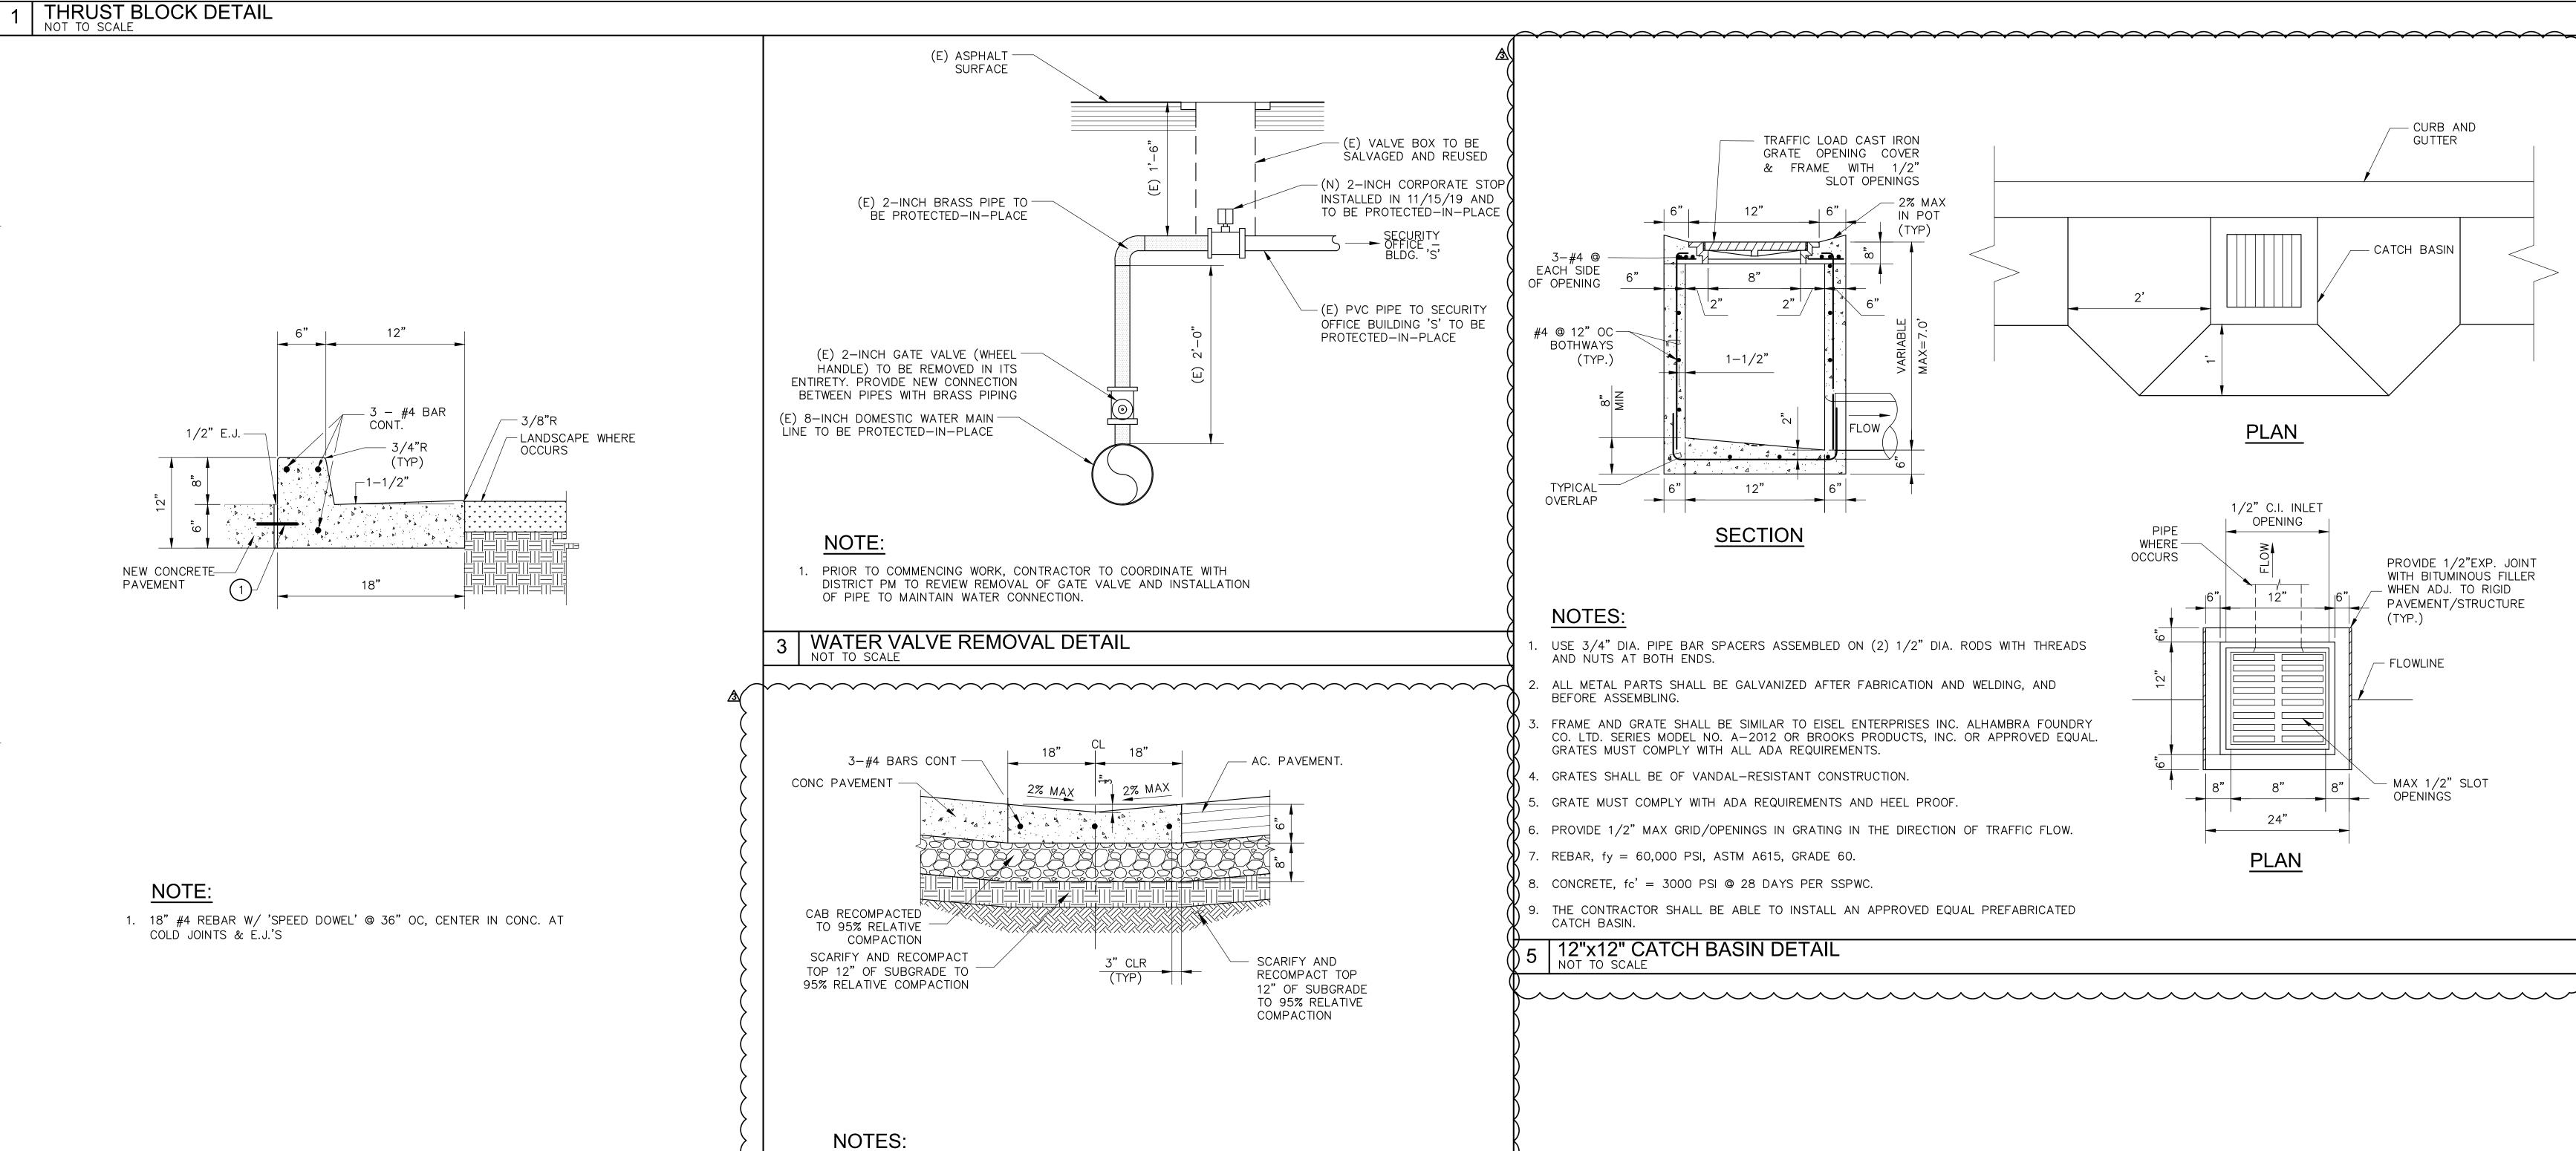

CONCRETE CURB AND 12" GUTTER DETAIL


NOT TO SCALE

1. CONCRETE, F'c=3000 PSI @ 28 DAYS PER SSPWC.

2. REBARS, FY=60,000 PSI ASTM A615.

CONCRETE V-GUTTER



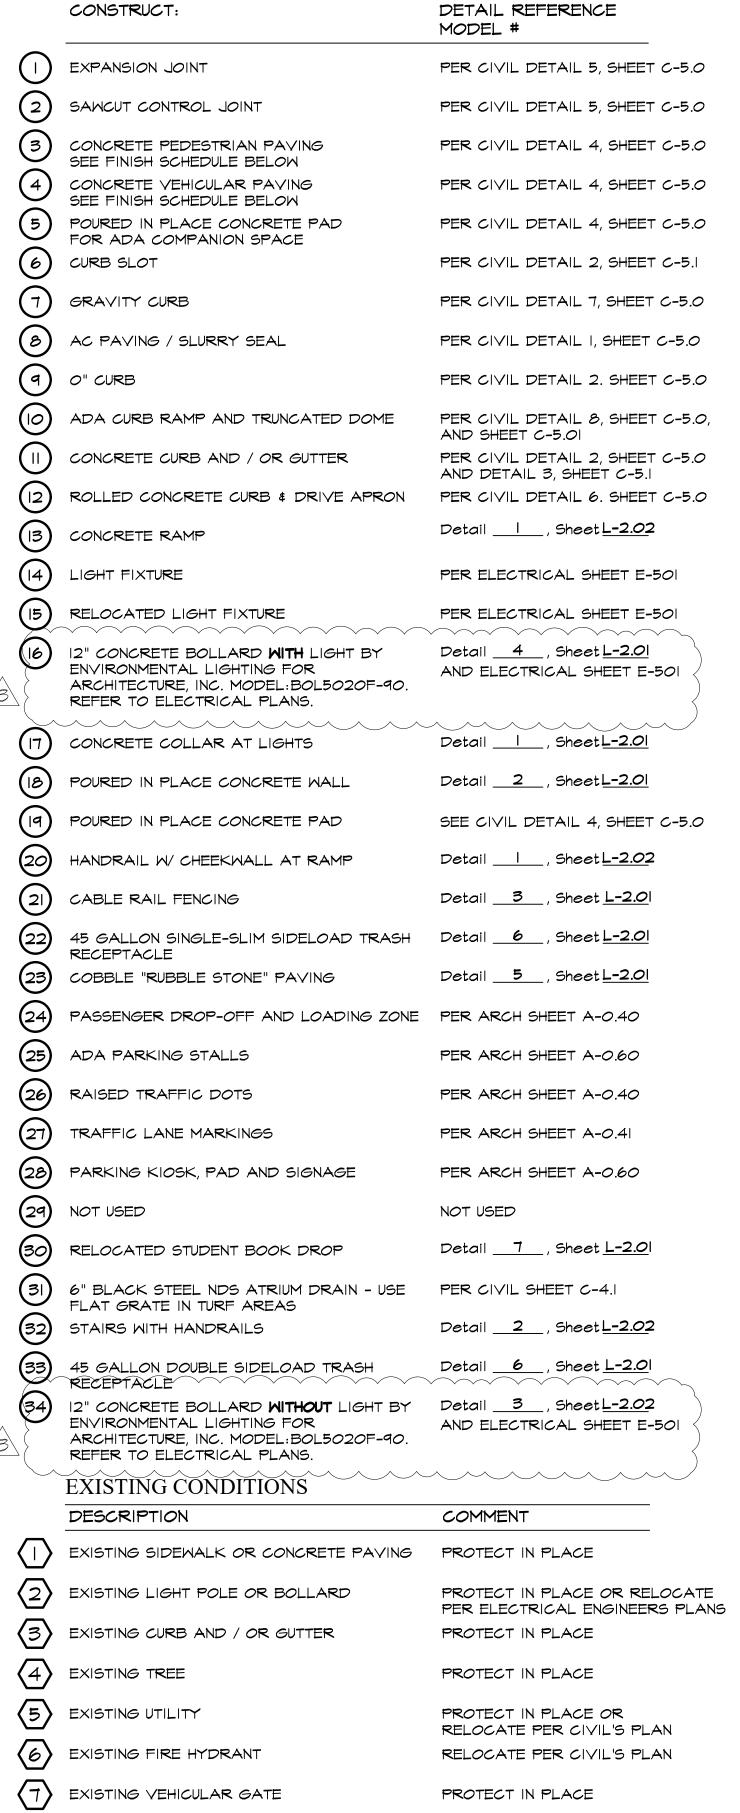


CONSTRUCTION LEGEND

FINISH SCHEDULE TYPE: DESCRIPTION: SYMBOL: COLOR: NATURAL GREY FINISH: MEDIUM BROOM

EXISTING TRASH / RECYCLING RECEPTACLE REMOVE AND DISPOSE (NOT SHOWN ON PLANS)

OF PER CIVIL'S PLANS

CONTRACTOR SHALL PROVIDE 6'X6' MOCKUP PANEL OF CONCRETE COLOR AND FINISH WITH JOINTS PER PLANS FOR REVIEW AND APPROVAL BY DISTRICT PRIOR TO CONSTRUCTION.

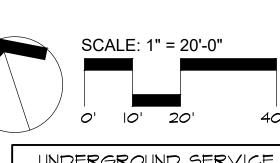

UNDERGROUND SERVICE ALERT TWO WORKING DAYS

BEFORE YOU DIG

### **5 6 7** C

**REVISIONS:** DATE DESCRIPTION ADDENDUM 3

ОШ

2018-11-19 **DATE ISSUED:** PROJECT NO: 2018-40167 **DSA APPLICATION NO:** 04-121029 As indicated SCALE: L-1.01 SHEET

**NUMBER:** 

SHEET TITLE:

**PLAN** 

LANDSCAPE CONSTRUCTION




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HEIGHT OF TOP TUBE RAIL TO FINISH SURFACE SHALL BE 42"

3 GUARDRAIL FENCING

SEE CIVIL ENGINEERS GRADING PLANS FOR FINISH SURFACE ELEVATIONS.

REVIEW AND APPROVAL BY DISTRICT PRIOR TO FABRICATION AND INSTALLATION.

CONTRACTOR SHALL PROVIDE 5' PANEL MOCK UP WITH POSTS AND TENSIONED CABLES AND HARDWARE FOR

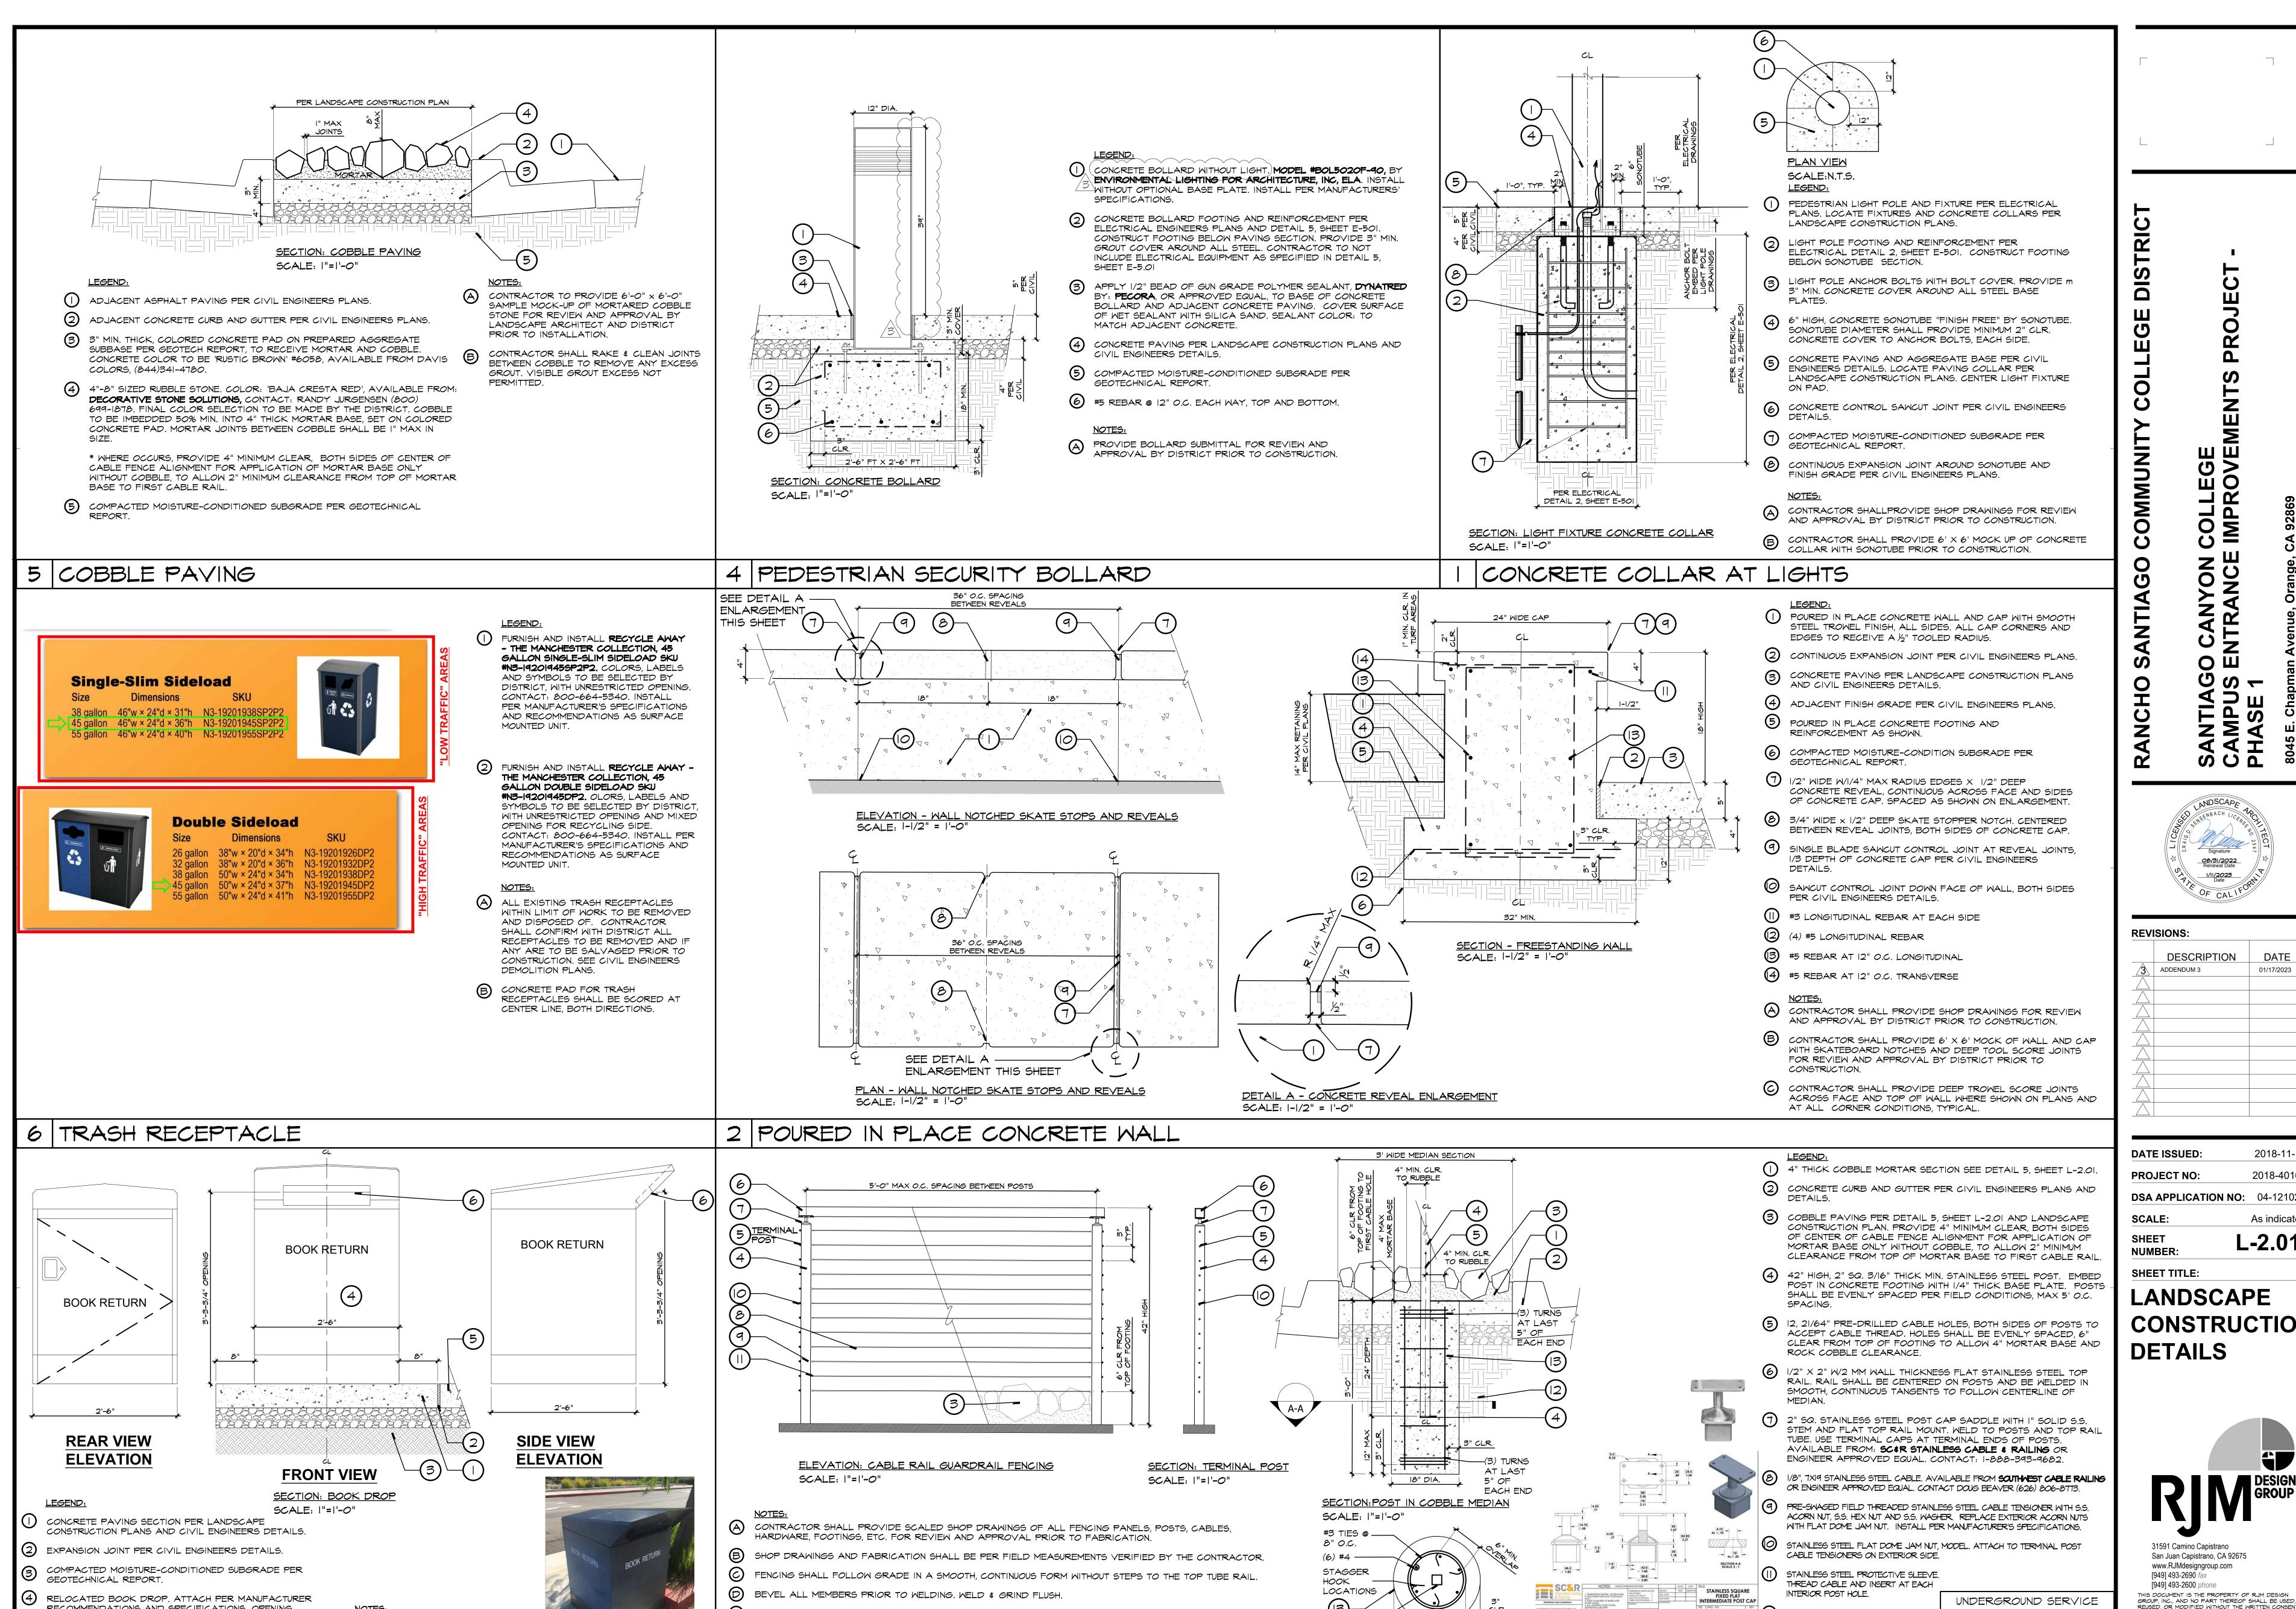RECOMMENDATIONS AND SPECIFICATIONS. OPENING

5 ADJACENT FINISH GRADE PER CIVIL ENGINEERS PLANS

A CONTRACTOR SHALL PROVIDE 6'X6'

RELOCATED BOOK DROP AND CONCRETE PAD

MOCK UP PANEL OF CONCRETE WITH

COLOR AND FINISH PER PLANS FOR

PHOTO OF RELOCATED BOOK DROP

DISTRICT REVIEW AND APPROVAL.

FACING UNLOADING ZONE.

AND DETAILS.

6 BOOK DROP OPENING

LL PR 8 ≥ ОШ ⊕ v ← **V V I** S S D

**DESCRIPTION** DATE ADDENDUM 3 01/17/2023

2018-11-19 **DATE ISSUED:** PROJECT NO: 2018-40167 **DSA APPLICATION NO:** 04-121029 As indicated L-2.01

**SHEET TITLE:** 

LANDSCAPE CONSTRUCTION **DETAILS** 



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ALERT CALL 8 TWO WORKING DAYS

BEFORE YOU DIG

CONDITION SUBGRADE PER

REINFORCEMENT AS SHOWN.

GEOTECHNICAL REPORT.

(3) CONCRETE FOOTING AND

THE RECOMMEND COMMEND IN THE COMMEND IS THE DEGREEASED AND FREE DE

SCALE:N.T.S.


<u>SECTION A-A: STEEL POST</u>

SCALE: |"=1'-0"

DETAIL SHOWN FOR REFERENCE ONLY -

AVAILABLE FROM MANUFACTURER

S.S. POST CAP SADDLE W/STEM

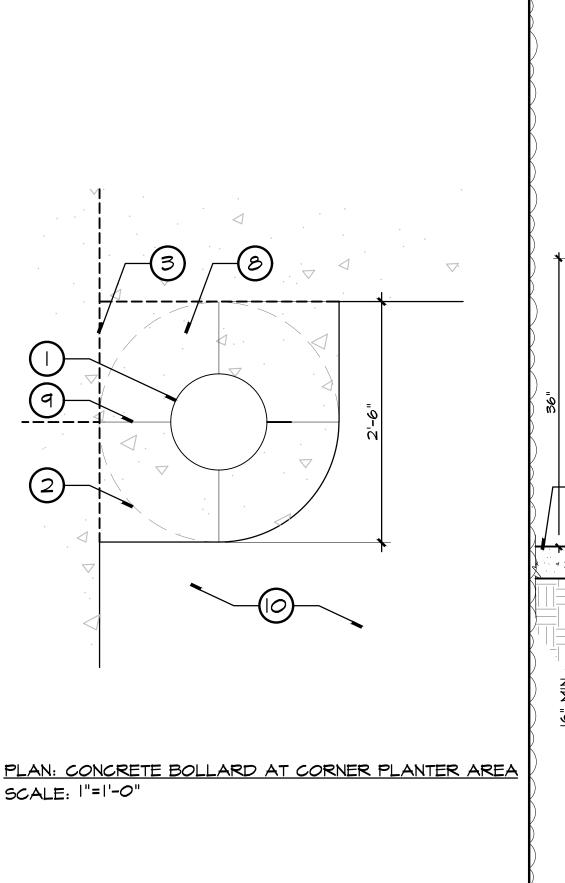

9

SCALE: |"=1'-0"

() CONCRETE BOLLARD WITH LIGHT PER ELECTRICAL ENGINEERS PLANS. MODEL #BOL5020F-90, BY

ENVIRONMENTAL LIGHTING FOR ARCHITECTURE, INC, ELA.

INSTALL WITHOUT OPTIONAL BASE PLATE. INSTALL PER

MANUFACTURERS' SPECIFICATIONS AND ELECTRICAL

2 CONCRETE BOLLARD FOOTING AND REINFORCEMENT PER

3 APPLY 1/2" BEAD OF GUN GRADE POLYMER SEALANT,

(5) COMPACTED MOISTURE-CONDITIONED SUBGRADE PER

(6) #5 REBAR @ 12" O.C. EACH WAY, TOP AND BOTTOM.

(8) CONCRETE COLLAR. COLLAR TO COVER EXTENTS OF

PROVIDE BOLLARD SUBMITTAL FOR REVIEW AND

APPROVAL BY DISTRICT PRIOR TO CONSTRUCTION.

GEOTECHNICAL REPORT.

BOLLARD FOOTING.

(O) ADJACENT PLANTER AREA

7) PLANTER AREA

(9) SCORE JOINT

OF CONCRETE BOLLARD AND ADJACENT CONCRETE

4 CONCRETE PAVING PER LANDSCAPE CONSTRUCTION PLANS AND CIVIL ENGINEERS DETAILS.

ELECTRICAL ENGINEERS PLANS AND DETAIL 5, SHEET

E-5.01. CONSTRUCT FOOTING BELOW PAVING SECTION. PROVIDE 3" MIN. GROUT COVER AROUND ALL STEEL.

DYNATRED BY: PECORA, OR APPROVED EQUAL, TO BASE

PAVING. COVER SURFACE OF WET SEALANT WITH SILICA SAND. SEALANT COLOR: TO MATCH ADJACENT CONCRETE

H STAIR NOSINGS SHALL COMPLY WITH CBC FIGURE A CONTRACTOR TO PROVIDE SCALED SHOP DRAWINGS OF HANDRAIL CONSTRUCTION FOR UNLESS NOTED OTHERWISE. DRAWINGS OF HANDRAIL CONSTRUCTION FOR IIB-504.5. OWNER'S REVIEW AND APPROVAL PRIOR TO BEVEL ALL MEMBERS PRIOR TO WELDING. FABRICATION. SEE SPECIFICATIONS. U STAIR HANDRAILS SHALL WELD & GRIND FLUSH AND SMOOTH. EXTEND HORIZONTALLY B FINAL FABRICATION SHALL BE PER FIELD ABOVE AND BELOW THE ALL CONCRETE TO BE TYPE II, MINIMUM MEASUREMENTS VERIFIED BY THE LANDING FOR 12" MINIMUM COMPRESSIVE STRENGTH PER GEOTECH BEYOND THE TOP AND BOTTOM OF RAMP RUNS. ALL STEEL AND FITTINGS SHALL BE (6) HANDRAILS SHALL BE PROVIDED GALVANIZED, PER SPECS. SUBMIT SAMPLE SLOPE TOP OF AT BOTH SIDES OF RAMPS AND OF POST AND RAIL FABRICATION TO SHOW CHEEKWALL AT POSTS STAIRS AS INDICATED. WELDS AND FINISH. AWAY FROM POSTS TO PROVIDE POSITIVE \* 4' MAX O.C. SPACING DRAINAGE. BETWEEN POSTS 12" MIN. HANDRAIL EXTENSION AT START OF RAMP PLAN VIEW - REBAR SCALE: |" = |'-0" 12" MIDE CHEEKWALL -SEE ENLARGEMENT "C" DETAIL 2, THIS RAMP LANDING SHEET (APPLIES TO ALL POST SIZES 12" MIN. HANDRAIL **EXTENSION** AT END OF RAMP (13) SEE HANDRAIL SECTION DETAIL, TYP. 16" MIN. SECTION A - HANDRAIL AND CHEEKWALL SECTION B - RAMP HANDRAIL AND CHEEKWALL (O) #5 REBAR AT 12" O.C. EACH WAY. SCALE: |" = |'-0" SCALE: |" = |'-0" HANDRAIL AND CHEEKWALL AT CONCRETE RAMP

DIMENSION PER LANDSCAPE CONSTRUCTION PLANS

1.25" DIA. (1.66" O.D.) SCHEDULE 80 STAINLESS STEEL (2) #4 AT 12" O.C., TOP AND BOTTOM TOP RAIL. WELD TO POSTS CONTINUOUS. TOP RAIL SHALL BE 36" VERTICALLY FROM FINISH SURFACE TO TOP OF RAIL PER DISTRICT DESIGN STANDARDS. STAIR HANDRAILS SHALL EXTEND HORIZONTALLY ABOVE AND BELOW LANDINGS, TREADS AND RISERS FOR 12" MINIMUM BEYOND THE FIRST TREAD AND TOP RISER.

2 1/2" X 1-1/2" STAINLESS STEEL VERTICAL POST WITH SEMILETRELE NOTCH AT TOP FOR WELDING TO BOTTOM OF HORIZONTAL TOP HANDRAIL. LOCATE TOP, BOTTOM AND LANDING POSTS FOLLOWED BY IN-BETWEEN POSTS SPACED EQUALLY, 4'-O" MAX O.C. SPACING. EMBED POSTS MIN. 12" IN CONCRETE CHEEKWALL. CORE DRILL CHEEKWALL / FOOTING OR PROVIDE 3" SCH. 40 PVC SET I/2" BELOW ADJACENT FINISH SURFACE. SECURE WITH SUPER POR-ROK OR APPROVED EQUAL TO 1/2" BELOW ADJACENT FINISH SURFACE. APPLY 1/2" BEAD OF "GUN GRADE" POLYMER SEALANT BY: PECORA, OR APPROVED (4) 3/4" STEEL ROD MID RAIL. WELD ROD TO STAIR EQUAL, TO TOP OF SUPER POR-ROK BACKFILL. COVER SURFACE OF WET SEALANT WITH SILICA

CONCRETE. 3 12" WIDE, POURED IN PLACE CONCRETE CHEEKWALL WITH I" CHAMFER ON ALL EDGES AND STEEL TROWEL FINISH. SEE CIVIL PLANS FOR GRADES / FINISH (B) FABRICATION SHALL BE PER

SURFACE ELEVATIONS. 4 RAMP CONCRETE PAVING SHALL BE NATURAL GREY 6 ALL STEEL AND FITTINGS SHALL BE GALVANIZED, CONCRETE WITH STEEL TROWEL, NON-SLIP FINISH. PAYMENT DESIGN PER CIVIL ENGINEER'S PLANS.

5 SUBGRADE PREPARATION AND COMPACTION PER D ALL STEEL PIPE SHALL BE SCH 40, UNLESS GEOTECH REPORTS. SEE SPECIFICATIONS.

(8) EXPANSION JOINT PER CIVIL ENGINEERS DETAILS.

(2) #4 REBAR. 2" CLEAR FROM TOP OF CHEEK H STAIR NOSINGS SHALL COMPLY WITH CBC FIGURE WALL. REFER TO PLAN VIEW REBAR ENLARGEMENT. WALL. REFER TO PLAN VIEW REBAR ENLARGEMENT.

(II) (3) #5 TOP AND BOTTOM REBAR, CONTINUOUS.

LEGEND CONTINUED:

(I-7/8" O.D.) STAINLESS STEEL VERTICAL POST WITH SEMI CIRCLE NOTCH AT TOP FOR WELDING TO BOTTOM OF HORIZONTAL TOP HANDRAIL. LOCATE TOP, BOTTOM AND LANDING POSTS FOLLOWED BY IN-BETWEEN POSTS SPACED EQUALLY, 4'-O" MAX O.C. SPACING. EMBED POSTS MIN. 12" IN CONCRETE CHEEKWALL. CORE DRILL CHEEKWALL / FOOTING OR PROVIDE 3" SCH. 40 PVC SET 1/2" BELOW ADJACENT FINISH SURFACE. SECURE WITH SUPER POR-ROK OR APPROVED EQUAL TO 1/2" BELOW ADJACENT FINISH SURFACE. APPLY 1/2" BEAD OF "GUN GRADE" POLYMER SEALANT BY: PECORA, OR APPROVED EQUAL, TO TOP OF SUPER **POR-ROK** BACKFILL. COVER SURFACE OF WET SEALANT WITH SILICA SAND. SEALANT COLOR: TO

MATCH ADJACENT CONCRETE. FACING SIDE OF VERTICAL CENTER POSTS.

SAND. SEALANT COLOR: TO MATCH ADJACENT (A) CONTRACTOR TO PROVIDE SCALED SHOP DRAWINGS OF HANDRAIL CONSTRUCTION FOR OWNER'S REVIEW AND APPROVAL PRIOR TO FABRICATION. SEE SPECIFICATIONS.

MEASUREMENTS VERIFIED BY THE CONTRACTOR.

PER SPECS. SUBMIT SAMPLE OF POST AND RAIL FABRICATION TO SHOW WELDS AND FINISH.

NOTED OTHERWISE. POST CONCRETE FOOTING AND REINFORCEMENT AS (E) BEVEL ALL MEMBERS PRIOR TO WELDING.

WELD & GRIND FLUSH AND SMOOTH.

ADJACENT CONCRETE PAVING PER LANDSCAPE (F) ALL CONCRETE TO BE TYPE II, MINIMUM CONSTRUCTION PLANS AND CIVIL ENGINEERS COMPRESSIVE STRENGTH PER GEOTECH REPORT. COMPRESSIVE STRENGTH PER GEOTECH REPORT. 6 HANDRAILS SHALL BE PROVIDED AT BOTH SIDES

OF RAMPS AND STAIRS AS INDICATED. 11B-504.5.

1.25" DIA. (1.66" O.D() SCHEDULE 80 \$TAINLESS STEEL

TOP RAIL. WELD TO POSTS CONTINUOUS. TOP RAIL

SHALL BE 36" VERTICALLY FROM FINISH SURFACE TO TOP OF RAIL PER DISTRICT DESIGN STANDARDS.

STAIR HANDRAILS SHALL EXTEND HORIZONTALLY ABOVE AND BELOW LANDINGS, TREADS AND RISERS

FOR 12" MINIMUM BEYOND THE FIRST TREAD AND TOP

BOTTOM OF HORIZONTAL TOP HANDRAIL. LOCATE

TOP, BOTTOM AND LANDING POSTS FOLLOWED BY

IN-BETWEEN POSTS SPACED EQUALLY, 4'-O" MAX O.C. SPACING. EMBED POSTS MIN. 12" IN CONCRETE

CHEEKWALL WHEN LOCATED AT STAIR ENDS AND DIRECTLY IN PAVING AT CENTER OF STAIRWAY (PER ENLARGEMENT BI, THIS DETAIL). CORE DRILL

CHEEKWALL / FOOTING OR PROVIDE 3" SCH. 40 PVC

SET 1/2" BELOW ADJACENT FINISH SURFACE. SECURE

WITH SUPER POR-ROK OR APPROVED EQUAL TO 1/2'

BELOW ADJACENT FINISH SURFACE. APPLY 1/2 BEAD OF "GUN GRADE" POLYMER SEALANT

DYNATRED BY: PECORA, OR APPROVED EQUAL, TO TOP OF SUPER POR-ROK BACKFILL. SLOPE AWAY

FROM POST. COVER SURFACE OF WET SEALANT WITH

SILICA SAND. SEALANT COLOR: TO MATCH

(3) 12" WIDE, POURED IN PLACE CONCRETE CHEEKWALL

AT TERMINAL ENDS OF STAIRS ONLY, WITH !


CHAMFER ON ALL EDGES AND STEEL TROWEL FINISH.

SEE CIVIL PLANS FOR GRADES / FINISH SURFACE

(2) 1/2" X 1-1/2" STAINLESS STEEL VERTICAL POST WITH SEMIN CIRCLE NOTCH AT TOP FOR WELDING TO

RISER, AS SHOWN

(I) RAMP HANDRAILS SHALL EXTEND HORIZONTALLY ABOVE AND BELOW THE LANDING FOR 12" MINIMUM BEYOND THE TOP AND BOTTOM OF RAMP

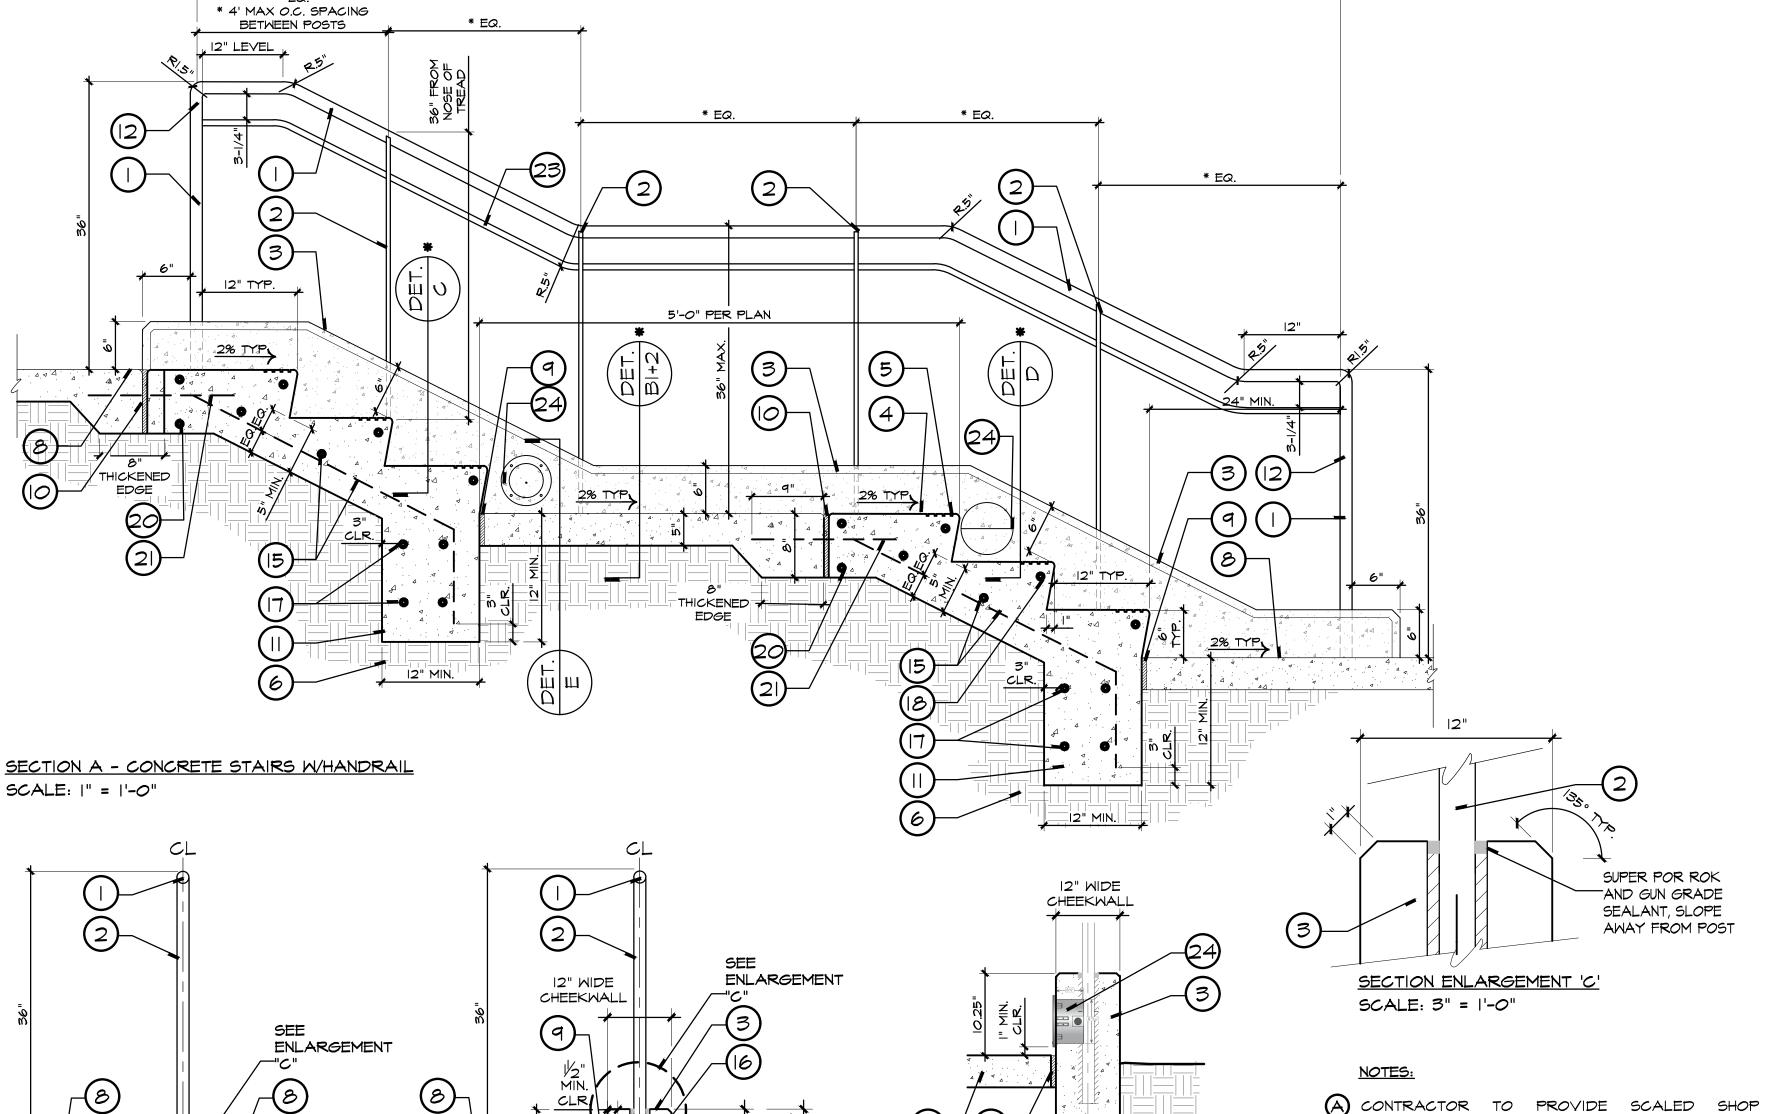

SECTION E - STEP LIGHT

SECTION D - SAFETY STRIPES

SCALE: |" = |'-0"

22

SCALE: |" = |'-0"

(4) POURED-IN-PLACE NATURAL GRAY CONCRETE STAIRS WITH NON-SLIP STEEL TROWEL FINISH. SEE CIVIL ENGINEERS PLANS FOR GRADES / FINISH SURFACE ELEVATIONS. STAIR TREADS SHALL RECEIVE 3" WIDE, NON-SLIP SAFETY PAINTED STRIP, PLACED NO MORE THAN 1/2" FROM NOSE OF STEP, CONTINUOUS ALONG FULL LENGTH OF EACH STEP. COLORS: YELLOW AT TOP AND BOTTOM RISERS BLACK ON ALL INTERMEDIATE RISERS. PAINT BY MONOPOLE INC., TYPE: FLOORCOAT, MODEL: 2400 / 2500, OR APPROVED EQUAL. INSTALL PER MANUFACTURER'S SPECIFICATIONS (818) 500-8585.

(5) 1/2" TOOLED RADIUS, TYPICAL.

ADJACENT CONCRETE.

ELEVATIONS.

(6) SUBGRADE PREPARATION AND COMPACTION PER GEOTECH REPORTS. SEE SPECIFICATIONS. 7) POST CONCRETE FOOTING AND REINFORCEMENT AS

(8) ADJACENT CONCRETE PAVING PER LANDSCAPE CONSTRUCTION PLANS AND CIVIL ENGINEERS DETAILS.

(9) EXPANSION JOINT PER CIVIL ENGINEERS DETAILS.

O CONTINUOUS COLD JOINT PER CIVIL ENGINEERS DETAILS. STAIR CONCRETE FOOTING AND REINFORCEMENT AS

TOP HANDRAIL RETURN TO POST. BEVEL, WELD AND GRIND FLUSH AND SMOOTH.

(3) #5 TOP AND BOTTOM REBAR, CONTINUOUS.

**(4)** #5 REBAR AT 12" O.C. EACH WAY.

(5) #4 REBAR AT 12" O.C. EACH WAY, AT MID HEIGHT OF SLAB. (2) #4 REBAR. 2" CLEAR FROM TOP OF CHEEK WALL.

ig( eta ig) (2) #4 CONTINUOUS REBAR, TOP AND BOTTOM. #4 NOSING BAR, CONTINUOUS, TYPICAL

(9) #4 AT 12" O.C., TOP AND BOTTOM

(2) #4 CONTINUOUS REBAR. SPEED DOWEL AT 24" O.C. SPACING. SEE DETAIL 2 SHEET L-2.01.

3" WIDE PAINTED YELLOW WARNING STRIPING, APPROXIMATE 33538 OF SAE AMS-STD-595A W/IN 3 OF TREAD NOSE.

3/4" STEEL ROD - MID RAIL. WELD ROD TO STAIR FACING SIDE OF VERTICAL CENTER POSTS.

5TEP LIGHT

PCSS6 PER

UNDERGROUND SERVICE ALERT CALL: 8

BEFORE YOU DIG

A CONTRACTOR TO PROVIDE SCALED SHOP DRAWINGS OF HANDRAIL CONSTRUCTION FOR OWNER'S REVIEW AND APPROVAL PRIOR TO FABRICATION. SEE SPECIFICATIONS.

B FABRICATION SHALL BE PER FIELD MEASUREMENTS VERIFIED BY THE CONTRACTOR.

ALL STAINLESS STEEL POSTS, RAILS AND FITTINGS SHALL BE GALVANIZED, PER SPECS. SUBMIT SAMPLE OF POST AND RAIL FABRICATION TO SHOW WELDS AND FINISH.

ALL STEEL PIPE SHALL BE SCH 40, UNLESS NOTED OTHERWISE.

BEVEL ALL MEMBERS PRIOR TO WELDING. WELD & GRIND FLUSH AND SMOOTH.

F ALL CONCRETE TO BE TYPE II, MINIMUM COMPRESSIVE STRENGTH PER GEOTECH REPORT. HANDRAILS SHALL BE PROVIDED AT BOTH SIDES OF RAMPS AND STAIRS AS INDICATED.

H STAIR NOSINGS SHALL COMPLY WITH CBC FIGURE IIB-504.5. STAIR HANDRAILS SHALL EXTEND HORIZONTALLY ABOVE AND BELOW THE LANDING FOR 12"

MINIMUM BEYOND THE TOP AND BOTTOM OF RAMP

SLOPE TOP OF CHEEKWALL AT POSTS AWAY FROM POSTS TO PROVIDE POSITIVE DRAINAGE.

FX-4 LIT-E0015-FLECTRICAL PLANS TWO WORKING DAYS

2 HANDRAIL AND CHEEKWALL AT CONCRETE STAIRS

SCALE: |" = |'-0"

SECTION BI - INTERMEDIATE HANDRAIL

SCALE: |" = |'-0"

16" MIN.

SECTION B - CHEEK WALL FOOTING & HANDRAIL

 $\leq \supset \square$ **REVISIONS: DESCRIPTION** ADDENDUM 3

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Q V -

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DATE 01/17/2023

**DATE ISSUED:** 2018-11-19 PROJECT NO: 2018-40167 **DSA APPLICATION NO:** 04-121029 As indicated L-2.02

**NUMBER:** 

SHEET TITLE: LANDSCAPE CONSTRUCTION **DETAILS** 




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TREE LEGEND

		BOTANICAL NAME COMMON NAME	SIZE	SPACING	DISTRICT APPROVED PLANT	WUCOLS ZONE 3	QTY.
La samo	T-I	GEIJERA PARVIFLORA AUSTRALIAN WILLOW	36" BOX	SPACING PER PLAN	YES	٦	=
	T-2	PODOCARPUS GARCILIOR - FEMALE FERN PINE	36" BOX	SPACING PER PLAN	YES	Σ	4
5.5.	EX-I	EXISTING TREE OR PALM TO REMAIN PROTECT IN PLACE	1	AS SHOWN	-	1	1
VV							· · · · · ·

SHRUB AND GROUNDCOVER LEGEND

		BOTANICAL NAME COMMON NAME	SIZE	SPACING	DISTRICT APPROVED PLANT	WUCOLS ZONE 3	QTY.
	<del>5</del>	DYMONDIA MARGARETAE SILVER CARPET	I GAL.	12" <i>0.</i> C.	NOT LISTED	٦	36
	<b>5-</b> 2	MYOPORUM PARVIFOLIUM 'PUTAH CREEK' CREEPING MYOPORUM	I GAL.	3'-6" O.C.	YES	٦	208
+	<b>5-3</b>	LANTANA X 'NEW GOLD' LANTANA NEW GOLD	I GAL.	3'-6" O.C.	NOT LISTED	>L	78
	<b>S-4</b>	PHORMIUM TENAX SURFER NEW ZEALAND FLAX	5 <i>G</i> AL.	4'-0" O.C.	YES	٦	120
	S-5	WESTRINGIA BLUE GEM BLUE GEM COAST ROSEMARY	5 GAL.	3'-6" O.C.	NOT LISTED	L	68
*	9-6	ROSMARINUS OFFICINALIS 'TUSCAN BLUE' UPRIGHT ROSEMARY	5 GAL.	4'-0" O.C.	YES	>L	77
Δ	<b>S-</b> 7	ELAEAGNUS PUNGENS SILVERBERRY	5 GAL.	4'-0" O.C.	NOT LISTED	٦	38
	5-8	BIOSWALE SOIL MEDIA / DETENTION BASIN PLANTING - MUHLENBERGIA CAPILLARIS	I GAL	3'-6" O.C.	YES	М	247
	-	MULCH - SYMBOL SHOWN FOR REFERENCE IN MULCH ONLY AREAS	PER SPECS	ALL SHRUB AREAS TO RECEIVE MULCH		-	-

- 2. ALL PLANTING AND IRRIGATION SHALL ABIDE BY THE RANCHO SANTIAGO COMMUNITY COLLEGE DISTRICT FACILITY DESIGN
- STANDARDS AND PLANTING AND IRRIGATION SPECIFICATIONS.
- 3. SEE CIVIL ENGINEER'S PLANS FOR DEMOLITION AND PROTECT IN PLACE ITEMS.

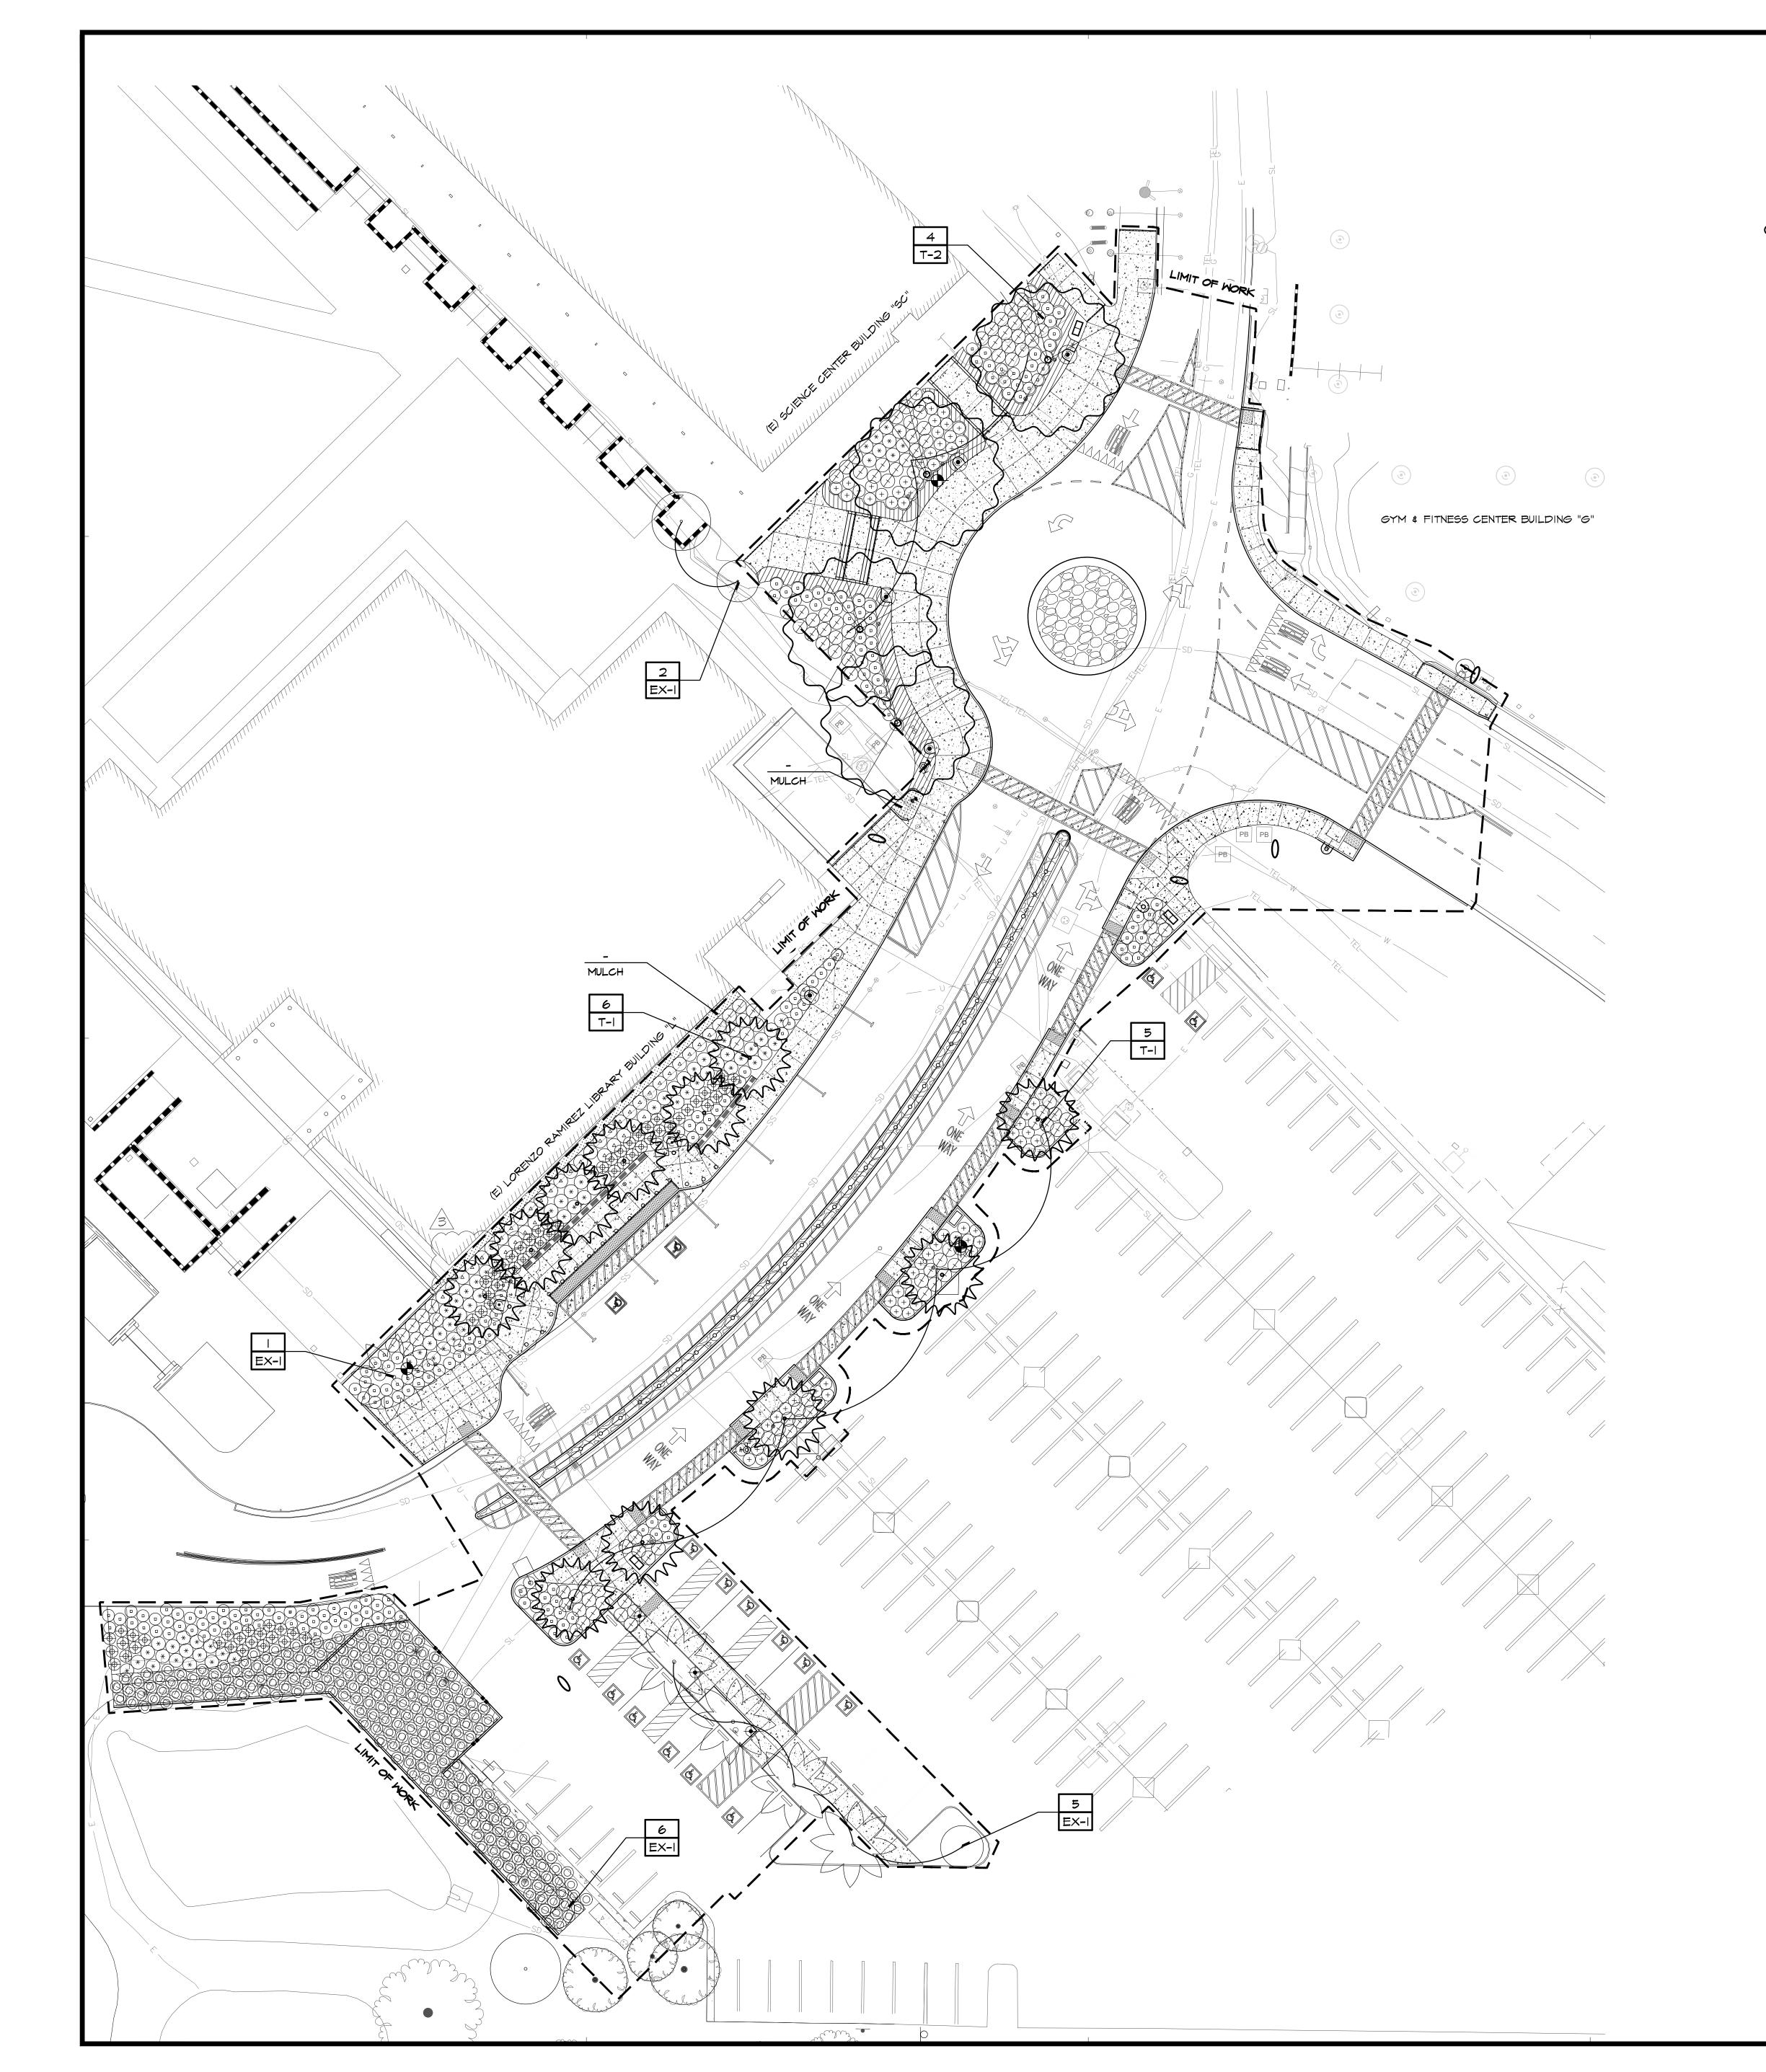  4. ALL TREES TO BE LOCATED A MINIMUM OF 15' FEET AWAY FROM ALL VERTICAL ELEMENTS INCLUDING; BUILDINGS, ROOF LINES / CANOPIES, FENCES, WALLS, ETC.

  5. ALL TREES TO BE LOCATED A MINIMUM OF 10' FEET AWAY FROM ALL EXISTING AND PROPOSED UNDERGROUND UTILITIES.

  6. ALL TREE LOCATIONS SHALL BE STAKED PRIOR TO PLANTING FOR REVIEW AND APPROVAL BY DISTRICT REPRESENTATIVE.
- ALL PLANT MATERIAL (SHRUBS, GROUNDCOVERS) SHALL BE PLANTED MINIMUM 18" AWAY FROM BUILDINGS, WALLS, FENCES,
- ETC. AREA SHALL BE MULCHED ONLY.

  8. ALL SHRUB AND GROUNDCOVER AREAS TO RECEIVE 4" MULCH LAYER PER DISTRICT FACILITY DESIGN STANDARDS AND DETAILS.
- 9. ALL TREES SHALL NOT HAVE BRANCHES OR LIMBS LOWER THAN 80" WHERE ADJACENT TO PUBLIC WALKWAYS OR SIDEWALKS. CONTRACTOR SHALL LOCATE PROPOSED TREES PRIOR TO PLANTING FOR REVIEW AND APPROVAL BY
- COLLEGE AND DISTRICT. IF LIMBS INTERFERE WITH 80" CLEARANCE A CERTIFIED ARBORIST SHALL REVIEW PROPOSED PRUNING PRIOR TO LIMBS OR BRANCHES BEING CUT AS TO NOT COMPROMISE THE HEALTH OR STRUCTURE OF THE TREE.

  10. ALL TREES LOCATED WITHIN 8' OF ANY HARDSCAPE ELEMENTS (SIDEWALKS, WALLS, D.G., PAVERS, CURBS, ETC.) SHALL RECEIVE ROOT BARRIERS. ROOT BARRIER MODEL #:UB 24-2 UNIVERSAL BARRIER" BY "DEEP ROOT." CONTACT: (714) 898-0863. ROOT BARRIERS SHALL BE MINIMUM 24" DEEP BY 8' LONG PER TREE. SEE DISTRICT FACILITY DESIGN STANDARDS AND DETAILS.

### **REVISIONS:**


	DESCRIPTION	DATE
3	ADDENDUM 3	01/17/2023
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DAT	E ISSUED:	2018-11-1
PRO	JECT NO:	2018-4016

DSA APPLICATION NO: 04-121029 As indicated L-5.01 NUMBER:

SHEET TITLE: LANDSCAPE **PLANTING PLAN** 



Inc. All rights reserved.

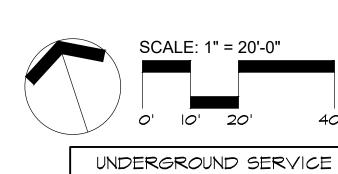

ALERT

TWO WORKING DAYS BEFORE YOU DIG

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		Chapman Avenue, Orange				Date Prep					
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Name or	Complete		Nani	Do aldiala		Nav	I I m li m la t		N/A	Claus	
Item Tag	Luminaire Description	Mounting Height from	Max Allowable	Backlight Rating		Max Allowable	Uplight Rating	Mounting Height	Max Allowable	Glare Rating	
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		, ,	Rating <sup>3</sup>	Design		Rating <sup>3</sup>	Design	. ,	Rating <sup>3</sup>	Design	
FX-2	Parking Light	> 2 MH from property line	No Limit	3	Area Lighting	UO	0	> 2 MH from property line	G3	2	
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NRCI-LTO-02-F - Must be submi		or an Energy Management Control System (EMCS), to be		├
recognized for compliance.	tted for a lighting control system, or to	of all Ellergy Management Control System (EMCS), to be		
P. DECLARATION OF REQUIRED CERTIFICATES OF A	CCEPTANCE			
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	rovided to the building inspector during	g construction and must be completed through an Accepta		
YES NO	Form/Title		Field In	spec
		was the standing where controls are added to 220	Pass	
NRCA-LTO-02-A - Must be subm	litted for all outdoor lighting controls e	except for alterations where controls area added to $\leq$ 20		1
NRCA-LTO-02-A - Must be subm luminaires.	itted for all outdoor lighting controls e	except for alterations where controls area added to \$ 20		

LERTIFICAT	TE OF COMPLIANCE									NRC	C-LTO-E
roject Nar	me: Santiago Canyon	COllege Cam	pus Entrance I	mprovement Pha	se 1	Report Page:			,	Pag	e 2 of 6
Project Add	dress: 8045 E. Chapman	Avenue, Ora	nge, CA 92869	e		Date Prepared:				5,	/4/2022
D. EXCEPT	TIONAL CONDITIONS										?
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Oesigned V  O1  Name or Item Tag  FX-1  FX-2	include existing luminain Wattage:  02  Complete Luminaire I  Pedestrian Light  Parking Light	Description Linear Linear	03 Watts per luminaire <sup>1,2</sup> 42 120	04  How Wattage is determined  Mfr. Spec <sup>1</sup> Mfr. Spec <sup>1</sup>	05  Total number luminaires²	Luminaire Status <sup>3</sup> New New	Excluded per	Design Watts  210  360	Cutoff Req. ≥ 6,200 initial lumen output 3 §130.2(b)⁴  NA: <6,200 lumens 3 Yes	Field In	spector
Oesigned V  O1  Name or Item Tag  FX-1  FX-2  FX-3	include existing luminain Wattage:  02  Complete Luminaire [ Pedestrian Light Parking Light Bollard	Description Linear Linear Linear	03  Watts per luminaire <sup>1,2</sup> 42  120  40	O4  How Wattage is determined  Mfr. Spec <sup>1</sup> Mfr. Spec <sup>1</sup> Mfr. Spec <sup>1</sup>	05  Total number luminaires²	Luminaire Status <sup>3</sup> New New New New	Excluded per	Design Watts  210  360  120	Cutoff Req. ≥ 6,200 initial lumen output 3 §130.2(b) <sup>4</sup> NA: <6,200 lumens Yes NA: <6,200 lumens	Field In	spector
Oesigned V  O1  Name or Item Tag  FX-1  FX-2  FX-3	include existing luminal Wattage:  02  Complete Luminaire I  Pedestrian Light  Parking Light  Bollard  Step Light	Description Linear Linear Linear Linear	03 Watts per luminaire <sup>1,2</sup> 42 120 40 6	O4  How Wattage is determined  Mfr. Spec <sup>1</sup> Mfr. Spec <sup>1</sup> Mfr. Spec <sup>1</sup>	O5  Total number luminaires²  5	Luminaire Status <sup>3</sup> 3 New 3 New New New	Excluded per	Design Watts  210  360  120  36	Cutoff Req. ≥ 6,200 initial lumen output 3 §130.2(b) <sup>4</sup> NA: <6,200 lumens Yes NA: <6,200 lumens	Field In	spector
Oesigned V  O1  Name or Item Tag  FX-1  FX-2  FX-3	include existing luminal Wattage:  02  Complete Luminaire I  Pedestrian Light  Parking Light  Bollard  Step Light  Existing Parking Ltg	Description  Linear Linear Linear Linear Linear Linear	03  Watts per luminaire <sup>1,2</sup> 42  120  40  6  120	O4  How Wattage is determined  Mfr. Spec <sup>1</sup> Mfr. Spec <sup>1</sup> Mfr. Spec <sup>1</sup>	Total number luminaires <sup>2</sup> 5  3 6	Luminaire Status <sup>3</sup> 3 New 3 New New New New Exist. Reinstalled	Excluded per	Design Watts  210  360  120  36  480	Cutoff Req. ≥ 6,200 initial lumen output 3 §130.2(b) <sup>4</sup> NA: <6,200 lumens Yes NA: <6,200 lumens	Field In	spector
Ol Name or Item Tag  FX-1  FX-2  FX-3	include existing luminal Wattage:  02  Complete Luminaire D  Pedestrian Light Parking Light Bollard Step Light Existing Parking Ltg Existing Ped Ltg	Description Linear Linear Linear Linear Linear Linear Linear	03  Watts per luminaire <sup>1,2</sup> 42  120  40  6  120  42	O4  How Wattage is determined  Mfr. Spec <sup>1</sup> Mfr. Spec <sup>1</sup> Mfr. Spec <sup>1</sup>	Total number luminaires <sup>2</sup> 5  3  6  4  3	Luminaire Status³  3  New 3 New New New Exist. Reinstalled Exist. Reinstalled	Excluded per	Design Watts  210  360  120  36  480  126	Cutoff Req. ≥ 6,200 initial lumen output 3 §130.2(b) <sup>4</sup> NA: <6,200 lumens Yes NA: <6,200 lumens	Field In	spector
Name or Item Tag  FX-1 FX-2 FX-3	include existing luminal Wattage:  02  Complete Luminaire I  Pedestrian Light  Parking Light  Bollard  Step Light  Existing Parking Ltg  Existing Ped Ltg  Existing Parking Ltg	Description Linear Linear Linear Linear Linear Linear Linear Linear Linear	03  Watts per luminaire <sup>1,2</sup> 42  120  40  6  120  42  120	O4  How Wattage is determined  Mfr. Spec <sup>1</sup> Mfr. Spec <sup>1</sup> Mfr. Spec <sup>1</sup>	Total number luminaires²  5  3  4  3  2	Luminaire Status³  3  New 3 New New New Exist. Reinstalled Exist. Reinstalled Exist. Remain	Excluded per §140.7(a)	Design Watts  210  360  120  36  480  126  240  84	Cutoff Req. ≥ 6,200 initial lumen output 3 §130.2(b) <sup>4</sup> NA: <6,200 lumens Yes NA: <6,200 lumens	Field In	spector
Name or Item Tag  FX-1 FX-2 FX-3 FX-4	include existing luminal Wattage:  02  Complete Luminaire I  Pedestrian Light  Parking Light  Bollard  Step Light  Existing Parking Ltg  Existing Ped Ltg  Existing Parking Ltg	Description Linear Linear Linear Linear Linear Linear Linear Linear Linear	03  Watts per luminaire <sup>1,2</sup> 42  120  40  6  120  42  120  42	O4  How Wattage is determined  Mfr. Spec¹  Mfr. Spec¹  Mfr. Spec¹  Mfr. Spec¹	Total number luminaires²  5  3  4  3  2  2	Luminaire Status³  3  New 3 New New Exist. Reinstalled Exist. Remain Exist. Remain Total Desig	Excluded per §140.7(a)	Design Watts  210  360  120  36  480  126  240  84	Cutoff Req. ≥ 6,200 initial lumen output 3 §130.2(b) <sup>4</sup> NA: <6,200 lumens Yes NA: <6,200 lumens	Field In	spector
Name or Item Tag  FX-1 FX-2 FX-3 FX-4  * NOTES: S	Include existing luminal Wattage:  02  Complete Luminaire Dedestrian Light Parking Light Bollard Step Light Existing Parking Ltg Existing Ped Ltg Existing Parking Ltg Existing Ped Ltg Existing Ped Ltg	Description Linear Linear Linear Linear Linear Linear Linear Linear Linear	03  Watts per luminaire <sup>1,2</sup> 42  120  40  6  120  42  120  42	O4  How Wattage is determined  Mfr. Spec¹  Mfr. Spec¹  Mfr. Spec¹  Mfr. Spec¹	Total number luminaires²  5  3  4  3  2  2	Luminaire Status³  3  New 3 New New Exist. Reinstalled Exist. Remain Exist. Remain Total Desig	Excluded per §140.7(a)	Design Watts  210  360  120  36  480  126  240  84	Cutoff Req. ≥ 6,200 initial lumen output 3 §130.2(b) <sup>4</sup> NA: <6,200 lumens Yes NA: <6,200 lumens	Field In	spector
Name or Item Tag  FX-1 FX-2 FX-3 FX-4  * NOTES: S	Include existing luminal Wattage:  02  Complete Luminaire I  Pedestrian Light  Parking Light  Bollard  Step Light  Existing Parking Ltg  Existing Ped Ltg  Existing Parking Ltg  Existing Ped Ltg  Existing Ped Ltg	Description Linear Linear Linear Linear Linear Linear Linear Linear Linear	03  Watts per luminaire <sup>1,2</sup> 42  120  40  6  120  42  120  42	O4  How Wattage is determined  Mfr. Spec¹  Mfr. Spec¹  Mfr. Spec¹  Mfr. Spec¹	Total number luminaires²  5  3  4  3  2  2	Luminaire Status³  3  New 3 New New Exist. Reinstalled Exist. Remain Exist. Remain Total Desig	Excluded per §140.7(a)	Design Watts  210  360  120  36  480  126  240  84	Cutoff Req. ≥ 6,200 initial lumen output 3 §130.2(b) <sup>4</sup> NA: <6,200 lumens Yes NA: <6,200 lumens	Field In	spector

ERTIFICATE OF COMPLIANCE								NRCC-I	LTO-
	yon COllege Campus E		rement Phase 1	Report				Page 4	
roject Address: 8045 E. Chap	man Avenue, Orange,	CA 92869		Date Pr	epared:			5/4,	/202
01		02		03		04		05	
Area Description Shut-Off §130.2(c)1			Auto-Schedule §130.2(c)2		Motion Sensor <u>§130.2(c)3</u>		Field Inspector Pass Fail		
Sidewalk	Astr	onomical Timer		Yes		NA: Façade, etc.	≤ 24ft		$\overline{1}$
Parking lot	Astr	onomical Timer		Yes	,	Yes			一
LIGHTING POWER ALLOW  Table Instructions: Please compliance calculations per §14  Single Table 140.7-A while "Use	olete this table for area <u>0.7</u> . General Hardscap	e Allowance	General		01 "Use it or lose it	" Allowances (sele	ect all that apply)		?
	<u>0.7</u> . General Hardscap e it or lost it" Allowance	pe Allowance es are per	General  ✓ Hardscape		"Use it or lose it				
expand sections for user input. he "Use it or lose it" allowanc			Allowance	Per Applicati	on Sales Fro	ontage Orr	namental   P	er Specific <i>A</i>	area
t or lose it" allowance.			Table I (below)	Table J	Table K	Tab	le L	Table M	
	Lighting Power Allowa	nce per <u>Table 1</u>	<u>140.7-A</u> (LZ 2 & 3)						
alculated General Hardscape	03	04	05	06	07	08	09	10	
alculated General Hardscape 02			Wattage Allowance		Linear \	Nattage Allowance	, ,	Total Gen	
02		Illuminated	Allowed Density	Area Allowance	Perimeter		Linear Allowance	AWA + LV (Watts)	
	Surface Type		/\///f+2\	(\\/2++c\	Length (lf)	(W/lf)	(Watts) 182	503.6	
02 Area Description	,,	Area (ft²)	(W/ft²)	(Watts)	455	0.4		505.0	
02	Surface Type  Concrete  Asphalt		(W/ft²) 0.03 0.025	(Watts) 321.6 1,182.5	455 445	0.4 0.25	111.25	1,293.7	
02 Area Description Sidewalk	Concrete	Area (ft²) 10,720	0.03	321.6	445	0.25	111.25	1,293.7	
02 Area Description Sidewalk	Concrete	Area (ft²) 10,720	0.03	321.6	445 Initial Wattage		111.25	1,293.7 1,797.3	

November 2019

CA Building Energy Efficiency Standards - 2019 Nonresidential Compliance: http://www.energy.ca.gov/title24/2019standards

NRCC-LTO-E (Created 11/19) CERTIFICATE OF COMPLIA	NCF		CALIFORNIA ENERG	NRCC-LTO-E
	Canyon COllege Campus Entrance Improvement Ph	ase 1 Report Page:		Page 6 of 6
<del>_</del>	Chapman Avenue, Orange, CA 92869	Date Prepared:		5/4/2022
DOCUMENTATION AUT	THOR'S DECLARATION STATEMENT			7
I certify that this Certificat	te of Compliance documentation is accurate and co	nplete		
Documentation Author Na	ame: Ed Burtch	Documentation Author Signatu	ire: EdBurth	
Company:	Goss Engineering	Signature Date:	5/4/2022	
Address:	255 East Rincon St., Suite 301	CEA/ HERS Certification Identif	ication (if applicable):	
City/State/Zip:	Corona, CA 92879	Phone:	(951) 340-1977	
<ol> <li>I am eligible under Div Compliance (responsib</li> <li>The energy features ar Certificate of Compliar</li> <li>The building design feat compliance documents</li> <li>I will ensure that a con</li> </ol>	ded on this Certificate of Compliance is true and co ision 3 of the Business and Professions Code to acc ole designer) ad performance specifications, materials, compone ace conform to the requirements of Title 24, Part 1 atures or system design features identified on this of s, worksheets, calculations, plans and specification appleted signed copy of this Certificate of Compliance	rrect.  ept responsibility for the building design of the building design of the standard manufactured devices for the building and Part 6 of the California Code of Regulaction of Compliance are consistent was submitted to the enforcement agency for the shall be made available with the building	ilding design or system design ident lations. vith the information provided on otl or approval with this building perming ng permit(s) issued for the building,	tified on this her applicable t application. and made available
<ol> <li>The information provides</li> <li>I am eligible under Div Compliance (responsibes</li> <li>The energy features are Certificate of Compliant</li> <li>The building design features</li> <li>I will ensure that a conto the enforcement ag</li> </ol>	ded on this Certificate of Compliance is true and co ision 3 of the Business and Professions Code to acc alle designer) and performance specifications, materials, compone acc conform to the requirements of Title 24, Part 1 atures or system design features identified on this of s, worksheets, calculations, plans and specification appleted signed copy of this Certificate of Compliance ency for all applicable inspections. I understand the ilder provides to the building owner at occupancy.	rrect.  ept responsibility for the building design of the building design of the standard manufactured devices for the building and Part 6 of the California Code of Regulaction of Compliance are consistent was submitted to the enforcement agency for the shall be made available with the building	uilding design or system design ident lations. vith the information provided on otl or approval with this building perming permit(s) issued for the building, cate of Compliance is required to be	tified on this her applicable t application. and made available
<ol> <li>The information provides</li> <li>I am eligible under Dive Compliance (responsibes</li> <li>The energy features are Certificate of Compliant</li> <li>The building design features documents</li> <li>I will ensure that a conto the enforcement age documentation the building the building design features</li> </ol>	ded on this Certificate of Compliance is true and co ision 3 of the Business and Professions Code to acc alle designer) and performance specifications, materials, compone acc conform to the requirements of Title 24, Part 1 atures or system design features identified on this of s, worksheets, calculations, plans and specification appleted signed copy of this Certificate of Compliance ency for all applicable inspections. I understand the ilder provides to the building owner at occupancy.	rrect.  ept responsibility for the building design of the pull of the formula design of the formula design of the formula design of the formula design of the California Code of Regul designed for the formula designed to the enforcement agency for the shall be made available with the building of the completed signed copy of this Certificate.	uilding design or system design ident lations. vith the information provided on otl or approval with this building perming permit(s) issued for the building, cate of Compliance is required to be	tified on this her applicable t application. and made available
<ol> <li>The information provides</li> <li>I am eligible under Div Compliance (responsibes</li> <li>The energy features are Certificate of Compliant</li> <li>The building design features documents</li> <li>I will ensure that a conto the enforcement age documentation the building designer Name</li> </ol>	ded on this Certificate of Compliance is true and co- ision 3 of the Business and Professions Code to acc- ile designer) and performance specifications, materials, compone acc conform to the requirements of Title 24, Part 1 atures or system design features identified on this of s, worksheets, calculations, plans and specification inpleted signed copy of this Certificate of Compliance ency for all applicable inspections. I understand the ilder provides to the building owner at occupancy.	rrect.  ept responsibility for the building design on the price of the building design on the price of the California Code of Regulation of Compliance are consistent was submitted to the enforcement agency for the shall be made available with the building at a completed signed copy of this Certific Responsible Designer Signature	tilding design or system design ident lations. with the information provided on other or approval with this building perming permit(s) issued for the building, cate of Compliance is required to be	tified on this her applicable t application. and made available
<ol> <li>The information provides</li> <li>I am eligible under Div Compliance (responsibles)</li> <li>The energy features are Certificate of Compliance</li> <li>The building design feat compliance documents</li> <li>I will ensure that a conto the enforcement age documentation the buse</li> <li>Responsible Designer Name</li> <li>Company:</li> </ol>	ded on this Certificate of Compliance is true and co- ision 3 of the Business and Professions Code to acc- ile designer) ad performance specifications, materials, compone- ince conform to the requirements of Title 24, Part 1 atures or system design features identified on this of is, worksheets, calculations, plans and specification inpleted signed copy of this Certificate of Compliance ency for all applicable inspections. I understand the ilder provides to the building owner at occupancy.  Bed Burtch  Goss Engineering	rrect.  ept responsibility for the building design of the purification of the California Code of Regulations are consistent with the submitted to the enforcement agency for the shall be made available with the building at a completed signed copy of this Certification of the California Code of Regulations are consistent with the suilding at a completed signed copy of this Certification of the California C	tilding design or system design ident lations.  With the information provided on other approval with this building permiting permit(s) issued for the building, cate of Compliance is required to be  E. B. B. L. B. L. S/4/2022	ified on this her applicable t application. and made available

# CHO SANTIAGO COMMUNITY

**REVISIONS:** DESCRIPTION ADDENDUM 3

DATE ISSUED: 2023-01-10 **PROJECT NO:** 2018-40167 **DSA APPLICATION NO:** 04-121029 SCALE: As indicated E-002


NUMBER:

SHEET TITLE:

TITLE 24



255 East Rincon St., Suite 301 Corona, CA 92879 P 951.340.1977 | F 951.340.1090 FILE NO.: 120-06-04

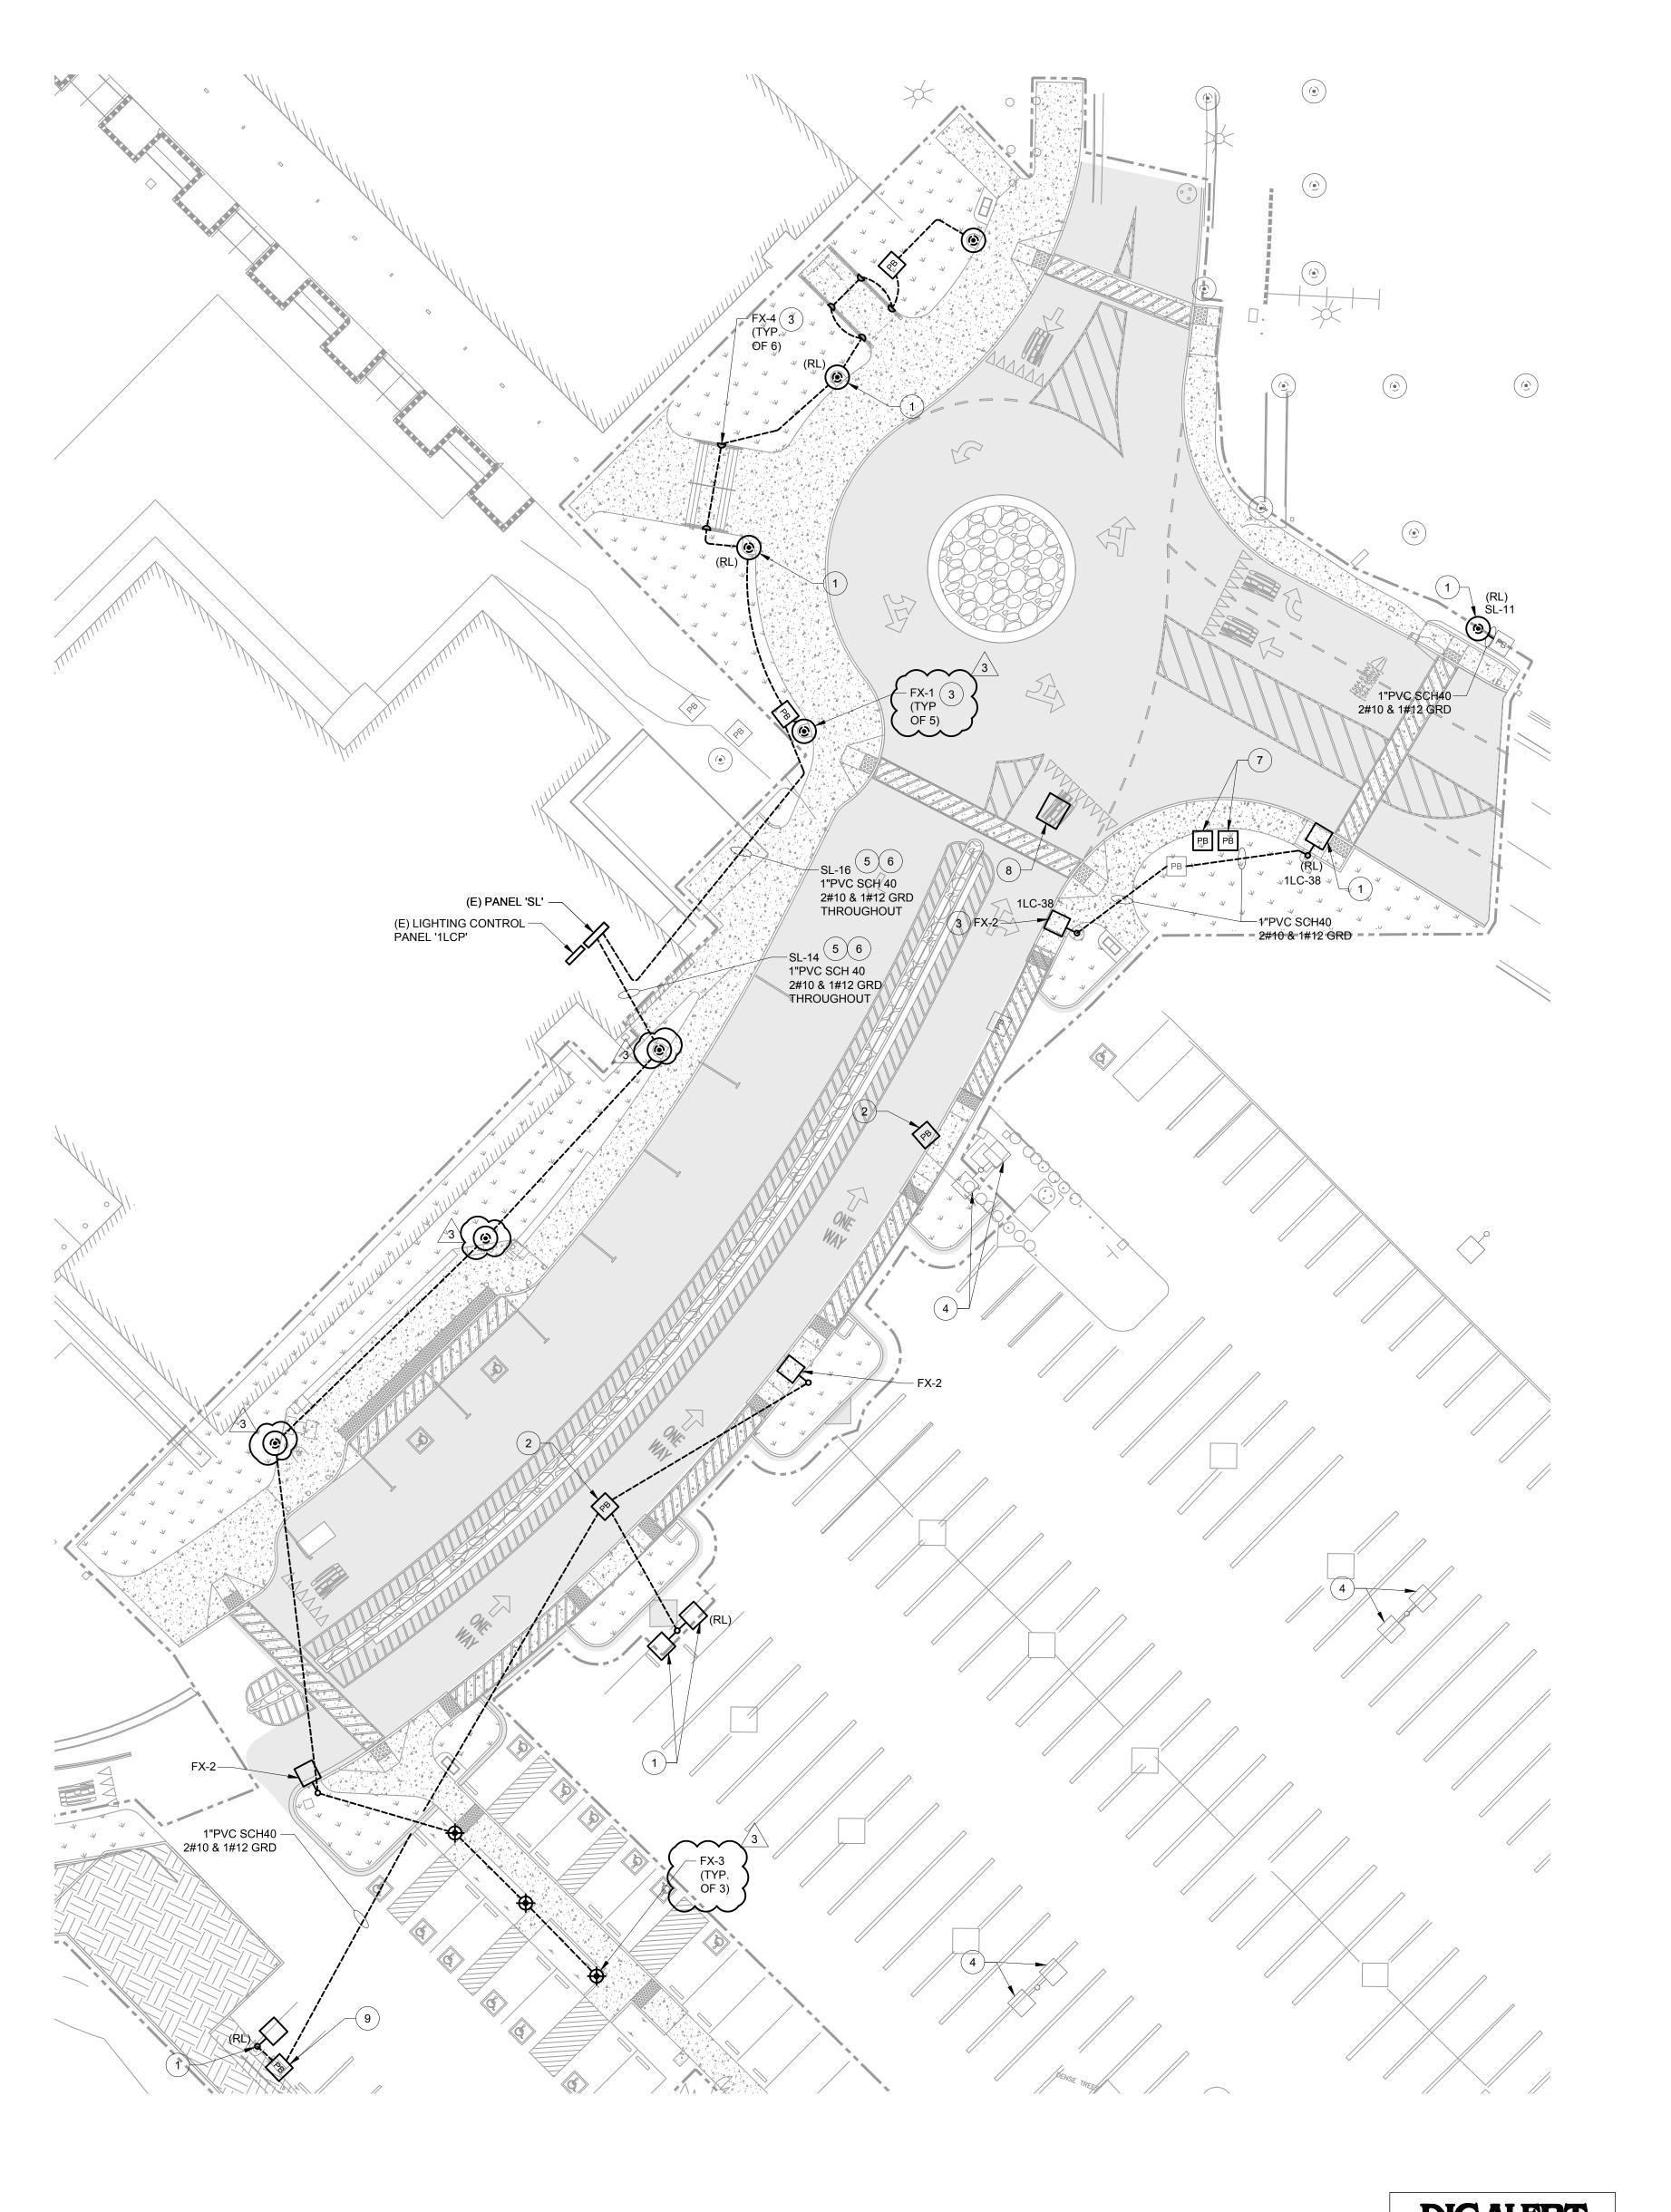

### **GENERAL NOTES:**


1. ELECTRICAL ENGINEERING FOR THIS PROJECT IS BASED ON EXISTING DRAWINGS AND A FIELD VISIT OF THE ELECTRICAL SYSTEM. IN CASE OF ANY DISCREPANCIES WITH EXISTING FIELD CONDITIONS, ELECTRICAL CONTRACTOR SHALL VERIFY THE EXACT DIFFERENCES AND NOTIFY THE ELECTRICAL ENGINEER FOR POSSIBLE

### RECONSTRUCTION NOTES:

- 1 NEW LOCATION OF RELOCATED POLE LIGHT. CONNECT TO EXISTING CIRCUIT AND CONTROLS, EXTEND CONDUIT AND WIRING TO MATCH EXISTING. PROVIDE NEW CONCRETE BASE TO MATCH EXISTING.
- 4 EXISTING LIGHT FIXTURE TO REMAIN AND BE PROTECTED IN PLACE.
- 6 ENTER BUILDING USING 'LB' CONDUIT BODY.

- REVISION TO THESE DOCUMENTS.
- MAINTAIN CONTINUITY OF ALL ELECTRICAL SYSTEMS, EQUIPMENT, ETC. REMAINING IN OPERATION.

- 2 LOWER PULL BOXES TO STREET LEVEL AND REPLACE WITH TRAFFIC RATED COVER AS REQUIRED.
- 3 NEW LIGHT FIXTURE. CONNECT TO EXISTING CIRCUIT AND
- 8 ROUTE THROUGH EXISTING TIME CLOCK IN LIGHTING CONTROL PANEL '1LCP'.
- 7 NEW LOCATION OF RELOCATED PULL BOX. EXTEND CONDUIT AND WIRING TO NEW LOCATION.
- 8 EDISON VAULT LOWERED TO STREET LEVEL. ALL WORK TO BE DONE BY SCE.
- 9 NEW LOCATION OF RELOCATED PULL BOX. EXTEND CONDUIT AND WIRING TO NEW LOCATION. PULL BOX TO BE AS CLOSE TO THE CURB AS POSSIBLE TO AVOID BIOFILTRATION AREA.

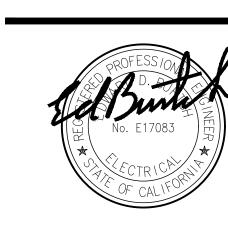

	DESCRIPTION	DATE
<u>3</u>	ADDENDUM 3	1/17/2023
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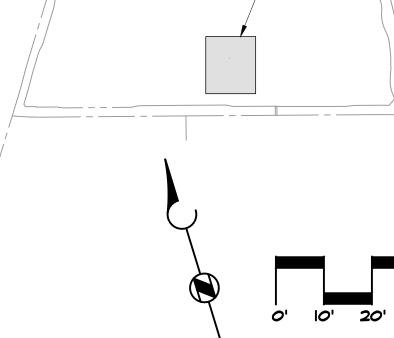
2023-01-10 DATE ISSUED: **PROJECT NO:** DSA APPLICATION NO: 04-121029

SHEET NUMBER: E-102 SHEET TITLE:

RECONSTRUCTION **POWER** AND LIGHTING **PLAN** 



FILE NO.: 120-06-04



RELOCATED

RECONSTRUCTION POWER AND LIGHTING PLAN

CALL 811 BEFORE YOU DIG.

SCALE 1" = 20'-0"

KEY PLAN SCALE
N.T.S.

- AREA OF WORK



### **GENERAL NOTES:**

- CALCULATION POINTS ARE 5' X 5' TYPICAL ON CENTER SPACING AT 0'-0" AFF.
- 2. TABLES, EQUIPMENT, PARTITIONS, STAIRS, SLOPE AND OTHER OBSTRUCTIONS ARE NOT INCLUDED IN THE CALCULATION RESULTS UNLESS DRAWN IN MODEL.
- 3. THE LIGHT FIXTURE USED FOR THE PHOTOMETRIC STUDY MAY VARY FROM THE LIGHT FIXTURE SCHEDULE ON SHEET E-601, DUE TO THE AVAILABILITY OF IES FILES. REFER TO SHEET E-601 FOR LIGHT FIXTURE SCHEDULE FOR THE COMPLETE SPECIFICATION AND MODEL NUMBER.
- 4. LUMINAIRE DATA IS OBTAINED ACCORDING TO IES PROCEDURES UNDER LABORATORY CONDITIONS. FIELD RESULTS MAY DIFFER FROM COMPUTER MODEL DUE TO MANY FACTORS INCLUDING BUT NOT LIMITED TO AMBIENT TEMPERATURE, LINE VOLTAGE VARIATION, INSTALLATION, REFLECTANCE AND OTHER SITE SPECIFIC CONDITIONS.
- 5. THIS LIGHTING PHOTOMETRIC STUDY IS NOT A SUBSTITUTE FOR AN INDEPENDENT ENGINEERING ANALYSIS AND THE COORDINATION OF LIGHTING SYSTEM SUITABILITY, FIXTURE PLACEMENT, FIXTURE SELECTION AND SAFETY TO COMPLY WITH LOCAL BUILDING CODES AND PROJECT PROGRAMMING.

## RANCHO SANTIAGO COMMUNITY COLLEGE DIST

ASSION D. SOLVETTI OF CALIFORNIA

	DESCRIPTION	DATE
<u>3</u>	ADDENDUM 3	1/17/202
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 DATE ISSUED:
 2023-01-10

 PROJECT NO:
 2018-40167


 DSA APPLICATION NO:
 04-121029

 SCALE:
 As indicated

 SHEET NUMBER:
 E-104


SHEET TITLE:

### PHOTOMETRIC PLAN

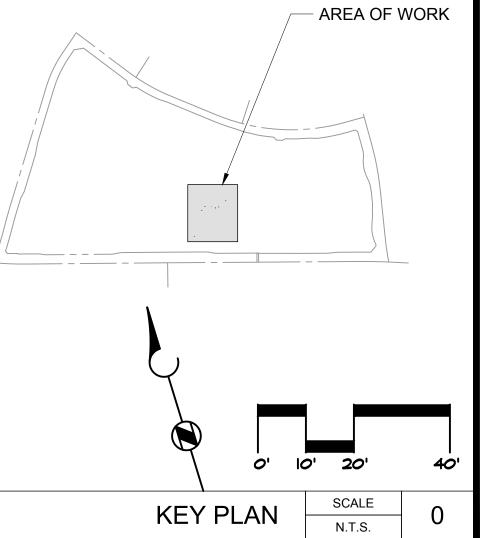

GE GOSS ENGINEERING 255 East Rincon St., Suite 301

Corona, CA 92879 P 951.340.1977 | F 951.340.1090 FILE NO.: 120-06-04

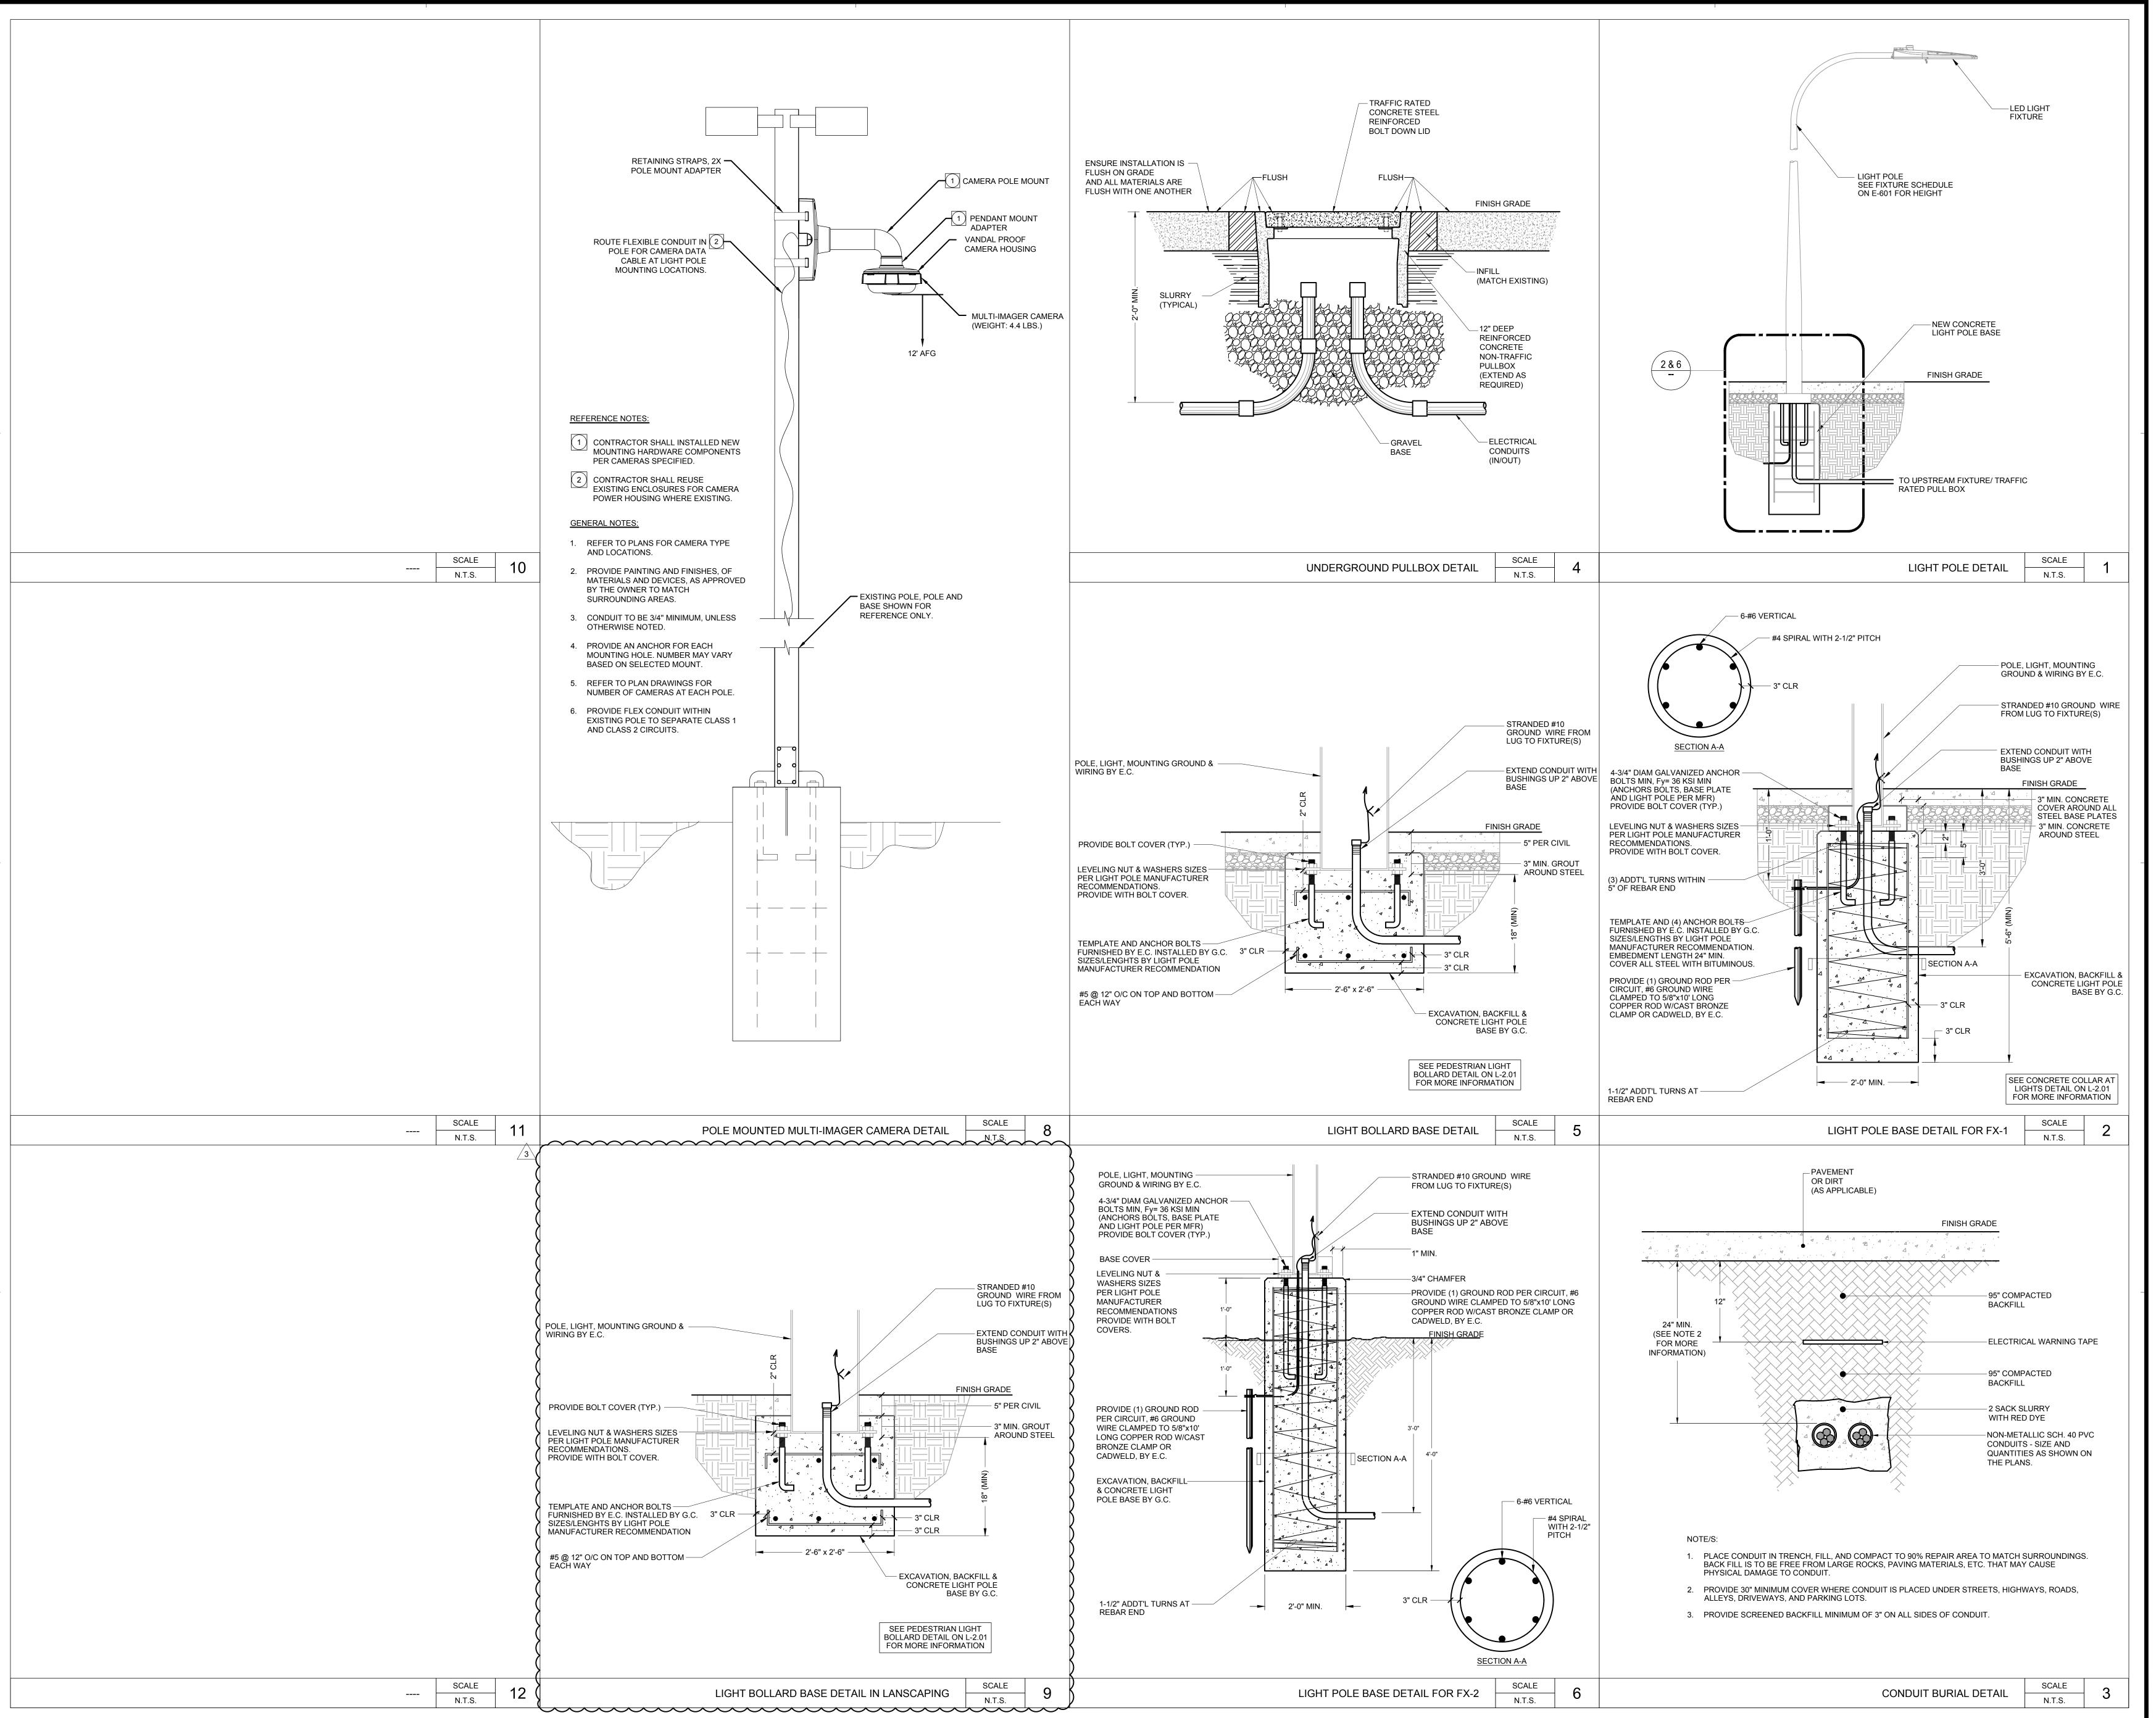

RANCHO SANTIAGO COMMUNITY COLLEGE DISTRIC
SANTIAGO CANYON COLLEGE

REVISIONS:

DESCRIPTION

ADDENDUM 3

1/17/20

DATE ISSUED: 2023-01-10
PROJECT NO: 2018-40167
DSA APPLICATION NO: 04-121029
SCALE: As indicated

E-501

SHEET TITLE:


SHEET

NUMBER:

**DETAILS** 

GOSS

255 East Rincon St., Suite 301 Corona, CA 92879 P 951.340.1977 | F 951.340.1090 FILE NO.: 120-06-04

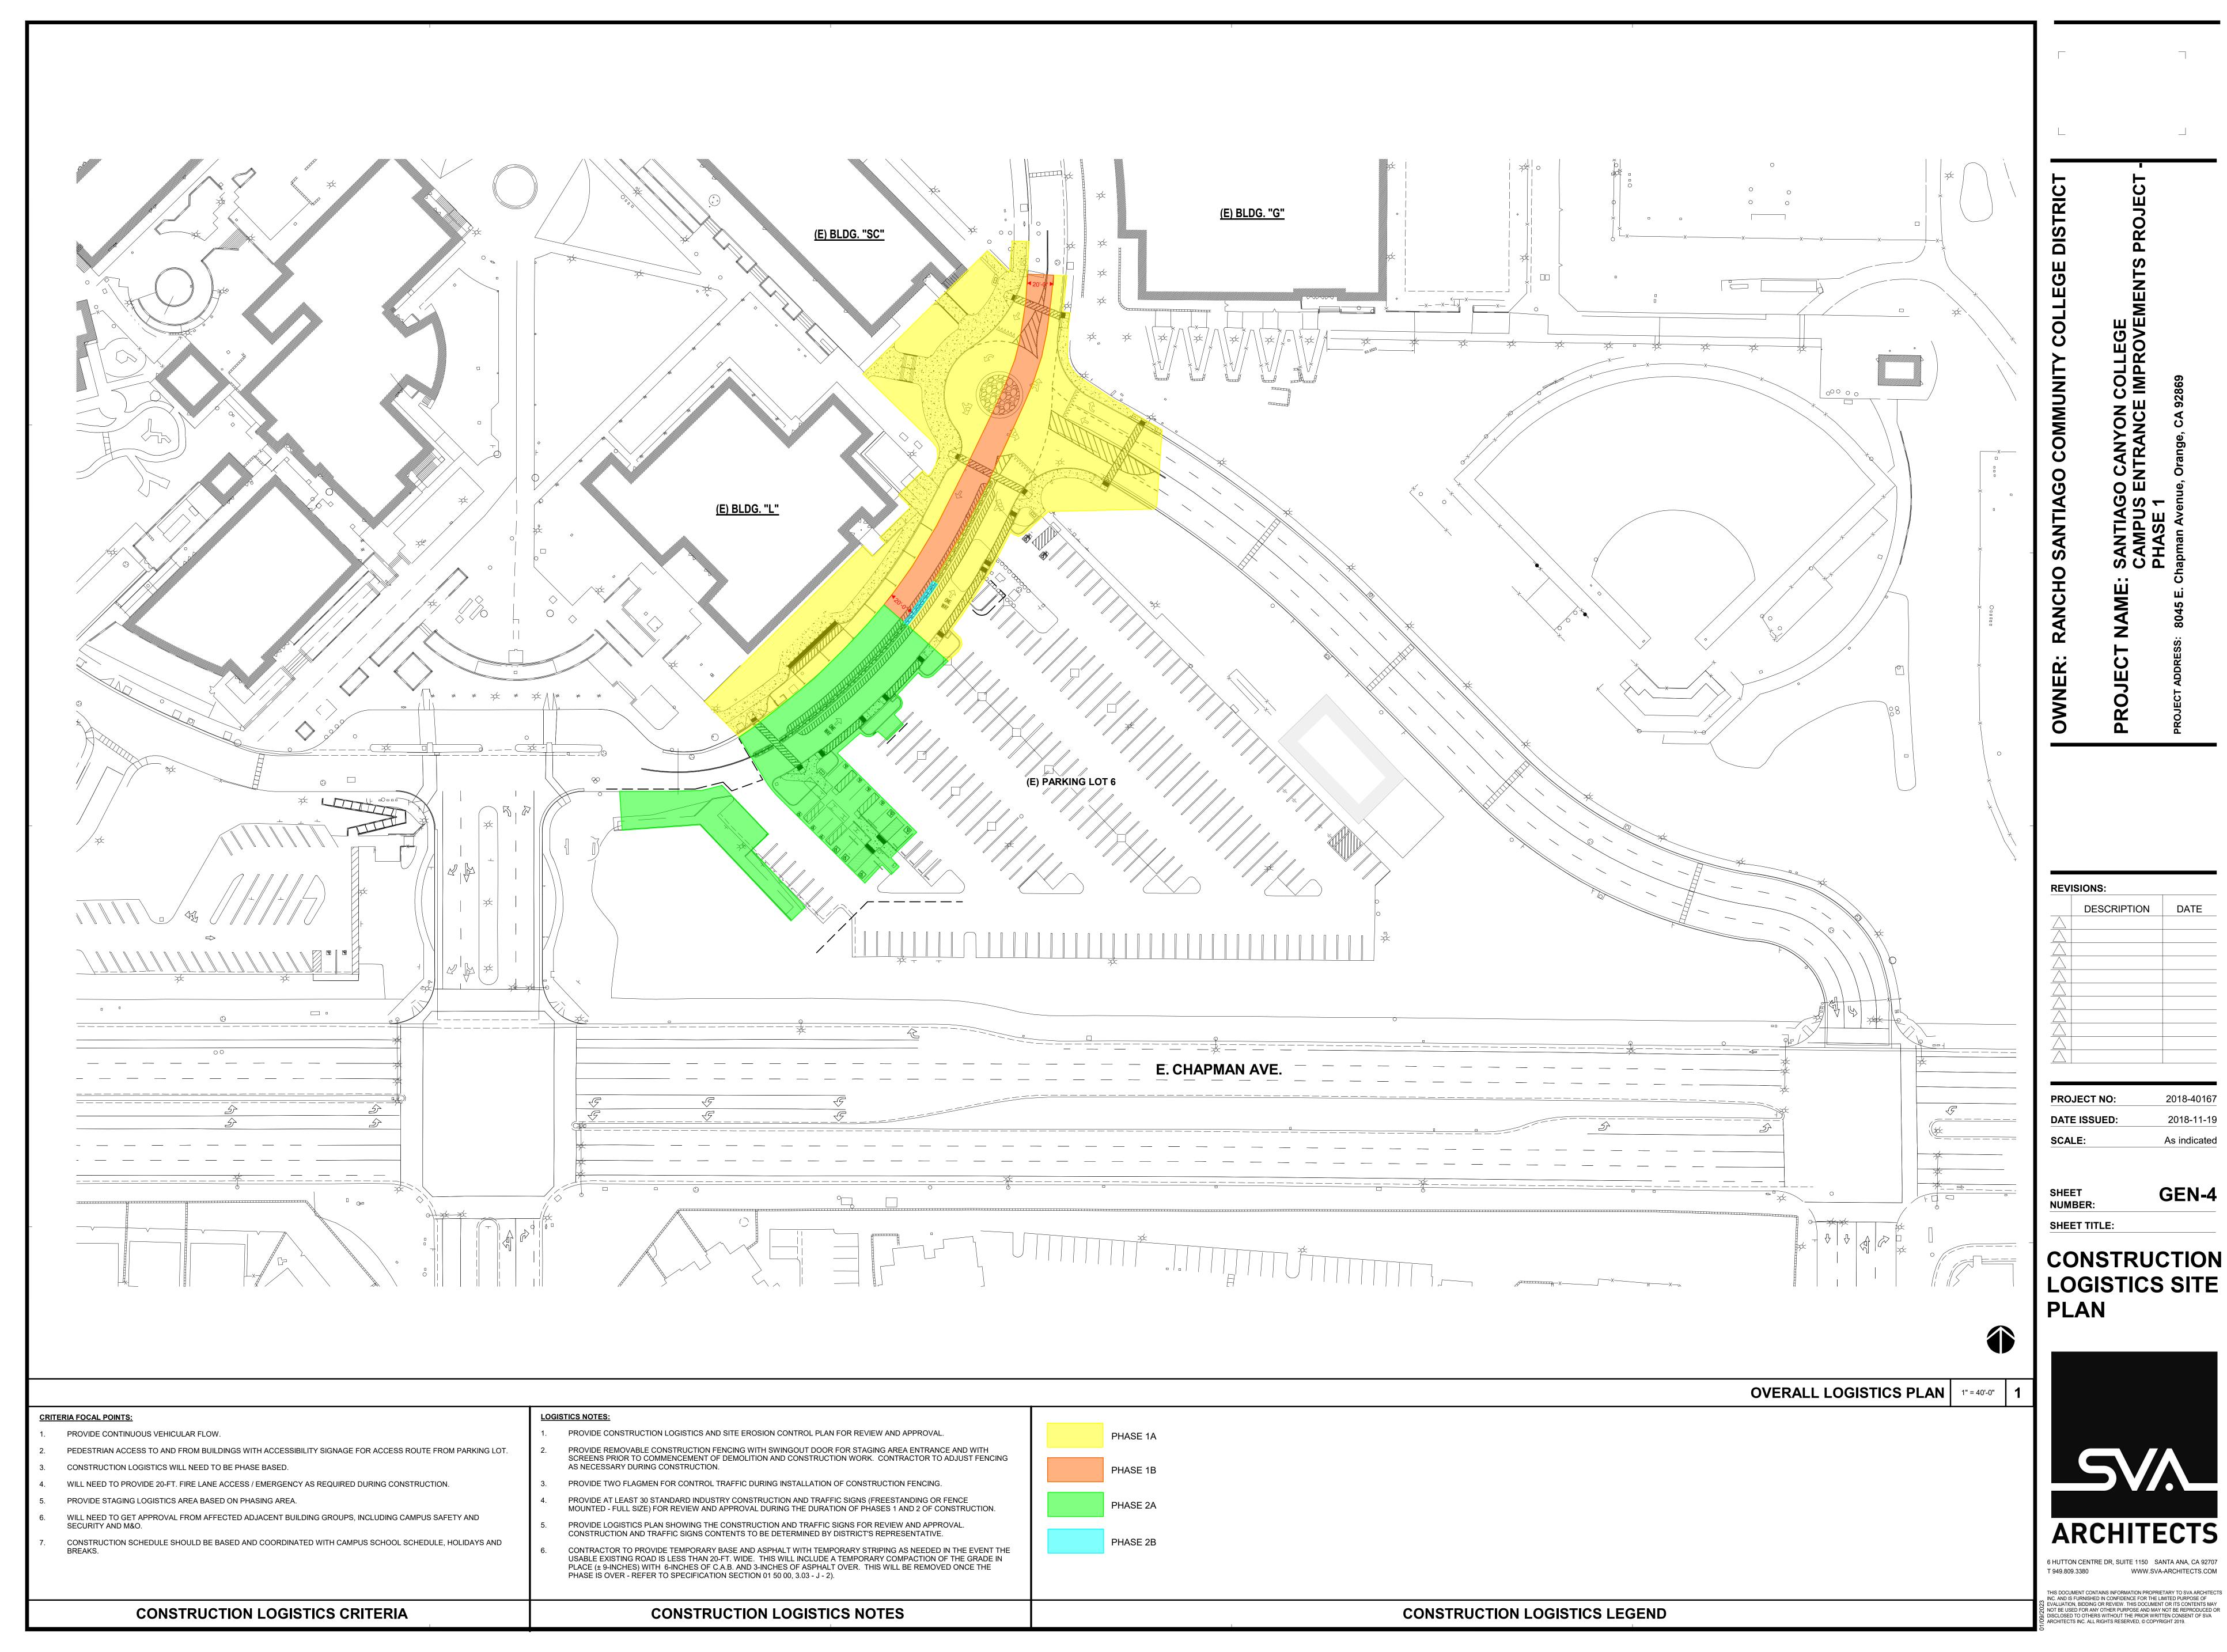


**REVISIONS:** DESCRIPTION

**PROJECT NO:** 2018-40167

GEN-4 SHEET TITLE:

CONSTRUCTION LOGISTICS SITE PLAN



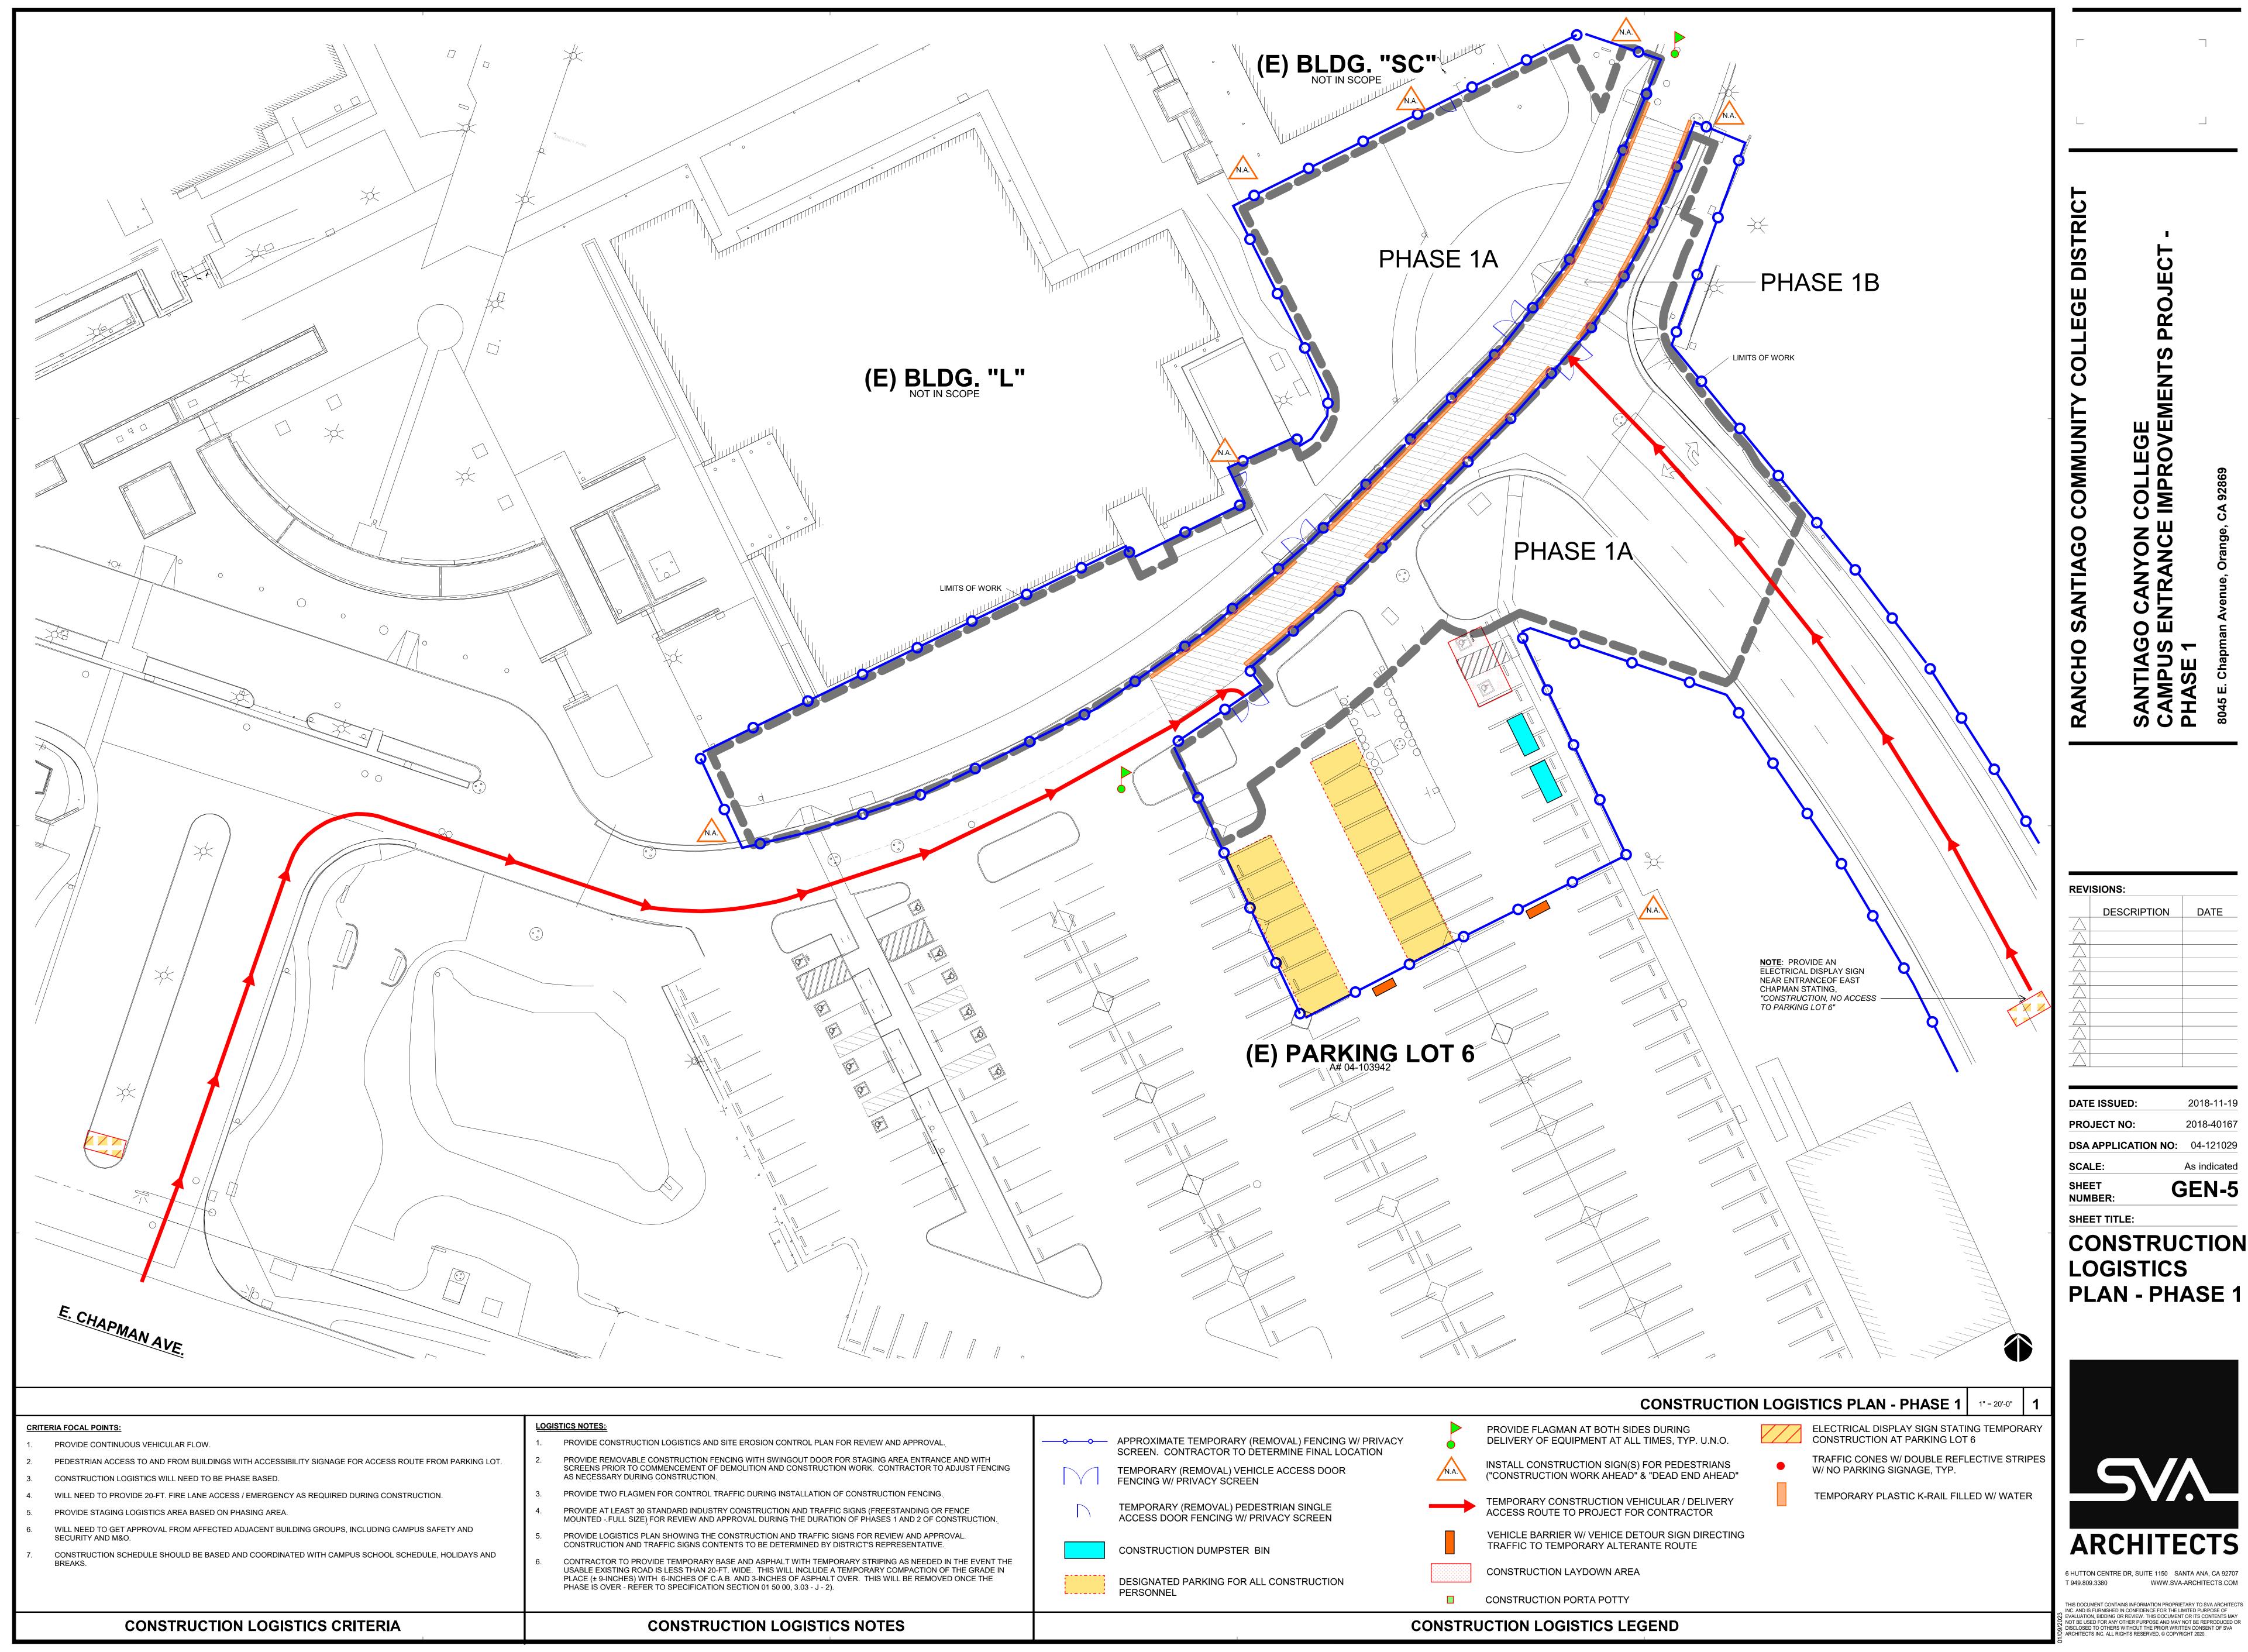

COLLEGE

**REVISIONS:** DATE DESCRIPTION


2018-11-19 DATE ISSUED: **PROJECT NO:** 2018-40167 **DSA APPLICATION NO:** 04-121029 As indicated SHEET NUMBER: GEN-5

CONSTRUCTION

LOGISTICS PLAN - PHASE 1



WWW.SVA-ARCHITECTS.COM

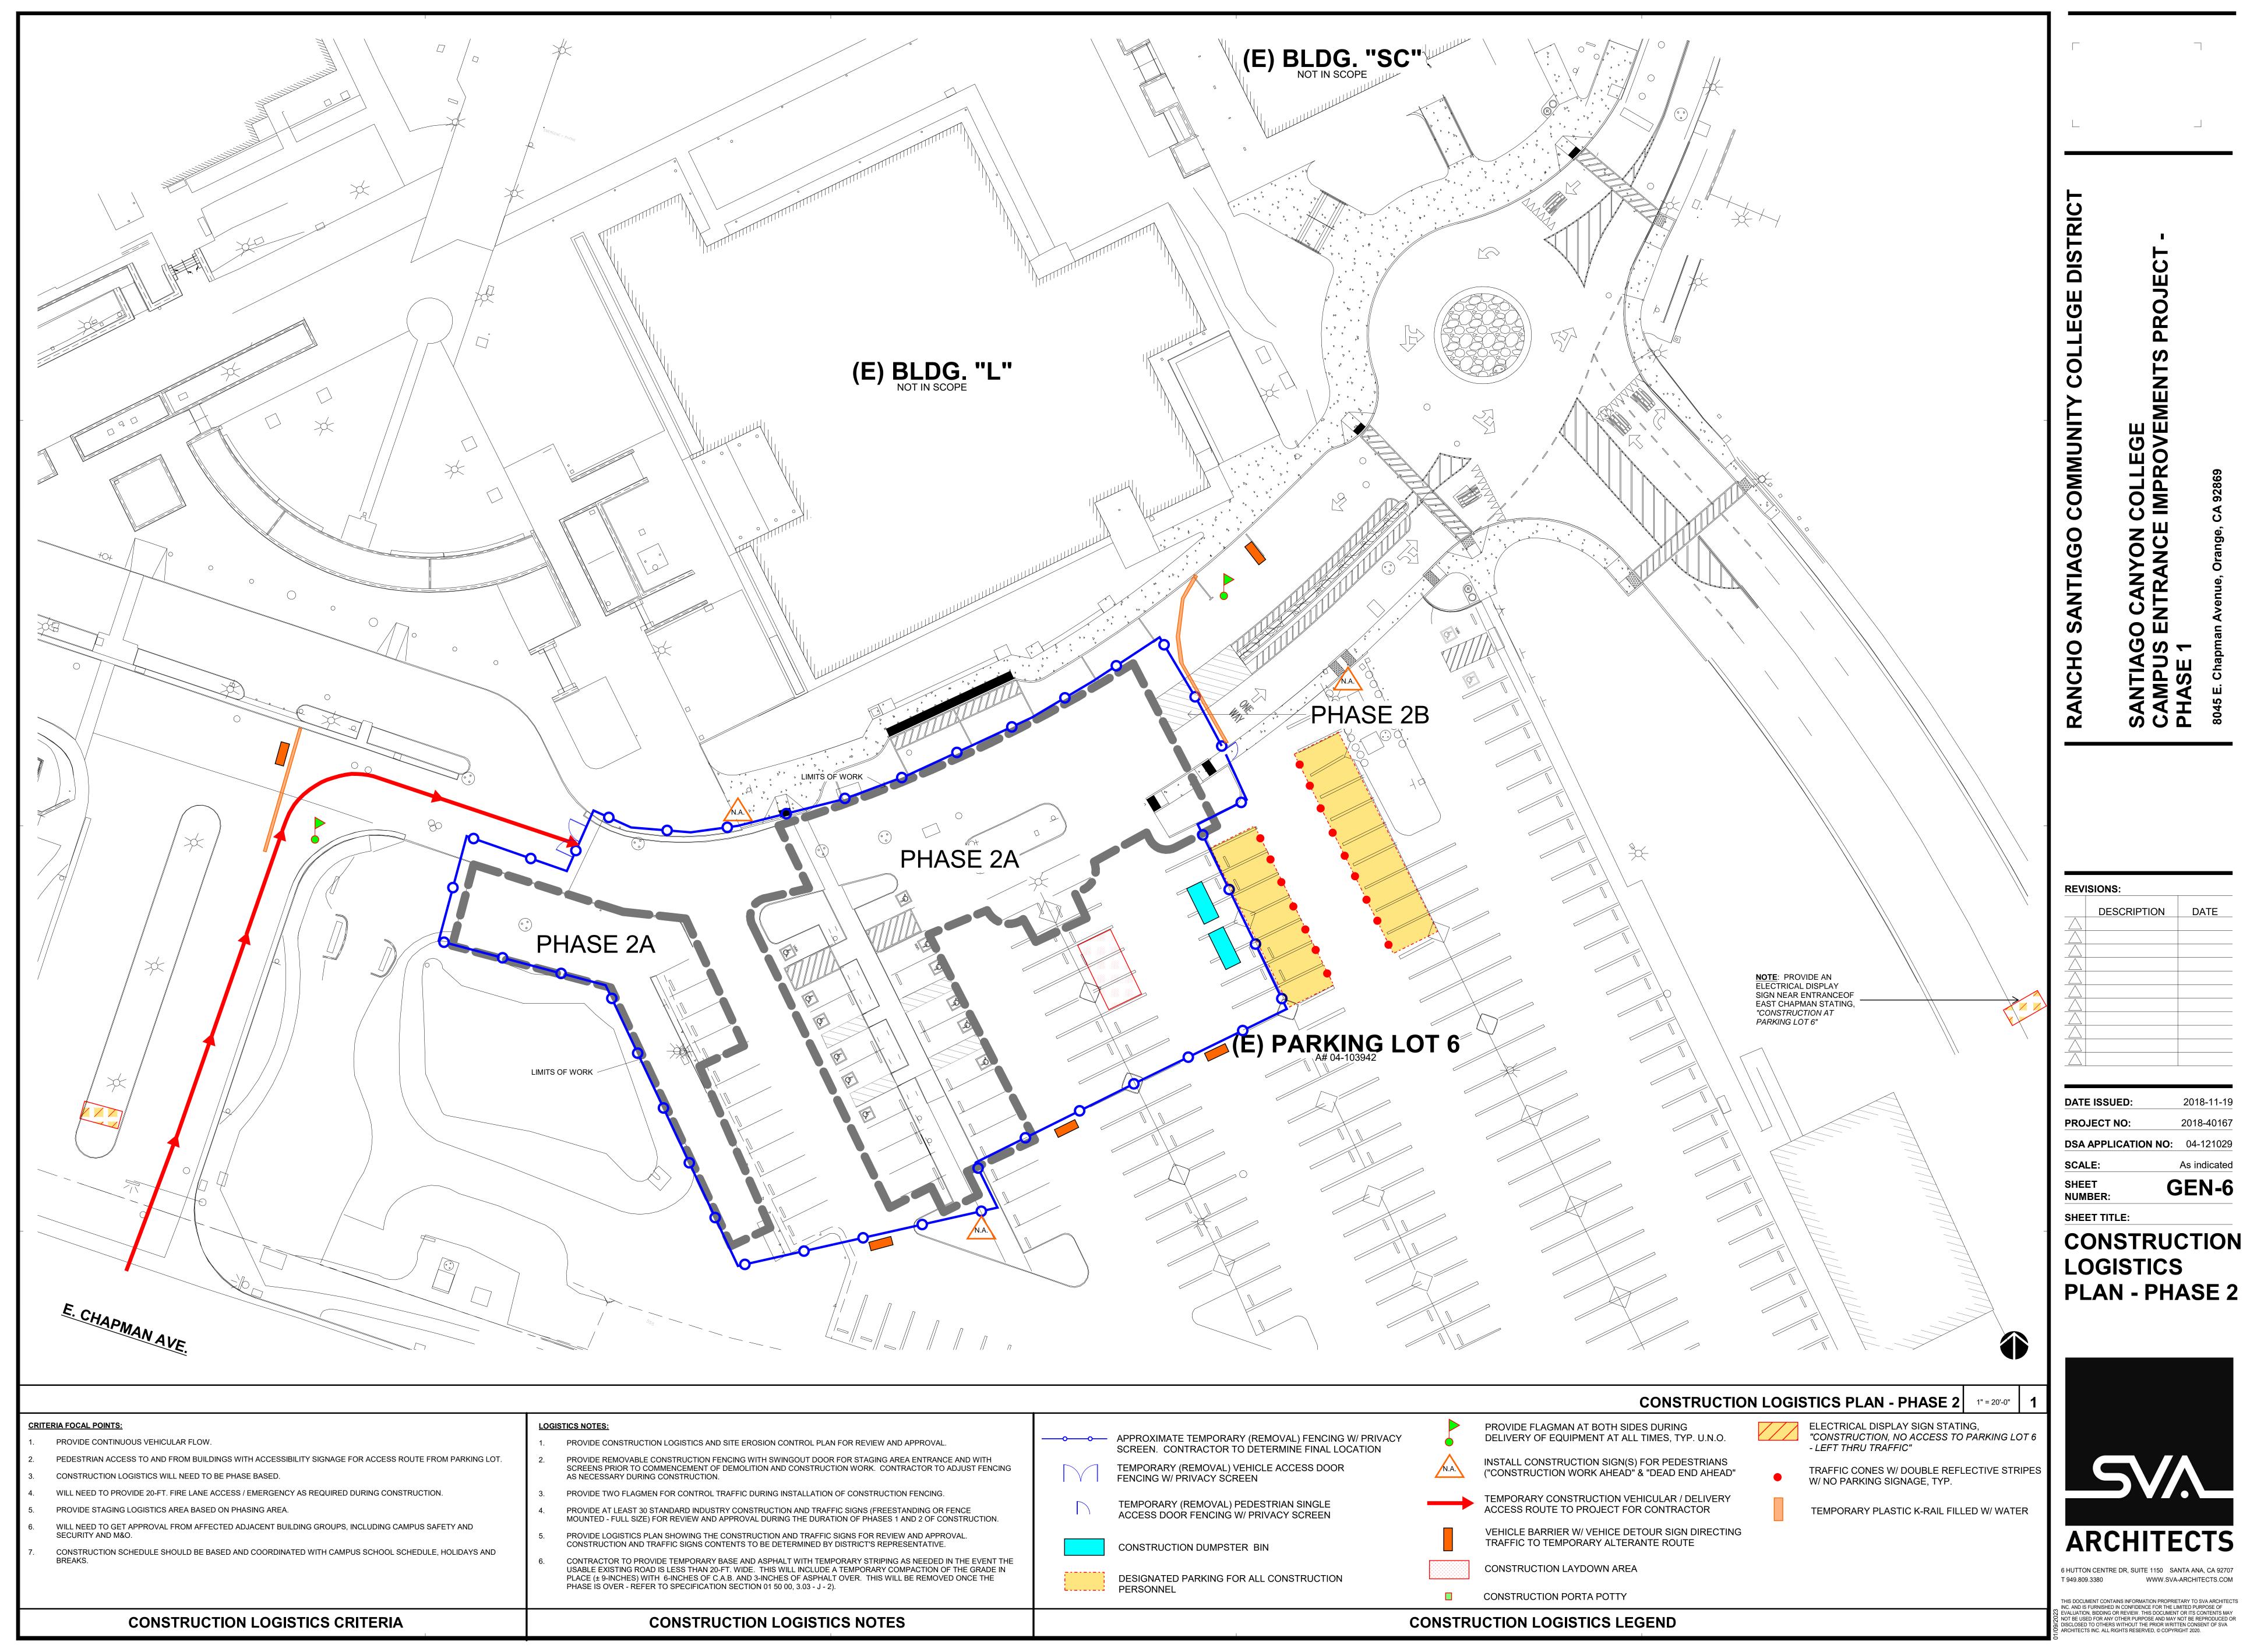

DATE DESCRIPTION

DATE ISSUED: 2018-11-19 **PROJECT NO:** 2018-40167 **DSA APPLICATION NO:** 04-121029 As indicated SCALE:

GEN-6

SHEET TITLE:

CONSTRUCTION LOGISTICS PLAN - PHASE 2



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