

JOHNSON STUDENT CENTER BUILDING DEMOLITION SANTA ANA C O L L E G E



GENERAL



www.hpiarchitecture.com

115 22nd street Newport Beach, CA 92663

o: 949.675.6442

SEALS / APPROVALS

PROJECT TITLE

2323 NORTH BROADWAY

SANTA ANA, CA 92706

DATE

JOHNSON STUDENT CENTER

RANCHO SANTIAGO

Community College District

SUBMITTALS

DESCRIPTION

PROJECT IDENTIFICATION Project Number

THESE DRAWINGS ORIGINALLY CREATED IN AUTODESK REVIT V. 2014

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THE ORIGINAL SIZE OF THIS SHEET IS 30" X 42".

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12/01/2015 90%CD SUBMITTAL 03/25/2016 100%CD SUBMITTAL 09/05/2018 | BID SUBMITTAL

BUILDING DEMOLITION

100% CONSTRUCTION DOCUMENTS

SEPTEMBER 5, 2018 PROJECT DIRECTORY SHEET INDEX

ARCHITECT
Hill Partnership, Inc, CIVIL ENGINEER
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ELECTRICAL AND PLUMBING ENGINEER P2S ENGINEERING, INC. 5000 East Spring Street, 8th Floor, Long Beach, CA 92660 Tel. (562) 497-2999 Fax (562) 497-2990 Contacts: Kirk Anglin, Project Manager Melissa Klug, Project Engineer

17TH STREET

GENERAL NOTES, SYMBOLS, AND ABBREVIATIONS C1.00 EXISTING SITE AND DEMOLITION PLAN C2.00 EROSION CONTROL PLAN SITE DEMOLITION PLAN - BUILDING AREA SITE DEMOLITION PLAN - SERVICE RAOD SITE DEMOLITION PLAN **ELECTRICAL** ELECTRICAL SITE DEMOLITION PLAN **BUILDING 'U' RECORD DRAWINGS** A#28861 BOOKSTORE: ARCHITECTURAL, STRUCTURAL, MECHANICAL AND

A#40279 BOOKSTORE ELEVATOR: ARCHITECTURAL, STRUCTURAL AND A#42364 STUDENT CENTER ADDITION: ARCHITECTURAL, STRUCTURAL,

MECHANICAL AND ELECTRICAL. A#49550 JOHNSON STUDENT CENTER: ARCHITECTURAL, STRUCTUAL, MECHANICAL AND ELECTRICAL.

APPLICABLE CODES

PART 1 2016 CALIFORNIA BUILDING STANDARDS ADMINISTRATIVE CODE, TITLE 24 C.C.R. PART 2 2016 CALIFORNIA BUILDING CODE, TITLE 24 C.C.R. (2015 INTERNATIONAL BUILDING CODE OF THE INTERNATIONAL CODE COUNCIL, WITH CALIFORNIA

PART 3 2016 CALIFORNIA ELECTRICAL CODE, TITLE 24 C.C.R. (2014 NATIONAL ELECTRICAL CODE OF THE NATIONAL FIRE PROTECTION ASSOCIATION, NFPA) PART 4 2016 CALIFORNIA MECHANICAL CODE, TITLE 24 C.C.R. (2015 UNIFORM MECHANICAL CODE OF THE INTERNATIONAL ASSOCIATION OF PLUMBING AND

PART 5 2016 CALIFORNIA PLUMBING CODE, TITLE 24 C.C.R. (2015 UNIFORM PLUMBING CODE OF THE INTERNATIONAL ASSOCIATION OF PLUMBING AND MECHANICAL OFFICIALS, IAPMO) PART 6 2016 CALIFORNIA ENERGY CODE, TITLE 24 C.C.R.

PART 7 CURRENTLY VACANT PART 8 2016 CALIFORNIA HISTORICAL BUILDING CODE, TITLE 24 C.C.R. PART 9 2016 CALIFORNIA FIRE CODE, TITLE 24 C.C.R.

MECHANICAL OFFICIALS, IAPMO)

(2015 INTERNATIONAL FIRE CODE OF THE INTERNATIONAL CODE COUNCIL) PART 10 2016 CALIFORNIA EXISTING BUILDING CODE, TITLE 24 C.C.R. (2015 INTERNATIONAL EXISTING BUILDING CODE OF THE INTERNATIONAL CODE COUNCIL, WITH PART 11 2016 CALIFORNIA GREEN BUILDING STANDARDS CODE (CALGREEN CODE), TITLE 24 C.C.R.

PROJECT DESCRIPTION


SUMMARY OF SCOPE

SCALE 1" = 100'-0"

CAMPUS MAP

THE PROJECT CONSISTS OF THE DEMOLITION OF THE EXISTING JOHNSON CENTER BUILDING, SLAB ON GRADE IN ITS ENTIREY AND SURROUNDING SITE.

VICINITY MAP

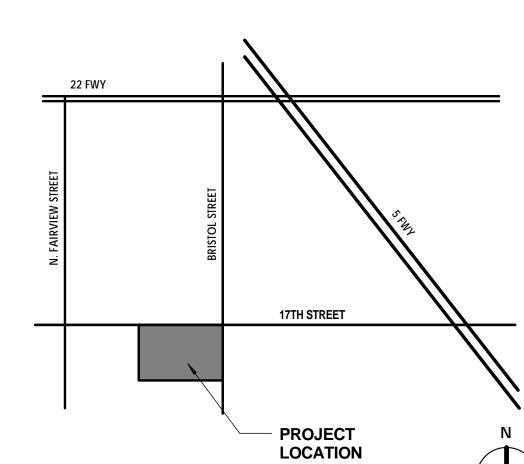


G0.01

TITLE SHEET

CONSTRUCTION DOCUMENTS

(E) RESTROOM BUILDING & A#43672 **BUS STOP** BLDG. 'R' BLDG. 'G' SOCCER FIELD TRACK & FIELD BLDG. BLDG. 'F' BLDG. 'I PART 12 2016 CALIFORNIA REFERENCED STANDARDS CODE, TITLE 24 C.C.R. PARKING LOT #12 CAMPUS ROAD **ENTRY SIGN** BASEBALL FIELD PARKING LOT #9 WASHINGTON AVENUE

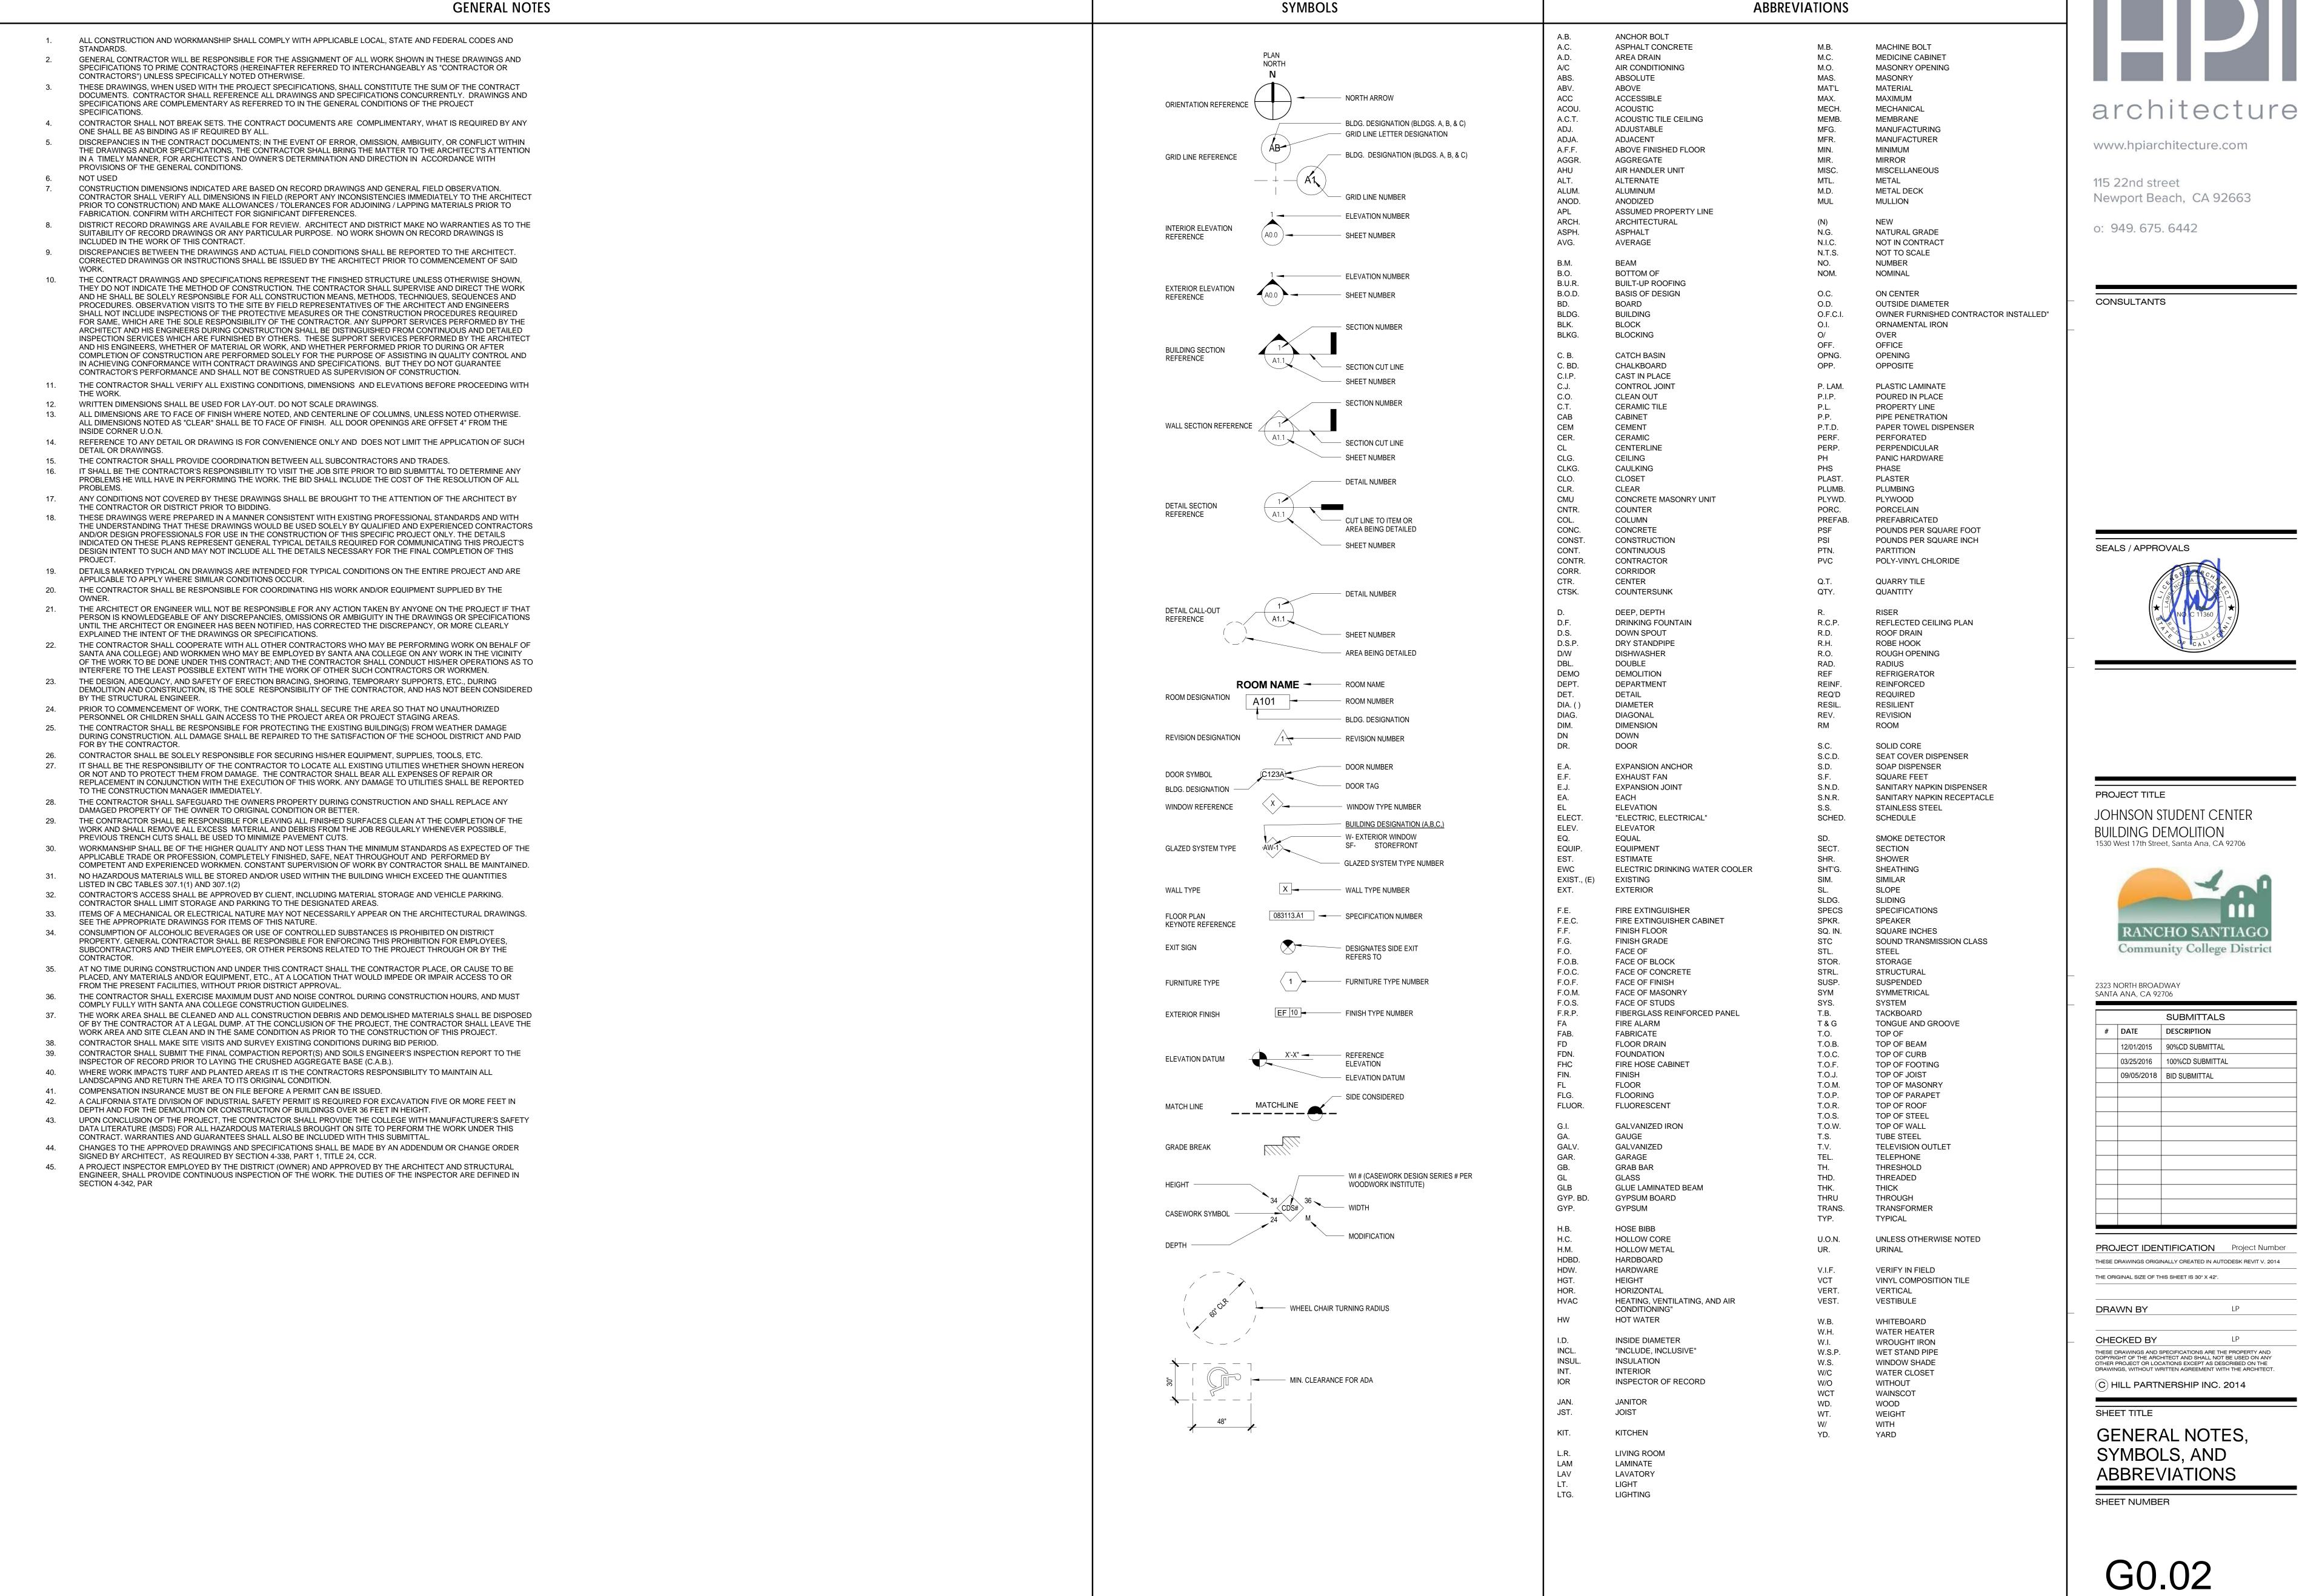

#	DATE	DESCRIPTION
	12/01/2015	90%CD SUBMITTAL
	03/25/2016	100%CD SUBMITTAL
	09/05/2018	BID SUBMITTAL

CONSTRUCTION DOCUMENTS

(S) SEWER MAN HOLE

∜ SEWER CLEAN OUT


 ▼
 SIGN

- 1. IT IS THE CONTRACTOR'S RESPONSIBILITY TO REVIEW THE PLANS THOROUGHLY PRIOR TO MOBILIZATIONS. IT IS ALSO THE GRADING CONTRACTOR'S RESPONSIBILITY TO NOTIFY THE CIVIL OF RECORD IF ONSITE DISCREPANCIES ARE OBSERVED THAT WOULD AFFECT THE EARTHWORK.
- 2. THE EXISTING TOPOGRAPHY SHALL BE UTILIZED AS THE BASIS FOR ALL EARTHWORK COMPUTATIONS. SAID TOPOGRAPHY SHALL BE PRESUMED TO BE ACCEPTABLE TO ALL INTERESTED PARTIES UNLESS A DEVIATION IS FOUND PRIOR TO THE START OF GRADING IN ANY SPECIFIC AREAS, ANY DEVIATION SO DETERMINED SHALL BE PROMPTLY TRANSMITTED TO ALL INTERESTED PARTIES.
- THE CONTRACTOR IS REQUIRED TO ESTIMATE THE QUANTITIES OF GRADING WORK TO BE DONE AND INCLUDE ALL COSTS THEREFROM WITHIN HIS BID, AND NO ADDITIONAL ALLOWANCE WILL BE MADE WITHOUT PRIOR CONSENT FROM THE OWNER.
- OFF-SITE DISPOSAL OF EXCAVATION MATERIAL IS THE RESPONSIBILITY OF THE CONTRACTOR AND SHALL BE INCLUDED IN HIS BID. THE CONTRACTOR SHALL HOLD THE OWNER AND ENGINEER HARMLESS AS A RESULT OF ANY CLAIMS ARISING FROM THE ACTIONS ENROUTE OR AWAY FROM THE SITE.
- 5. ANY EXPORT OR IMPORT REQUIRED TO BALANCE THE SITE SHALL BE THE SOLE RESPONSIBILITY OF THE CONTRACTOR.

* SEWER DEMOLITION NOTES:

EXISTING SEWER AS REQUIRED.

1. IF CONNECTION OF EXISTING SEWER SERVICING BLDG "L" TO PROPOSED SEWER ALONG EAST SIDE OF BLDG "U" HAS NOT BEEN ESTABLISHED, CONTRACTOR IS TO PROTECT IN PLACE THE EXISTING SEWER MAIN WITHIN BUILDING 'U' DURING DEMOLITION OF BUILDING 'U' UNTIL SUCH TIME THAT ALL SEWER LATERALS EASTERLY OF BUILDING 'U' HAVE BEEN CONNECTED TO THE PROPOSED SEWER SYSTEM OF THE "QUAD / INFRASTRUCTURE RENOVATION" PROJECT. IF CONFLICTS OCCUR DURING DEMOLITION, CONTRACTOR IS TO REPOUTE

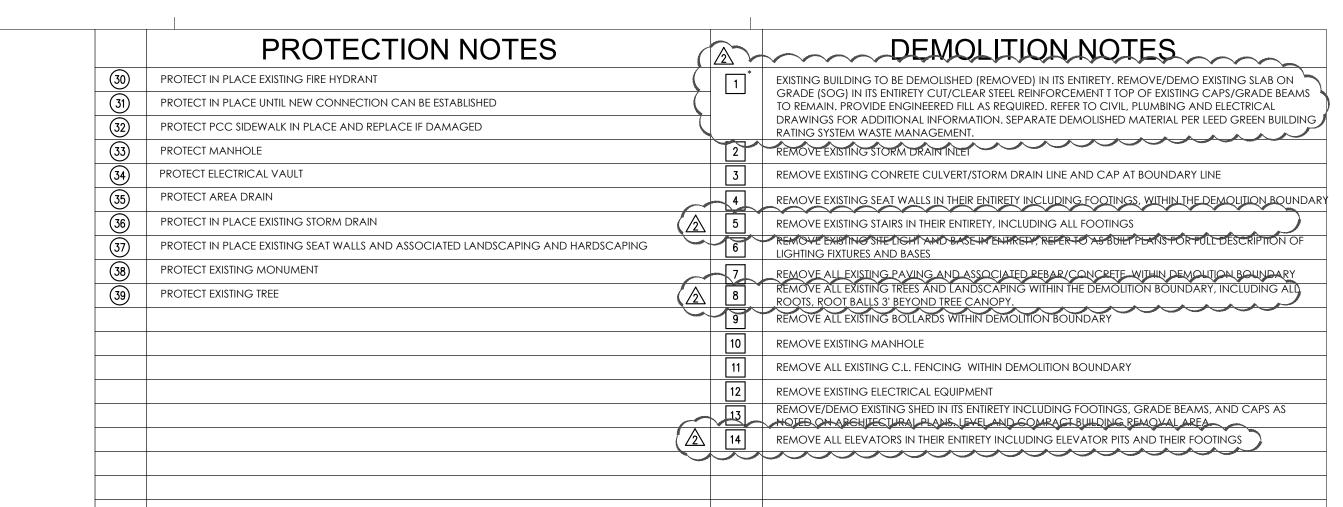



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CONSULTANTS







IDENTIFICATION STAMP

PROJECT TITLE JOHNSON STUDENT CENTER DEMOLITION 1530 West 17th Street, Santa Ana, CA 92706



2323 NORTH BROADWAY SANTA ANA, CA 92706

		SUBMITTALS
#	DATE	DESCRIPTION
	3/25/2016	100% CD SUBMITTAL
	5/15/2017	100% CD SUBMITTAL
	7/05/2017	100% CD SUBMITTAL
	09/05/2018	BID SET

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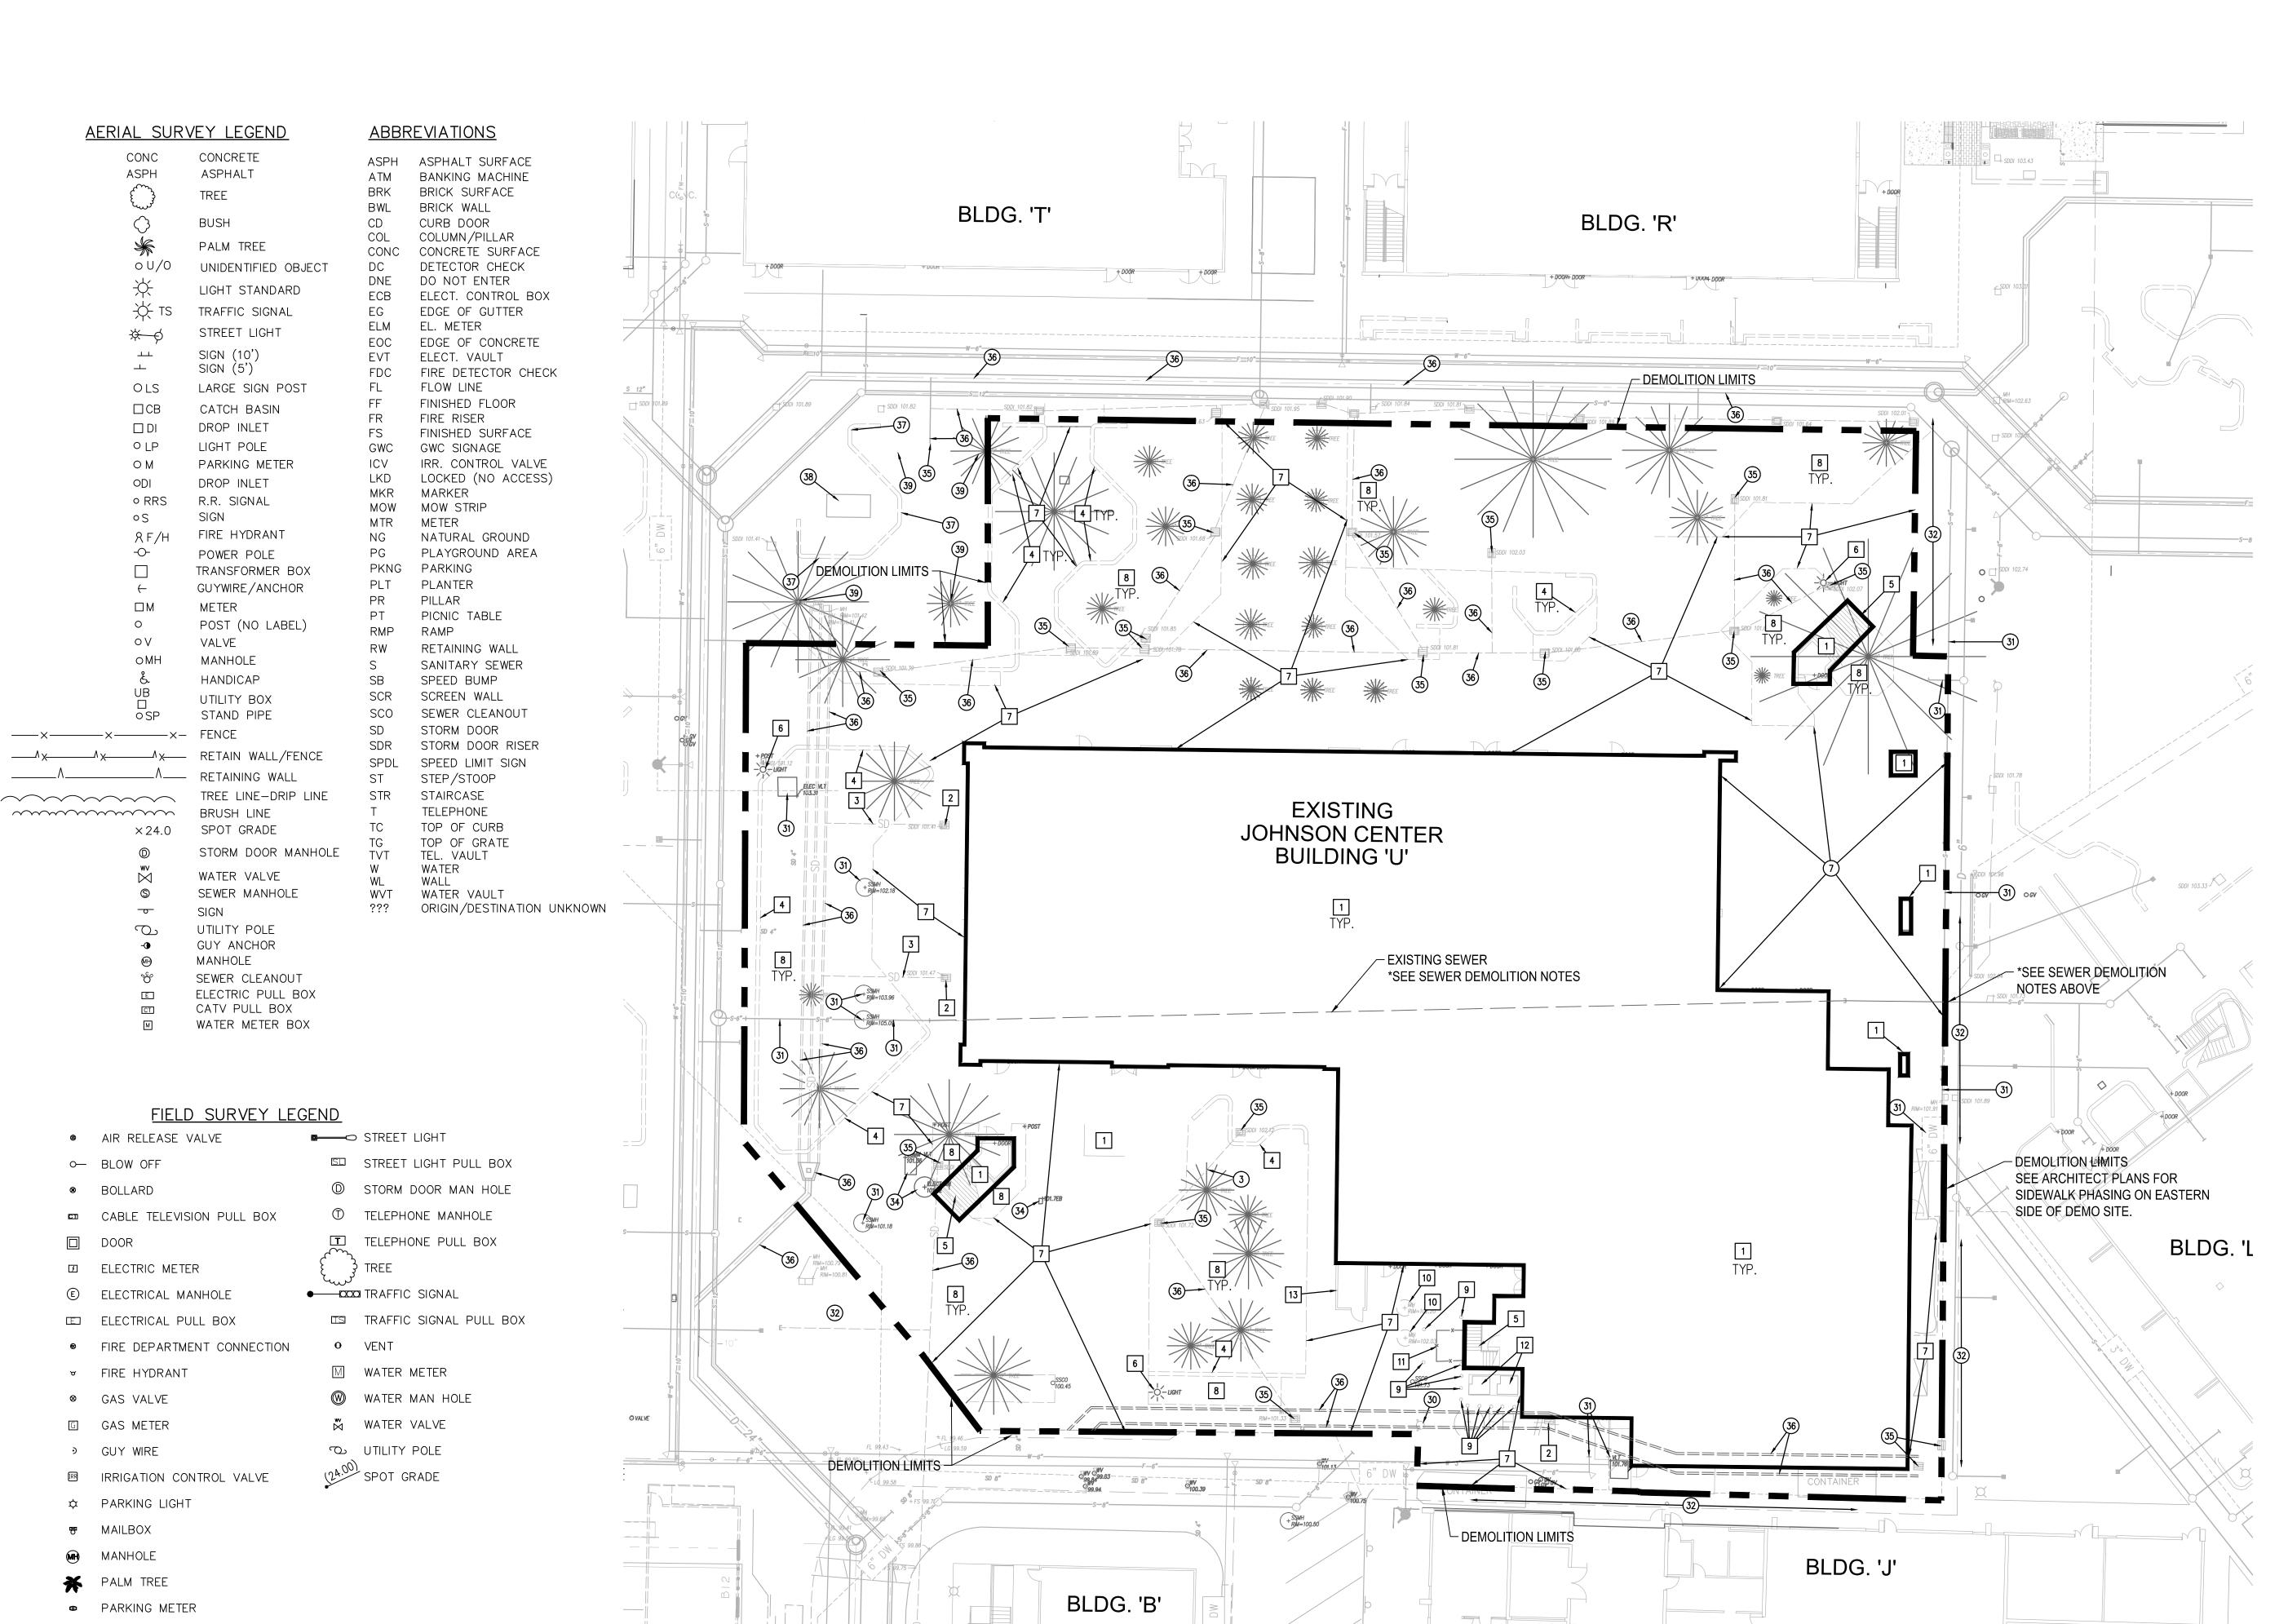
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EXISTING SITE AND DEMOLITION PLAN

SHEET NUMBER

C1.00

CONSTRUCTION DOCUMENTS




GRADING NOTES:

- EXISTING CONCRETE, BASE ROCK, AND REBAR TO BE REMOVED. SEPARATE DEMOLISHED MATERIAL PER LEED GREEN BUILDING RATING SYSTEM WASTE MANAGEMENT. BASE ROCK UNDER CONCRETE CAN BE REUSED AS GENERAL FILL IF APPROVED BY SOILS ENGINEER. ALL EDGES TO BE SAWCUT WITH A CLEAN EDGE, OR JOINT TO JOINT, PANEL TO PANEL. FOR BID PURPOSES, CONTRACTOR SHALL ASSUME 4" OF CONCRETE OVER 6" OF BASE CONCRETE AT HARDSCAPE.SIDEWALK.
- ALL WORK SHALL BE IN ACCORDANCE WITH THE 2013 CBC AND THE CITY OF CERRITOS GRADING ORDINANCE AND ANY SPECIAL REQUIREMENTS.
- CUT SLOPES SHALL BE NO LONGER THAN 2 HORIZONTAL TO 1 VERTICAL.
- 4. FILLS SHALL BE COMPACTED THROUGHOUT TO A MINIMUM RELATIVE COMPACTION OF 90%. TESTING SHALL BE IN ACCORDANCE WITH ASTM TEST METHODS D1556, D2937, D2922, AND D3017.
- 5. AREAS TO RECEIVE FILL SHALL BE PROPERLY PREPARED AND COMPACTED TO 90% RELATIVE DENSITY.
- ANY EXISTING IRRIGATION LINES SHALL BE REMOVED OR CAPPED AT LIMITS OF DEMOLITION AND BACKFILLED PER DIRECTION OF THE OWNER'S REPRESENTATIVE
- ALL TRENCH BACKFILLS SHALL BE TESTED AND CERTIFIED BY THE SITE GEOTECHNICAL ENGINEER PER THE GRADING CODE.
- 8. THE GEOTECHNICAL ENGINEER AND ENGINEERING GEOLOGIST SHALL PERFORM SUFFICIENT TESTS AND INSPECTIONS AND BE AVAILABLE DURING GRADING AND CONSTRUCTION TO VERIFY COMPLIANCE WITH THE PLANS, POLITICIZATIONS, AND CODE WITHIN THEIR PURVIEW. ENGINEERED FILL SHALL BE TESTED FOR STRUCTURAL CAPACITY.
- THE PERMITTEE SHALL COMPLY WITH THE GRADING CODE REQUIREMENTS WHEN AN EXCESS OF 5,000 CUBIC YARDS OF EARTH IS MOVED ON PUBLIC ROADWAYS FROM THE SITE OF EARTH GRADING OPERATION.


GENERAL NOTES:

- 1. PROTECT ALL SEWER, WATER, GAS, ELECTRIC AND STORM DRAIN LINES, VALVES, VAULTS, CLEAN OUTS, MANHOLES, ETC. UNLESS OTHERWISE NOTED.
- 2. PROTECT ALL ITEMS OUTSIDE OF DEMOLITION AREA DURING JOHNSON CENTER BUILDING DEMOLITION AND CONSTRUCTION ADJUST VALVES, CLEANOUTS, AND MANHOLES AS REQUIRED
- 4. REMOVE INTERFERING SECTIONS OF LANDSCAPING AS REQUIRED.
- REFER TO MEP FOR DEMOLITION AND PROTECTION OF EXISTING GAS, ELECTRIC, AND TELEPHONE UTILITIES.
- AFTER COMPLETION OF DEMOLITION AND CLEARING, LAY 2" THICK CRUSHED AGGREGATE BASE 'C.A.B.' OVER ENTIRE DEMOLITION AREA. AGGREGATE SIZE BETWEEN 3/4"-1" GRAVEL.
- GRADING OF CLEARED SITE TO BE DETERMINED DURING FINAL SITE IMPORT AFTER LEVELING AND COMPACTION OF ANY EXCAVATIONS. DEMOLITION AREA PERIMETER TO BE GRADED TO JOIN AND MATCH EXISTING ELEVATIONS. REFER TO SHEET C2.00 FOR FINAL GRADING.
- 8. REFER TO ATTACHED AS-BUILT DRAWINGS FOR FURTHER INFORMATION ON BUILDING FOUNDATION REINFORCEMENTS, PILES, AND FOOTING DEPTHS - REFERENCE ONLY.

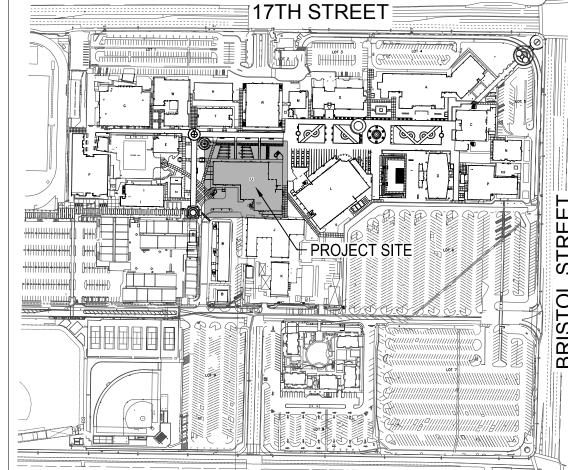

EXISTING SITE AND DEMOLITION PLAN

KEYMAP

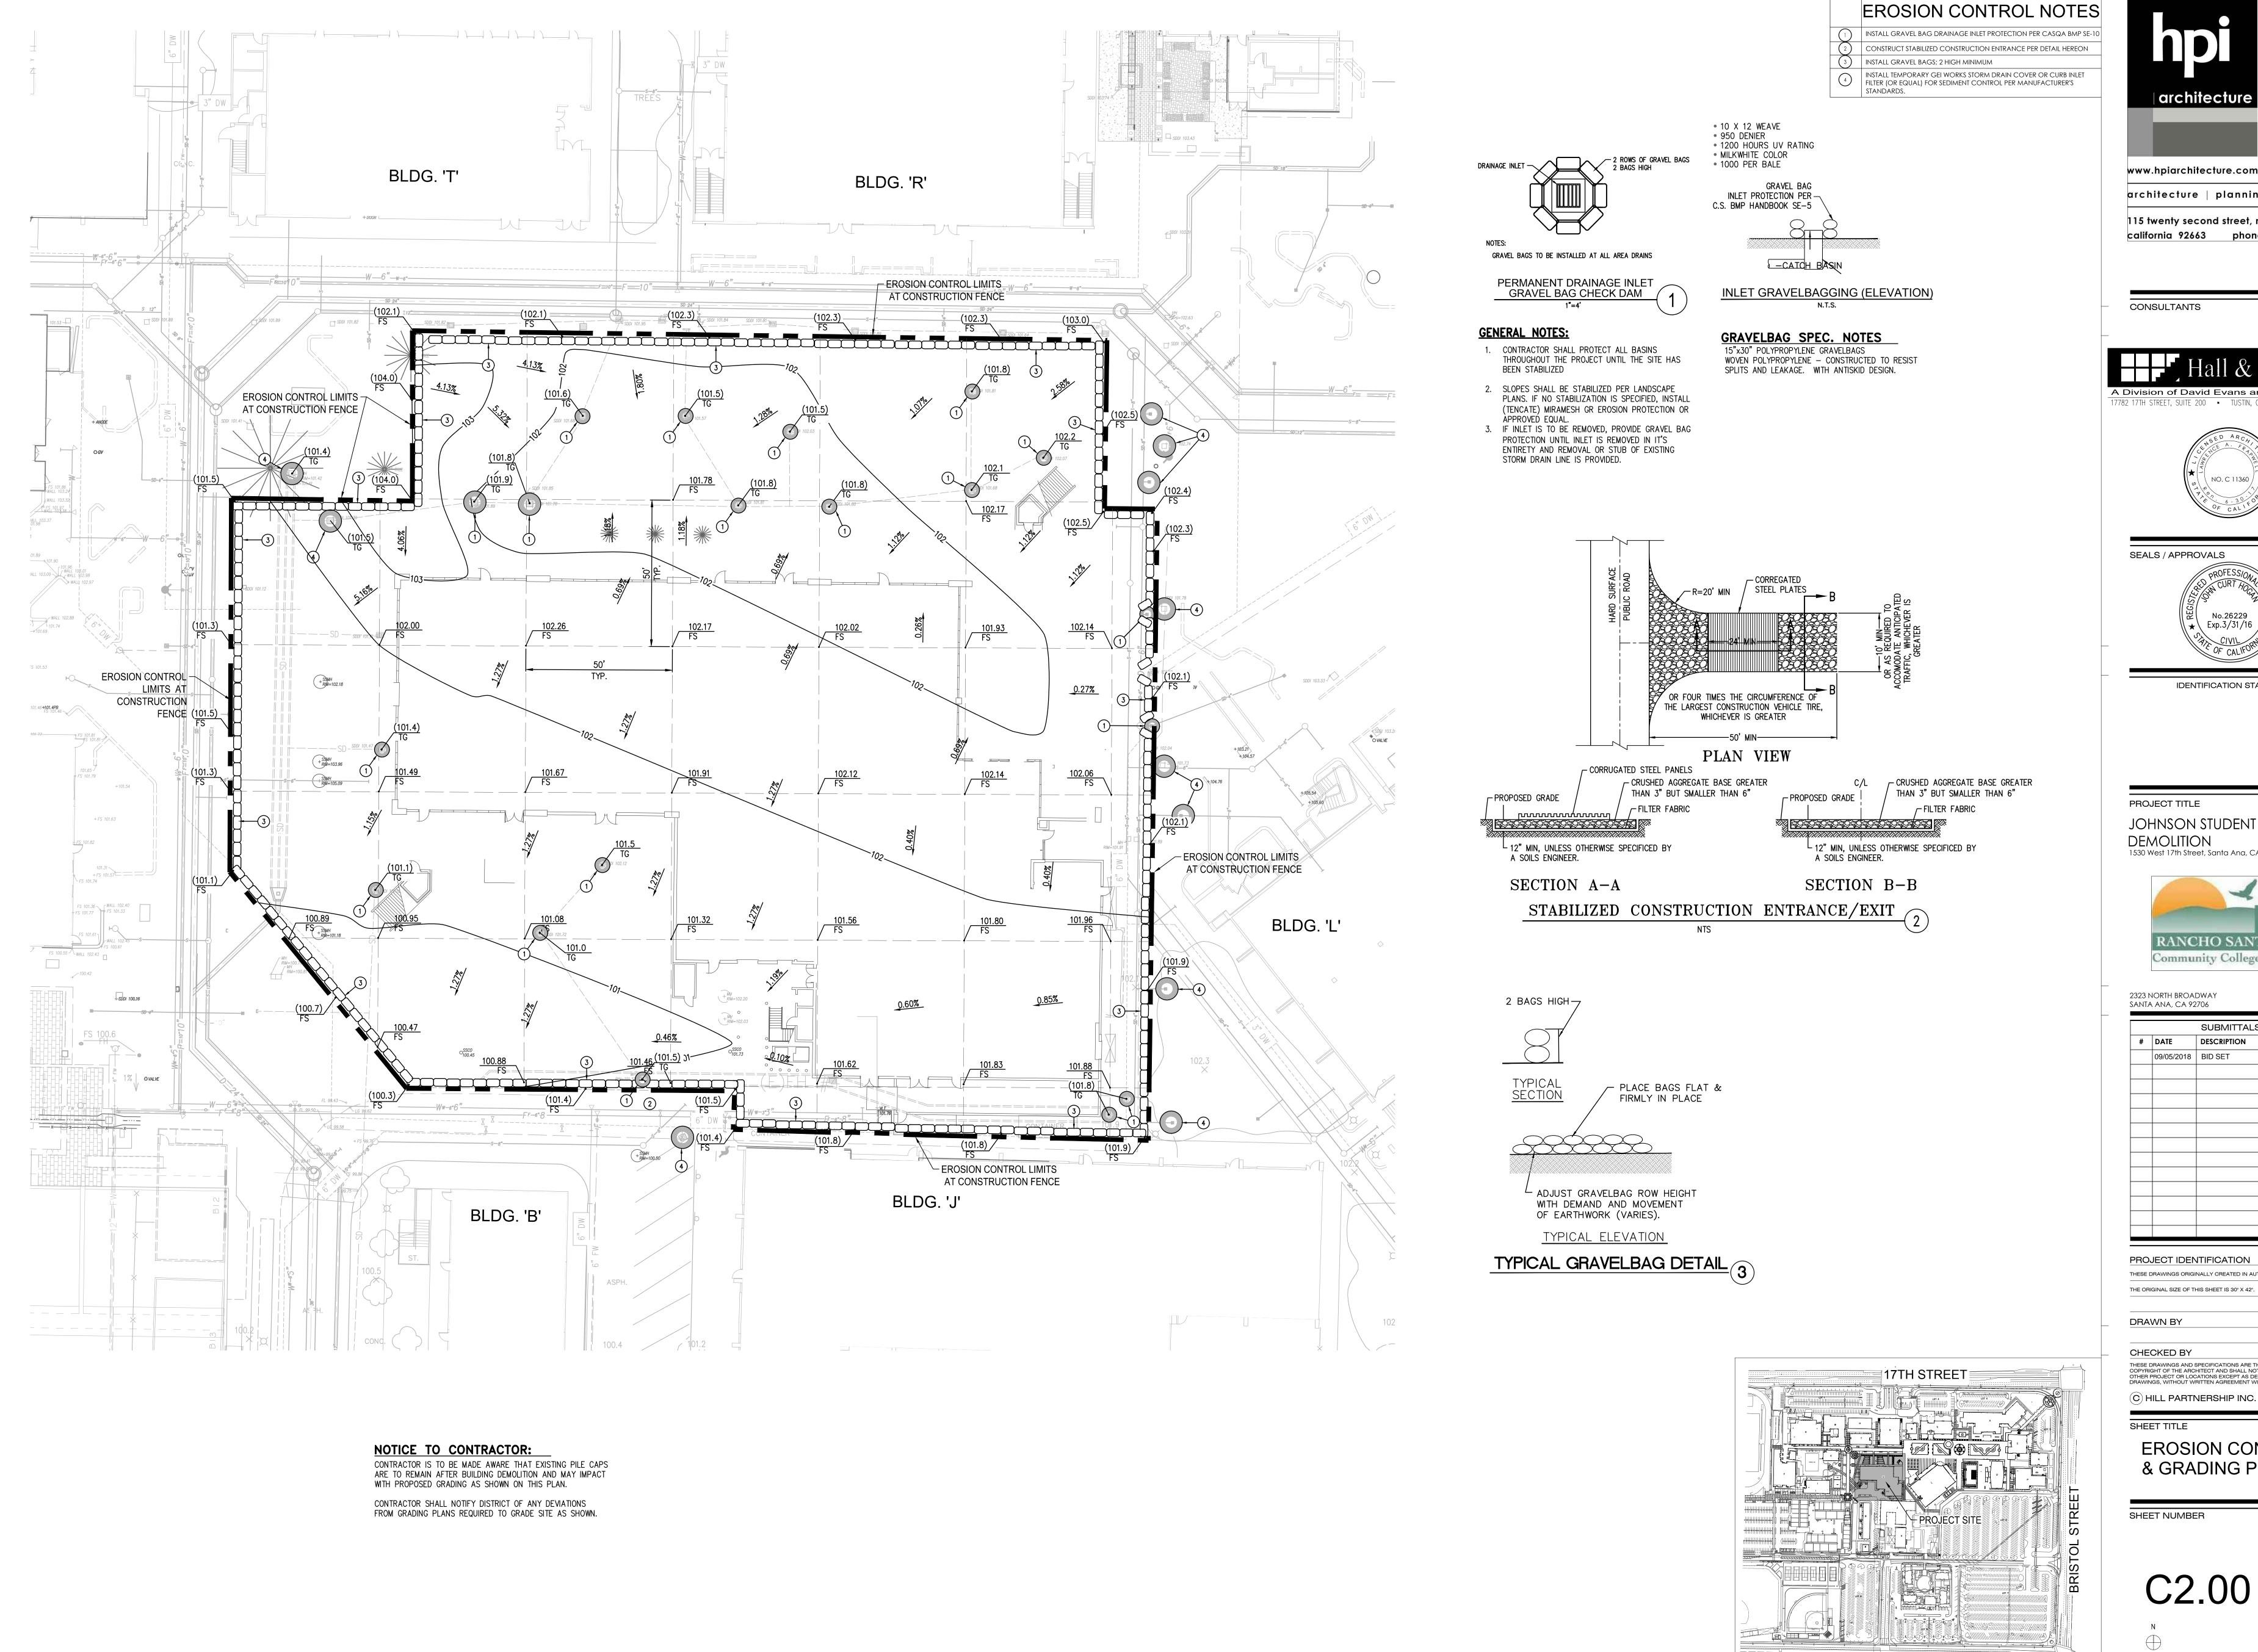

architecture

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SEALS / APPROVALS

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SHEET TITLE

EROSION CONTROL & GRADING PLAN

SHEET NUMBER


C2.00

CONSTRUCTION DOCUMENTS

SCALE 1'' = 20'-0''

EROSION CONTROL PLAN

KEYMAP

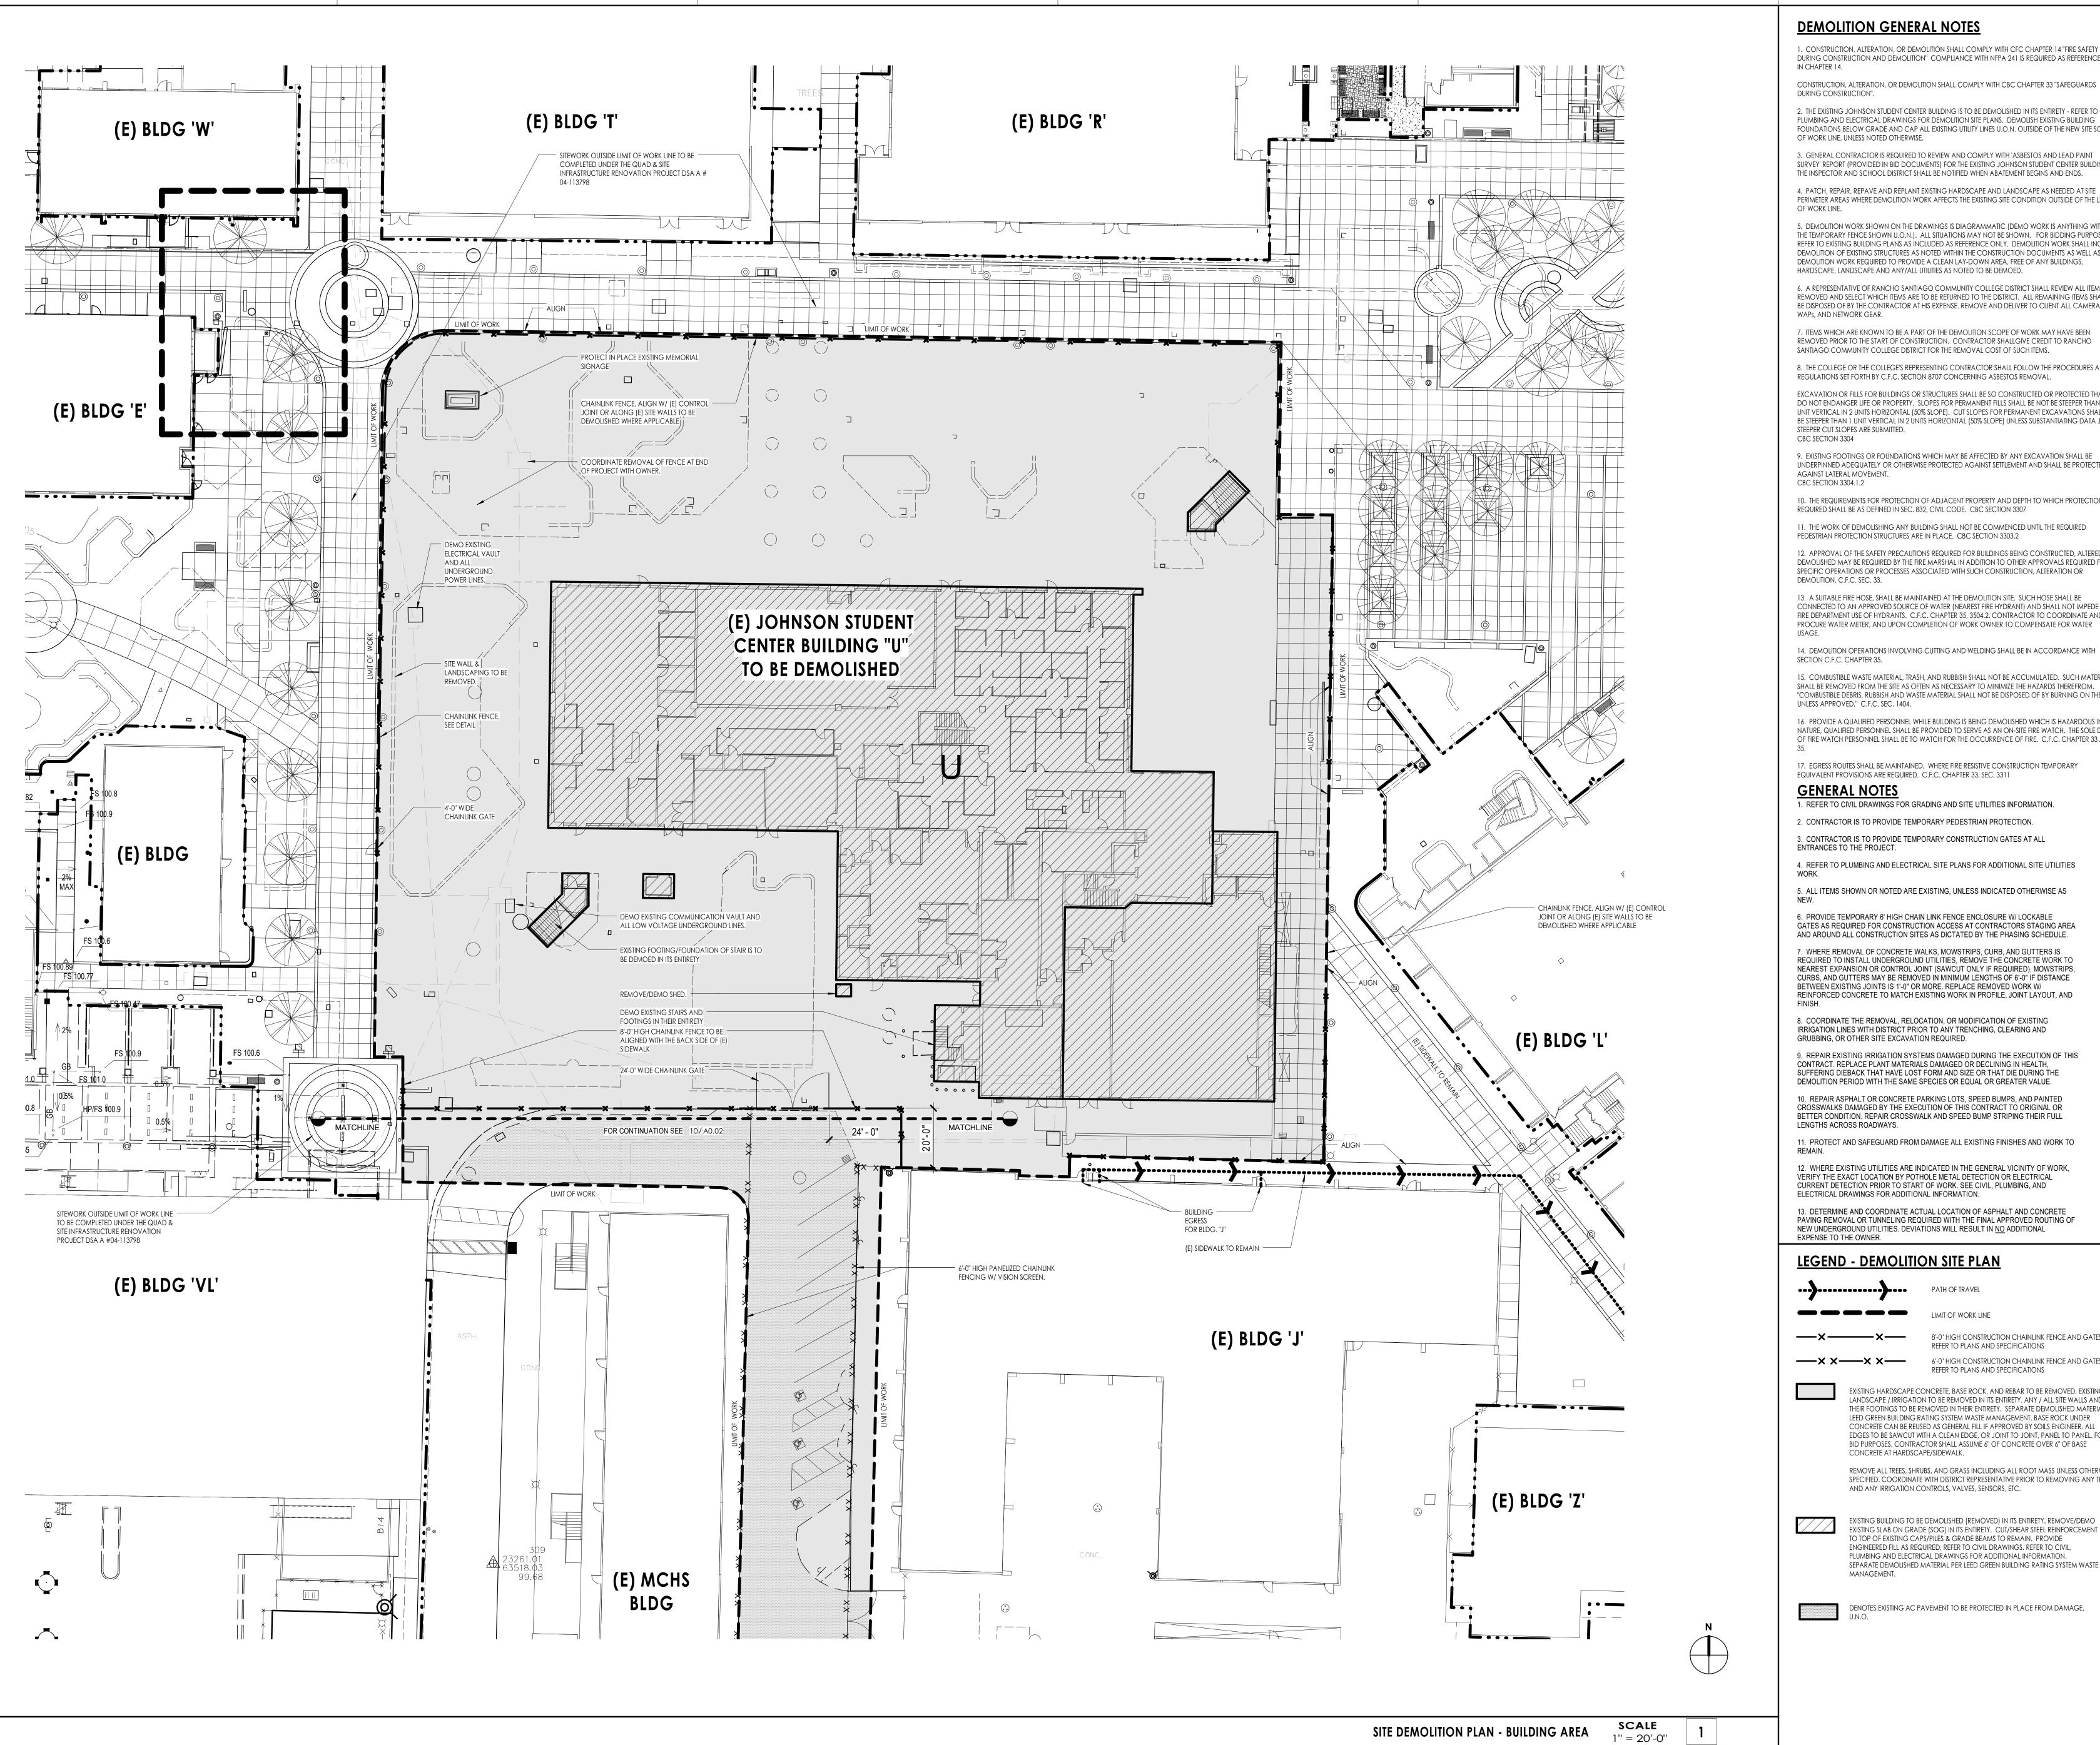

DEMOLITION GENERAL NOTES

1. CONSTRUCTION, ALTERATION, OR DEMOLITION SHALL COMPLY WITH CFC CHAPTER 14 "FIRE SAFETY DURING CONSTRUCTION AND DEMOLITION" COMPLIANCE WITH NFPA 241 IS REQUIRED AS REFERENCED

CONSTRUCTION, ALTERATION, OR DEMOLITION SHALL COMPLY WITH CBC CHAPTER 33 "SAFEGUARDS

2. THE EXISTING JOHNSON STUDENT CENTER BUILDING IS TO BE DEMOLISHED IN ITS ENTIRETY - REFER TO CIVIL, PLUMBING AND ELECTRICAL DRAWINGS FOR DEMOLITION SITE PLANS. DEMOLISH EXISTING BUILDING

FOUNDATIONS BELOW GRADE AND CAP ALL EXISTING UTILITY LINES U.O.N. OUTSIDE OF THE NEW SITE SCOPE OF WORK LINE, UNLESS NOTED OTHERWISE.

3. GENERAL CONTRACTOR IS REQUIRED TO REVIEW AND COMPLY WITH 'ASBESTOS AND LEAD PAINT SURVEY' REPORT (PROVIDED IN BID DOCUMENTS) FOR THE EXISTING JOHNSON STUDENT CENTER BUILDING. THE INSPECTOR AND SCHOOL DISTRICT SHALL BE NOTIFIED WHEN ABATEMENT BEGINS AND ENDS.

4. PATCH, REPAIR, REPAVE AND REPLANT EXISTING HARDSCAPE AND LANDSCAPE AS NEEDED AT SITE PERIMETER AREAS WHERE DEMOLITION WORK AFFECTS THE EXISTING SITE CONDITION OUTSIDE OF THE LIMIT

5. DEMOLITION WORK SHOWN ON THE DRAWINGS IS DIAGRAMMATIC (DEMO WORK IS ANYTHING WITHIN THE TEMPORARY FENCE SHOWN U.O.N.). ALL SITUATIONS MAY NOT BE SHOWN. FOR BIDDING PURPOSES REFER TO EXISTING BUILDING PLANS AS INCLUDED AS REFERENCE ONLY. DEMOLITION WORK SHALL INCLUDE DEMOLITION OF EXISTING STRUCTURES AS NOTED WITHIN THE CONSTRUCTION DOCUMENTS AS WELL AS THE DEMOLITION WORK REQUIRED TO PROVIDE A CLEAN LAY-DOWN AREA, FREE OF ANY BUILDINGS, HARDSCAPE, LANDSCAPE AND ANY/ALL UTILITIES AS NOTED TO BE DEMOED.

6. A REPRESENTATIVE OF RANCHO SANTIAGO COMMUNITY COLLEGE DISTRICT SHALL REVIEW ALL ITEMS REMOVED AND SELECT WHICH ITEMS ARE TO BE RETURNED TO THE DISTRICT. ALL REMAINING ITEMS SHALL BE DISPOSED OF BY THE CONTRACTOR AT HIS EXPENSE. REMOVE AND DELIVER TO CLIENT ALL CAMERAS, WAPS, AND NETWORK GEAR.

7. ITEMS WHICH ARE KNOWN TO BE A PART OF THE DEMOLITION SCOPE OF WORK MAY HAVE BEEN

SANTIAGO COMMUNITY COLLEGE DISTRICT FOR THE REMOVAL COST OF SUCH ITEMS. 8. THE COLLEGE OR THE COLLEGE'S REPRESENTING CONTRACTOR SHALL FOLLOW THE PROCEDURES AND

EXCAVATION OR FILLS FOR BUILDINGS OR STRUCTURES SHALL BE SO CONSTRUCTED OR PROTECTED THAT THEY DO NOT ENDANGER LIFE OR PROPERTY. SLOPES FOR PERMANENT FILLS SHALL BE NOT BE STEEPER THAN 1 UNIT VERTICAL IN 2 UNITS HORIZONTAL (50% SLOPE). CUT SLOPES FOR PERMANENT EXCAVATIONS SHALL NOT BE STEEPER THAN 1 UNIT VERTICAL IN 2 UNITS HORIZONTAL (50% SLOPE) UNLESS SUBSTANTIATING DATA JUSTIFY STEEPER CUT SLOPES ARE SUBMITTED.

9. EXISTING FOOTINGS OR FOUNDATIONS WHICH MAY BE AFFECTED BY ANY EXCAVATION SHALL BE UNDERPINNED ADEQUATELY OR OTHERWISE PROTECTED AGAINST SETTLEMENT AND SHALL BE PROTECTED AGAINST LATERAL MOVEMENT.

10. THE REQUIREMENTS FOR PROTECTION OF ADJACENT PROPERTY AND DEPTH TO WHICH PROTECTION IS REQUIRED SHALL BE AS DEFINED IN SEC. 832, CIVIL CODE. CBC SECTION 3307 11. THE WORK OF DEMOLISHING ANY BUILDING SHALL NOT BE COMMENCED UNTIL THE REQUIRED

12. APPROVAL OF THE SAFETY PRECAUTIONS REQUIRED FOR BUILDINGS BEING CONSTRUCTED, ALTERED OR DEMOLISHED MAY BE REQUIRED BY THE FIRE MARSHAL IN ADDITION TO OTHER APPROVALS REQUIRED FOR SPECIFIC OPERATIONS OR PROCESSES ASSOCIATED WITH SUCH CONSTRUCTION, ALTERATION OR DEMOLITION. C.F.C. SEC. 33.

13. A SUITABLE FIRE HOSE, SHALL BE MAINTAINED AT THE DEMOLITION SITE. SUCH HOSE SHALL BE CONNECTED TO AN APPROVED SOURCE OF WATER (NEAREST FIRE HYDRANT) AND SHALL NOT IMPEDE FIRE DEPARTMENT USE OF HYDRANTS. C.F.C. CHAPTER 35, 3504.2. CONTRACTOR TO COORDINATE AND PROCURE WATER METER, AND UPON COMPLETION OF WORK OWNER TO COMPENSATE FOR WATER

14. DEMOLITION OPERATIONS INVOLVING CUTTING AND WELDING SHALL BE IN ACCORDANCE WITH SECTION C.F.C. CHAPTER 35.

15. COMBUSTIBLE WASTE MATERIAL, TRASH, AND RUBBISH SHALL NOT BE ACCUMULATED. SUCH MATERIAL SHALL BE REMOVED FROM THE SITE AS OFTEN AS NECESSARY TO MINIMIZE THE HAZARDS THEREFROM. "COMBUSTIBLE DEBRIS, RUBBISH AND WASTE MATERIAL SHALL NOT BE DISPOSED OF BY BURNING ON THE SITE UNLESS APPROVED." C.F.C. SEC. 1404.

16. PROVIDE A QUALIFIED PERSONNEL WHILE BUILDING IS BEING DEMOLISHED WHICH IS HAZARDOUS IN NATURE, QUALIFIED PERSONNEL SHALL BE PROVIDED TO SERVE AS AN ON-SITE FIRE WATCH. THE SOLE DUTY OF FIRE WATCH PERSONNEL SHALL BE TO WATCH FOR THE OCCURRENCE OF FIRE. C.F.C. CHAPTER 33 AND

17. EGRESS ROUTES SHALL BE MAINTAINED. WHERE FIRE RESISTIVE CONSTRUCTION TEMPORARY EQUIVALENT PROVISIONS ARE REQUIRED. C.F.C. CHAPTER 33, SEC. 3311

1. REFER TO CIVIL DRAWINGS FOR GRADING AND SITE UTILITIES INFORMATION.

2. CONTRACTOR IS TO PROVIDE TEMPORARY PEDESTRIAN PROTECTION. 3. CONTRACTOR IS TO PROVIDE TEMPORARY CONSTRUCTION GATES AT ALL

4. REFER TO PLUMBING AND ELECTRICAL SITE PLANS FOR ADDITIONAL SITE UTILITIES

5. ALL ITEMS SHOWN OR NOTED ARE EXISTING, UNLESS INDICATED OTHERWISE AS

6. PROVIDE TEMPORARY 6' HIGH CHAIN LINK FENCE ENCLOSURE W/ LOCKABLE GATES AS REQUIRED FOR CONSTRUCTION ACCESS AT CONTRACTORS STAGING AREA AND AROUND ALL CONSTRUCTION SITES AS DICTATED BY THE PHASING SCHEDULE. 7. WHERE REMOVAL OF CONCRETE WALKS, MOWSTRIPS, CURB, AND GUTTERS IS REQUIRED TO INSTALL UNDERGROUND UTILITIES, REMOVE THE CONCRETE WORK TO NEAREST EXPANSION OR CONTROL JOINT (SAWCUT ONLY IF REQUIRED). MOWSTRIPS, CURBS, AND GUTTERS MAY BE REMOVED IN MINIMUM LENGTHS OF 6'-0" IF DISTANCE BETWEEN EXISTING JOINTS IS 1'-0" OR MORE. REPLACE REMOVED WORK W/

8. COORDINATE THE REMOVAL, RELOCATION, OR MODIFICATION OF EXISTING IRRIGATION LINES WITH DISTRICT PRIOR TO ANY TRENCHING, CLEARING AND

9. REPAIR EXISTING IRRIGATION SYSTEMS DAMAGED DURING THE EXECUTION OF THIS CONTRACT. REPLACE PLANT MATERIALS DAMAGED OR DECLINING IN HEALTH, SUFFERING DIEBACK THAT HAVE LOST FORM AND SIZE OR THAT DIE DURING THE DEMOLITION PERIOD WITH THE SAME SPECIES OR EQUAL OR GREATER VALUE.

10. REPAIR ASPHALT OR CONCRETE PARKING LOTS, SPEED BUMPS, AND PAINTED CROSSWALKS DAMAGED BY THE EXECUTION OF THIS CONTRACT TO ORIGINAL OR BETTER CONDITION. REPAIR CROSSWALK AND SPEED BUMP STRIPING THEIR FULL

11. PROTECT AND SAFEGUARD FROM DAMAGE ALL EXISTING FINISHES AND WORK TO

12. WHERE EXISTING UTILITIES ARE INDICATED IN THE GENERAL VICINITY OF WORK, VERIFY THE EXACT LOCATION BY POTHOLE METAL DETECTION OR ELECTRICAL CURRENT DETECTION PRIOR TO START OF WORK. SEE CIVIL, PLUMBING, AND ELECTRICAL DRAWINGS FOR ADDITIONAL INFORMATION.

13. DETERMINE AND COORDINATE ACTUAL LOCATION OF ASPHALT AND CONCRETE PAVING REMOVAL OR TUNNELING REQUIRED WITH THE FINAL APPROVED ROUTING OF NEW UNDERGROUND UTILITIES. DEVIATIONS WILL RESULT IN NO ADDITIONAL


LEGEND - DEMOLITION SITE PLAN

LIMIT OF WORK LINE

8'-0" HIGH CONSTRUCTION CHAINLINK FENCE AND GATES, REFER TO PLANS AND SPECIFICATIONS 6'-0" HIGH CONSTRUCTION CHAINLINK FENCE AND GATES, REFER TO PLANS AND SPECIFICATIONS

EXISTING HARDSCAPE CONCRETE, BASE ROCK, AND REBAR TO BE REMOVED. EXISTING LANDSCAPE / IRRIGATION TO BE REMOVED IN ITS ENTIRETY. ANY / ALL SITE WALLS AND THEIR FOOTINGS TO BE REMOVED IN THEIR ENTIRETY. SEPARATE DEMOLISHED MATERIAL PER LEED GREEN BUILDING RATING SYSTEM WASTE MANAGEMENT. BASE ROCK UNDER CONCRETE CAN BE REUSED AS GENERAL FILL IF APPROVED BY SOILS ENGINEER. ALL EDGES TO BE SAWCUT WITH A CLEAN EDGE, OR JOINT TO JOINT, PANEL TO PANEL. FOR BID PURPOSES, CONTRACTOR SHALL ASSUME 6" OF CONCRETE OVER 6" OF BASE CONCRETE AT HARDSCAPE/SIDEWALK.

REMOVE ALL TREES, SHRUBS, AND GRASS INCLUDING ALL ROOT MASS UNLESS OTHERWISE SPECIFIED. COORDINATE WITH DISTRICT REPRESENTATIVE PRIOR TO REMOVING ANY TREES AND ANY IRRIGATION CONTROLS, VALVES, SENSORS, ETC.

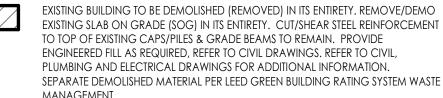

EXISTING SLAB ON GRADE (SOG) IN ITS ENTIRETY. CUT/SHEAR STEEL REINFORCEMENT TO TOP OF EXISTING CAPS/PILES & GRADE BEAMS TO REMAIN. PROVIDE ENGINEERED FILL AS REQUIRED, REFER TO CIVIL DRAWINGS, REFER TO CIVIL. PLUMBING AND ELECTRICAL DRAWINGS FOR ADDITIONAL INFORMATION. SEPARATE DEMOLISHED MATERIAL PER LEED GREEN BUILDING RATING SYSTEM WASTE

DENOTES EXISTING AC PAVEMENT TO BE PROTECTED IN PLACE FROM DAMAGE,

architecture

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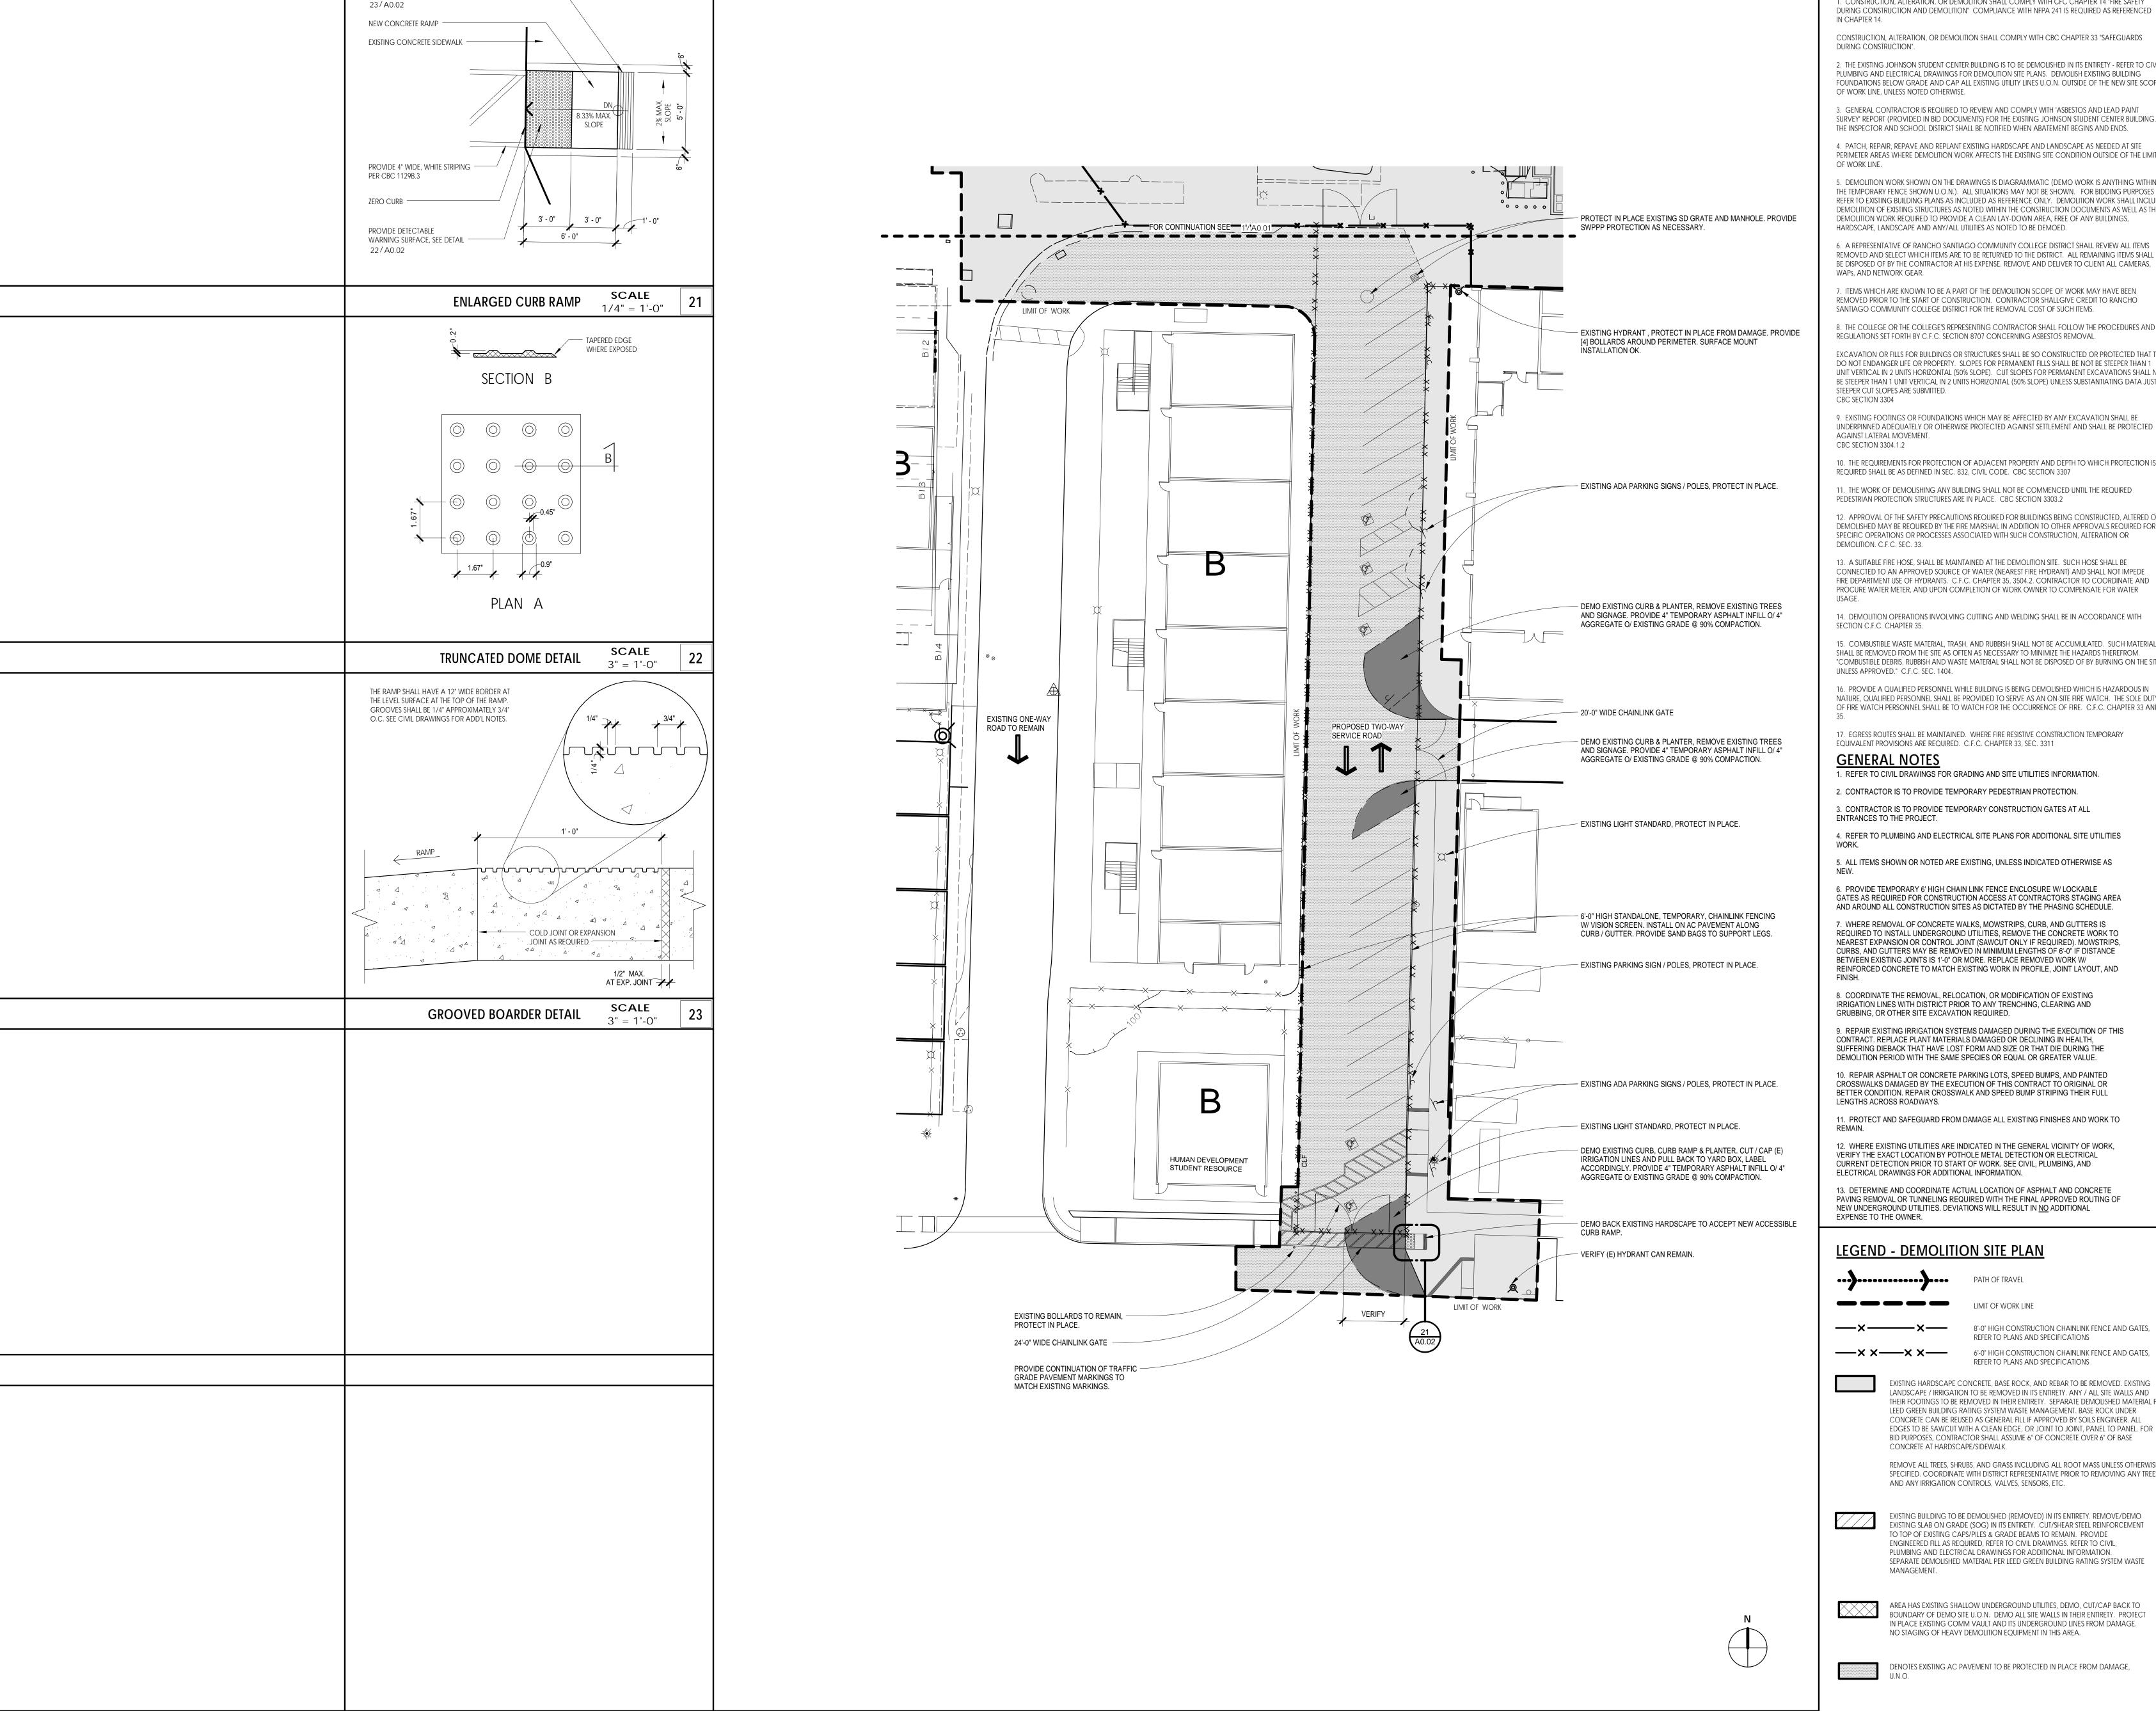
SHEET TITLE

SITE DEMOLITION PLAN - BUILDING AREA

SHEET NUMBER

A0.01

CONSTRUCTION DOCUMENTS



TOOLED WARNING GROOVES, SEE DETAIL

DEMOLITION GENERAL NOTES

1. CONSTRUCTION, ALTERATION, OR DEMOLITION SHALL COMPLY WITH CFC CHAPTER 14 "FIRE SAFETY DURING CONSTRUCTION AND DEMOLITION" COMPLIANCE WITH NFPA 241 IS REQUIRED AS REFERENCED

CONSTRUCTION, ALTERATION, OR DEMOLITION SHALL COMPLY WITH CBC CHAPTER 33 "SAFEGUARDS DURING CONSTRUCTION".

2. THE EXISTING JOHNSON STUDENT CENTER BUILDING IS TO BE DEMOLISHED IN ITS ENTIRETY - REFER TO CIVIL, PLUMBING AND ELECTRICAL DRAWINGS FOR DEMOLITION SITE PLANS. DEMOLISH EXISTING BUILDING FOUNDATIONS BELOW GRADE AND CAP ALL EXISTING UTILITY LINES U.O.N. OUTSIDE OF THE NEW SITE SCOPE OF WORK LINE, UNLESS NOTED OTHERWISE.

3. GENERAL CONTRACTOR IS REQUIRED TO REVIEW AND COMPLY WITH 'ASBESTOS AND LEAD PAINT SURVEY' REPORT (PROVIDED IN BID DOCUMENTS) FOR THE EXISTING JOHNSON STUDENT CENTER BUILDING. THE INSPECTOR AND SCHOOL DISTRICT SHALL BE NOTIFIED WHEN ABATEMENT BEGINS AND ENDS.

4. PATCH, REPAIR, REPAVE AND REPLANT EXISTING HARDSCAPE AND LANDSCAPE AS NEEDED AT SITE PERIMETER AREAS WHERE DEMOLITION WORK AFFECTS THE EXISTING SITE CONDITION OUTSIDE OF THE LIMIT

5. DEMOLITION WORK SHOWN ON THE DRAWINGS IS DIAGRAMMATIC (DEMO WORK IS ANYTHING WITHIN THE TEMPORARY FENCE SHOWN U.O.N.). ALL SITUATIONS MAY NOT BE SHOWN. FOR BIDDING PURPOSES REFER TO EXISTING BUILDING PLANS AS INCLUDED AS REFERENCE ONLY. DEMOLITION WORK SHALL INCLUDE DEMOLITION OF EXISTING STRUCTURES AS NOTED WITHIN THE CONSTRUCTION DOCUMENTS AS WELL AS THE DEMOLITION WORK REQUIRED TO PROVIDE A CLEAN LAY-DOWN AREA, FREE OF ANY BUILDINGS, HARDSCAPE, LANDSCAPE AND ANY/ALL UTILITIES AS NOTED TO BE DEMOED.

6. A REPRESENTATIVE OF RANCHO SANTIAGO COMMUNITY COLLEGE DISTRICT SHALL REVIEW ALL ITEMS REMOVED AND SELECT WHICH ITEMS ARE TO BE RETURNED TO THE DISTRICT. ALL REMAINING ITEMS SHALL BE DISPOSED OF BY THE CONTRACTOR AT HIS EXPENSE. REMOVE AND DELIVER TO CLIENT ALL CAMERAS, Waps, and Network Gear.

7. ITEMS WHICH ARE KNOWN TO BE A PART OF THE DEMOLITION SCOPE OF WORK MAY HAVE BEEN REMOVED PRIOR TO THE START OF CONSTRUCTION. CONTRACTOR SHALLGIVE CREDIT TO RANCHO

8. THE COLLEGE OR THE COLLEGE'S REPRESENTING CONTRACTOR SHALL FOLLOW THE PROCEDURES AND REGULATIONS SET FORTH BY C.F.C. SECTION 8707 CONCERNING ASBESTOS REMOVAL.

EXCAVATION OR FILLS FOR BUILDINGS OR STRUCTURES SHALL BE SO CONSTRUCTED OR PROTECTED THAT THEY DO NOT ENDANGER LIFE OR PROPERTY. SLOPES FOR PERMANENT FILLS SHALL BE NOT BE STEEPER THAN 1 UNIT VERTICAL IN 2 UNITS HORIZONTAL (50% SLOPE). CUT SLOPES FOR PERMANENT EXCAVATIONS SHALL NOT BE STEEPER THAN 1 UNIT VERTICAL IN 2 UNITS HORIZONTAL (50% SLOPE) UNLESS SUBSTANTIATING DATA JUSTIFY STEEPER CUT SLOPES ARE SUBMITTED.

9. EXISTING FOOTINGS OR FOUNDATIONS WHICH MAY BE AFFECTED BY ANY EXCAVATION SHALL BE UNDERPINNED ADEQUATELY OR OTHERWISE PROTECTED AGAINST SETTLEMENT AND SHALL BE PROTECTED AGAINST LATERAL MOVEMENT.

10. THE REQUIREMENTS FOR PROTECTION OF ADJACENT PROPERTY AND DEPTH TO WHICH PROTECTION IS REQUIRED SHALL BE AS DEFINED IN SEC. 832, CIVIL CODE. CBC SECTION 3307

11. THE WORK OF DEMOLISHING ANY BUILDING SHALL NOT BE COMMENCED UNTIL THE REQUIRED PEDESTRIAN PROTECTION STRUCTURES ARE IN PLACE. CBC SECTION 3303.2

12. APPROVAL OF THE SAFETY PRECAUTIONS REQUIRED FOR BUILDINGS BEING CONSTRUCTED, ALTERED OR DEMOLISHED MAY BE REQUIRED BY THE FIRE MARSHAL IN ADDITION TO OTHER APPROVALS REQUIRED FOR SPECIFIC OPERATIONS OR PROCESSES ASSOCIATED WITH SUCH CONSTRUCTION, ALTERATION OR DEMOLITION. C.F.C. SEC. 33. 13. A SUITABLE FIRE HOSE, SHALL BE MAINTAINED AT THE DEMOLITION SITE. SUCH HOSE SHALL BE

14. DEMOLITION OPERATIONS INVOLVING CUTTING AND WELDING SHALL BE IN ACCORDANCE WITH

15. COMBUSTIBLE WASTE MATERIAL, TRASH, AND RUBBISH SHALL NOT BE ACCUMULATED. SUCH MATERIAL SHALL BE REMOVED FROM THE SITE AS OFTEN AS NECESSARY TO MINIMIZE THE HAZARDS THEREFROM. "COMBUSTIBLE DEBRIS, RUBBISH AND WASTE MATERIAL SHALL NOT BE DISPOSED OF BY BURNING ON THE SITE

16. PROVIDE A QUALIFIED PERSONNEL WHILE BUILDING IS BEING DEMOLISHED WHICH IS HAZARDOUS IN NATURE. QUALIFIED PERSONNEL SHALL BE PROVIDED TO SERVE AS AN ON-SITE FIRE WATCH. THE SOLE DUI OF FIRE WATCH PERSONNEL SHALL BE TO WATCH FOR THE OCCURRENCE OF FIRE. C.F.C. CHAPTER 33 AND

17. EGRESS ROUTES SHALL BE MAINTAINED. WHERE FIRE RESISTIVE CONSTRUCTION TEMPORARY EQUIVALENT PROVISIONS ARE REQUIRED. C.F.C. CHAPTER 33, SEC. 3311

1. REFER TO CIVIL DRAWINGS FOR GRADING AND SITE UTILITIES INFORMATION. 2. CONTRACTOR IS TO PROVIDE TEMPORARY PEDESTRIAN PROTECTION.

3. CONTRACTOR IS TO PROVIDE TEMPORARY CONSTRUCTION GATES AT ALL ENTRANCES TO THE PROJECT.

4. REFER TO PLUMBING AND ELECTRICAL SITE PLANS FOR ADDITIONAL SITE UTILITIES

5. ALL ITEMS SHOWN OR NOTED ARE EXISTING, UNLESS INDICATED OTHERWISE AS

6. PROVIDE TEMPORARY 6' HIGH CHAIN LINK FENCE ENCLOSURE W/ LOCKABLE GATES AS REQUIRED FOR CONSTRUCTION ACCESS AT CONTRACTORS STAGING AREA AND AROUND ALL CONSTRUCTION SITES AS DICTATED BY THE PHASING SCHEDULE.

7. WHERE REMOVAL OF CONCRETE WALKS, MOWSTRIPS, CURB, AND GUTTERS IS REQUIRED TO INSTALL UNDERGROUND UTILITIES, REMOVE THE CONCRETE WORK TO NEAREST EXPANSION OR CONTROL JOINT (SAWCUT ONLY IF REQUIRED). MOWSTRIPS, CURBS, AND GUTTERS MAY BE REMOVED IN MINIMUM LENGTHS OF 6'-0" IF DISTANCE BETWEEN EXISTING JOINTS IS 1'-0" OR MORE. REPLACE REMOVED WORK W/ REINFORCED CONCRETE TO MATCH EXISTING WORK IN PROFILE, JOINT LAYOUT, AND

8. COORDINATE THE REMOVAL, RELOCATION, OR MODIFICATION OF EXISTING IRRIGATION LINES WITH DISTRICT PRIOR TO ANY TRENCHING, CLEARING AND GRUBBING, OR OTHER SITE EXCAVATION REQUIRED.

9. REPAIR EXISTING IRRIGATION SYSTEMS DAMAGED DURING THE EXECUTION OF THIS CONTRACT. REPLACE PLANT MATERIALS DAMAGED OR DECLINING IN HEALTH, SUFFERING DIEBACK THAT HAVE LOST FORM AND SIZE OR THAT DIE DURING THE DEMOLITION PERIOD WITH THE SAME SPECIES OR EQUAL OR GREATER VALUE.

10. REPAIR ASPHALT OR CONCRETE PARKING LOTS, SPEED BUMPS, AND PAINTED CROSSWALKS DAMAGED BY THE EXECUTION OF THIS CONTRACT TO ORIGINAL OR BETTER CONDITION. REPAIR CROSSWALK AND SPEED BUMP STRIPING THEIR FULL LENGTHS ACROSS ROADWAYS.

11. PROTECT AND SAFEGUARD FROM DAMAGE ALL EXISTING FINISHES AND WORK TO

12. WHERE EXISTING UTILITIES ARE INDICATED IN THE GENERAL VICINITY OF WORK, VERIFY THE EXACT LOCATION BY POTHOLE METAL DETECTION OR ELECTRICAL CURRENT DETECTION PRIOR TO START OF WORK. SEE CIVIL, PLUMBING, AND ELECTRICAL DRAWINGS FOR ADDITIONAL INFORMATION.

13. DETERMINE AND COORDINATE ACTUAL LOCATION OF ASPHALT AND CONCRETE PAVING REMOVAL OR TUNNELING REQUIRED WITH THE FINAL APPROVED ROUTING OF NEW UNDERGROUND UTILITIES. DEVIATIONS WILL RESULT IN <u>NO</u> ADDITIONAL EXPENSE TO THE OWNER.

LEGEND - DEMOLITION SITE PLAN

—××—××—

PATH OF TRAVEL LIMIT OF WORK LINE

REFER TO PLANS AND SPECIFICATIONS 6'-0" HIGH CONSTRUCTION CHAINLINK FENCE AND GATES, REFER TO PLANS AND SPECIFICATIONS EXISTING HARDSCAPE CONCRETE, BASE ROCK, AND REBAR TO BE REMOVED. EXISTING

8'-0" HIGH CONSTRUCTION CHAINLINK FENCE AND GATES,

LANDSCAPE / IRRIGATION TO BE REMOVED IN ITS ENTIRETY. ANY / ALL SITE WALLS AND THEIR FOOTINGS TO BE REMOVED IN THEIR ENTIRETY. SEPARATE DEMOLISHED MATERIAL PER LEED GREEN BUILDING RATING SYSTEM WASTE MANAGEMENT. BASE ROCK UNDER CONCRETE CAN BE REUSED AS GENERAL FILL IF APPROVED BY SOILS ENGINEER. ALL EDGES TO BE SAWCUT WITH A CLEAN EDGE, OR JOINT TO JOINT, PANEL TO PANEL. FOR BID PURPOSES, CONTRACTOR SHALL ASSUME 6" OF CONCRETE OVER 6" OF BASE CONCRETE AT HARDSCAPE/SIDEWALK.

SPECIFIED. COORDINATE WITH DISTRICT REPRESENTATIVE PRIOR TO REMOVING ANY TREES AND ANY IRRIGATION CONTROLS, VALVES, SENSORS, ETC.

EXISTING BUILDING TO BE DEMOLISHED (REMOVED) IN ITS ENTIRETY. REMOVE/DEMO EXISTING SLAB ON GRADE (SOG) IN ITS ENTIRETY. CUT/SHEAR STEEL REINFORCEMENT TO TOP OF EXISTING CAPS/PILES & GRADE BEAMS TO REMAIN. PROVIDE ENGINEERED FILL AS REQUIRED, REFER TO CIVIL DRAWINGS. REFER TO CIVIL, PLUMBING AND ELECTRICAL DRAWINGS FOR ADDITIONAL INFORMATION. SEPARATE DEMOLISHED MATERIAL PER LEED GREEN BUILDING RATING SYSTEM WASTE

1" = 20'-0"

SITE DEMOLITION PLAN - SERVICE ROAD

AREA HAS EXISTING SHALLOW UNDERGROUND UTILITIES, DEMO, CUT/CAP BACK TO BOUNDARY OF DEMO SITE U.O.N. DEMO ALL SITE WALLS IN THEIR ENTIRETY. PROTECT IN PLACE EXISTING COMM VAULT AND ITS UNDERGROUND LINES FROM DAMAGE. NO STAGING OF HEAVY DEMOLITION EQUIPMENT IN THIS AREA.

DENOTES EXISTING AC PAVEMENT TO BE PROTECTED IN PLACE FROM DAMAGE,




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PROJECT TITLE

BUILDING DEMOLITION 1530 West 17th Street, Santa Ana, CA 92706



2323 NORTH BROADWAY SANTA ANA, CA 92706

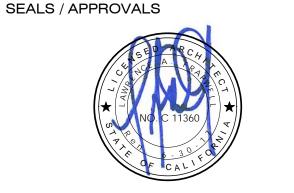SUBMITTALS		
#	DATE	DESCRIPTION
	12/01/2015	90%CD SUBMITTAL
	03/25/2016	100%CD SUBMITTAL
	09/05/2018	BID SET
	 	

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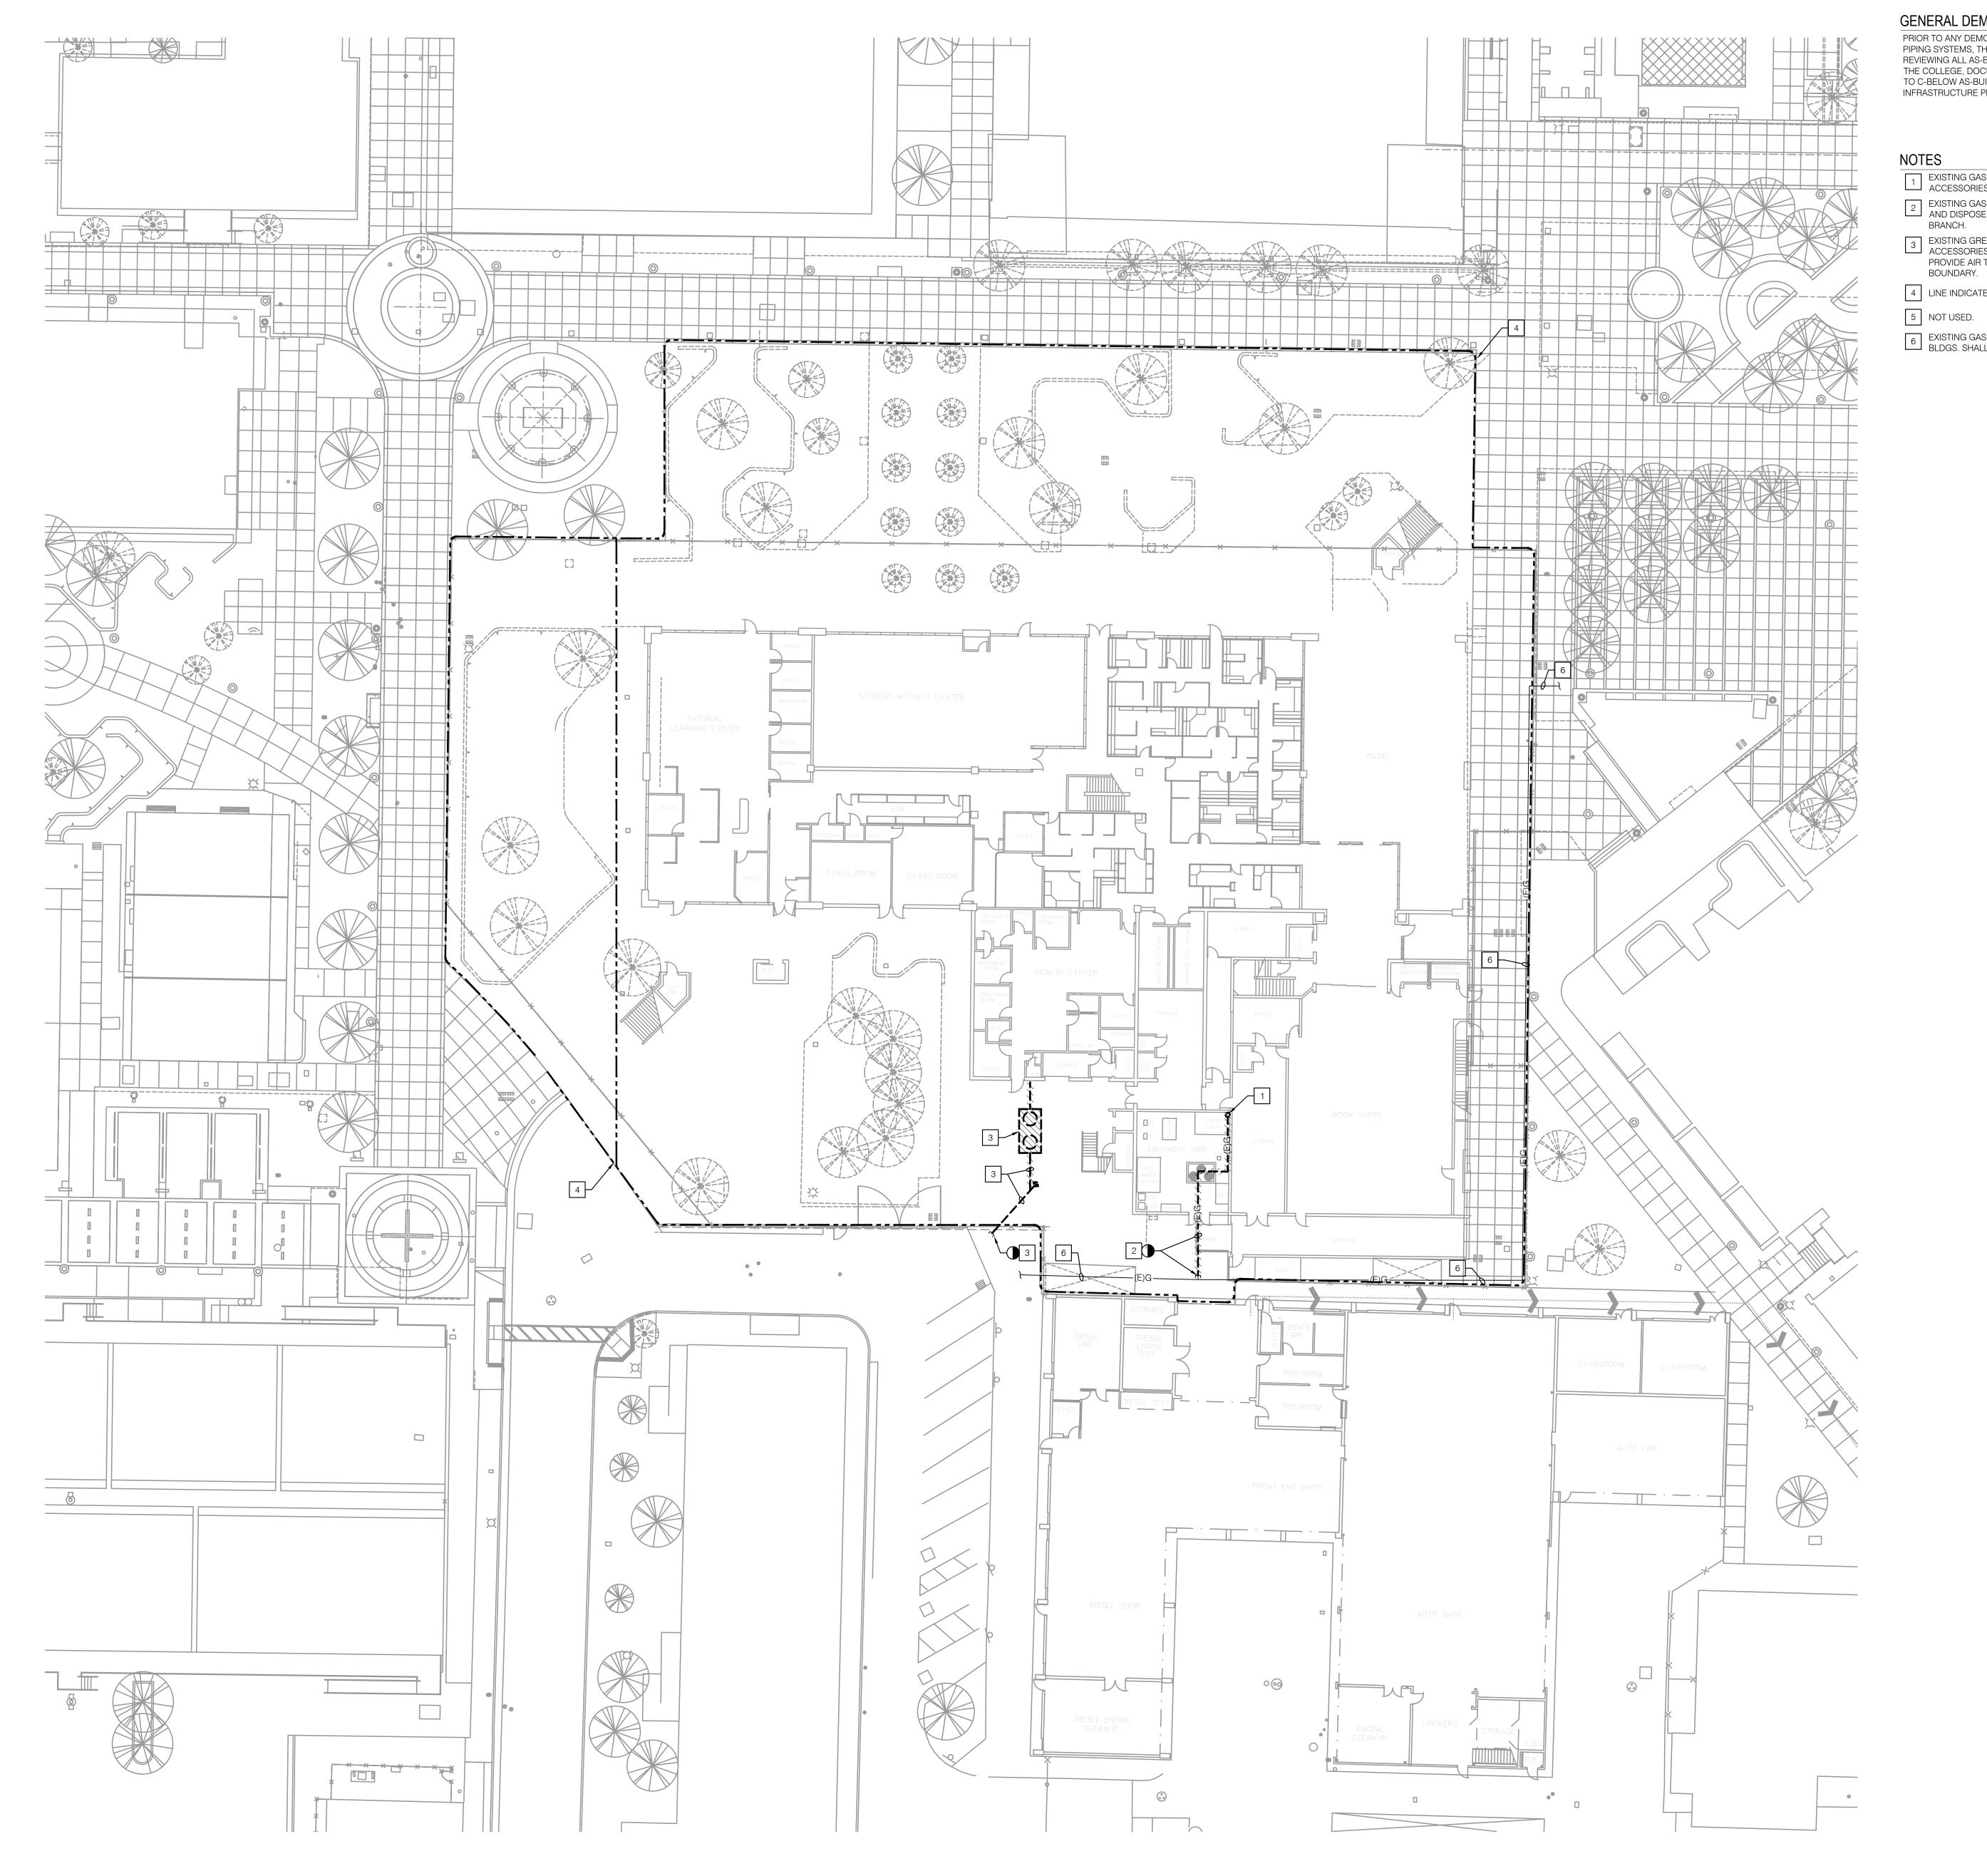
SHEET TITLE

SITE DEMOLITION PLAN - SERVICE ROAD

SHEET NUMBER

A0.02

CONSTRUCTION DOCUMENTS





PRIOR TO ANY DEMOLITION OF THE PLUMBING FIXTURES OR PIPING SYSTEMS, THE CONTRACTOR IS RESPONSIBLE FOR REVIEWING ALL AS-BUILT DOCUMENTATION AVAILABLE FROM THE COLLEGE, DOCUMENTATION INCLUDES BUT NOT LIMITED TO C-BELOW AS-BUILTS & WESTBERGWHITE QUAD AND INFRASTRUCTURE PLANS.

- EXISTING GAS PRESSURE REGULATOR AND RELATED ACCESSORIES TO BE REMOVED AND DISPOSED OF.
- 2 EXISTING GAS PIPING BELOW GRADE TO BE REMOVED AND DISPOSED OF. PROVIDE AIR TIGHT CAP AT MAIN
- 3 EXISTING GREASE INTERCEPTOR AND RELATED ACCESSORIES TO BE REMOVED AND DISPOSED OF. PROVIDE AIR TIGHT CAP AS INDICATED AT DEMOLITION
- 4 LINE INDICATES BOUNDARY OF DEMOLITION WORK.
- 6 EXISTING GAS MAIN BELOW GRADE SERVING MULTIPLE BLDGS. SHALL REMAIN AND BE PROTECTED IN PLACE.



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SEALS / APPROVALS



IDENTIFICATION STAMP DIV. OF THE STATE ARCHITECT A# 0 4 -116810

PROJECT TITLE

JOHNSON STUDENT CENTER BUILDING DEMOLITION 1530 West 17th Street, Santa Ana, CA 92706



2323 NORTH BROADWAY SANTA ANA, CA 92706

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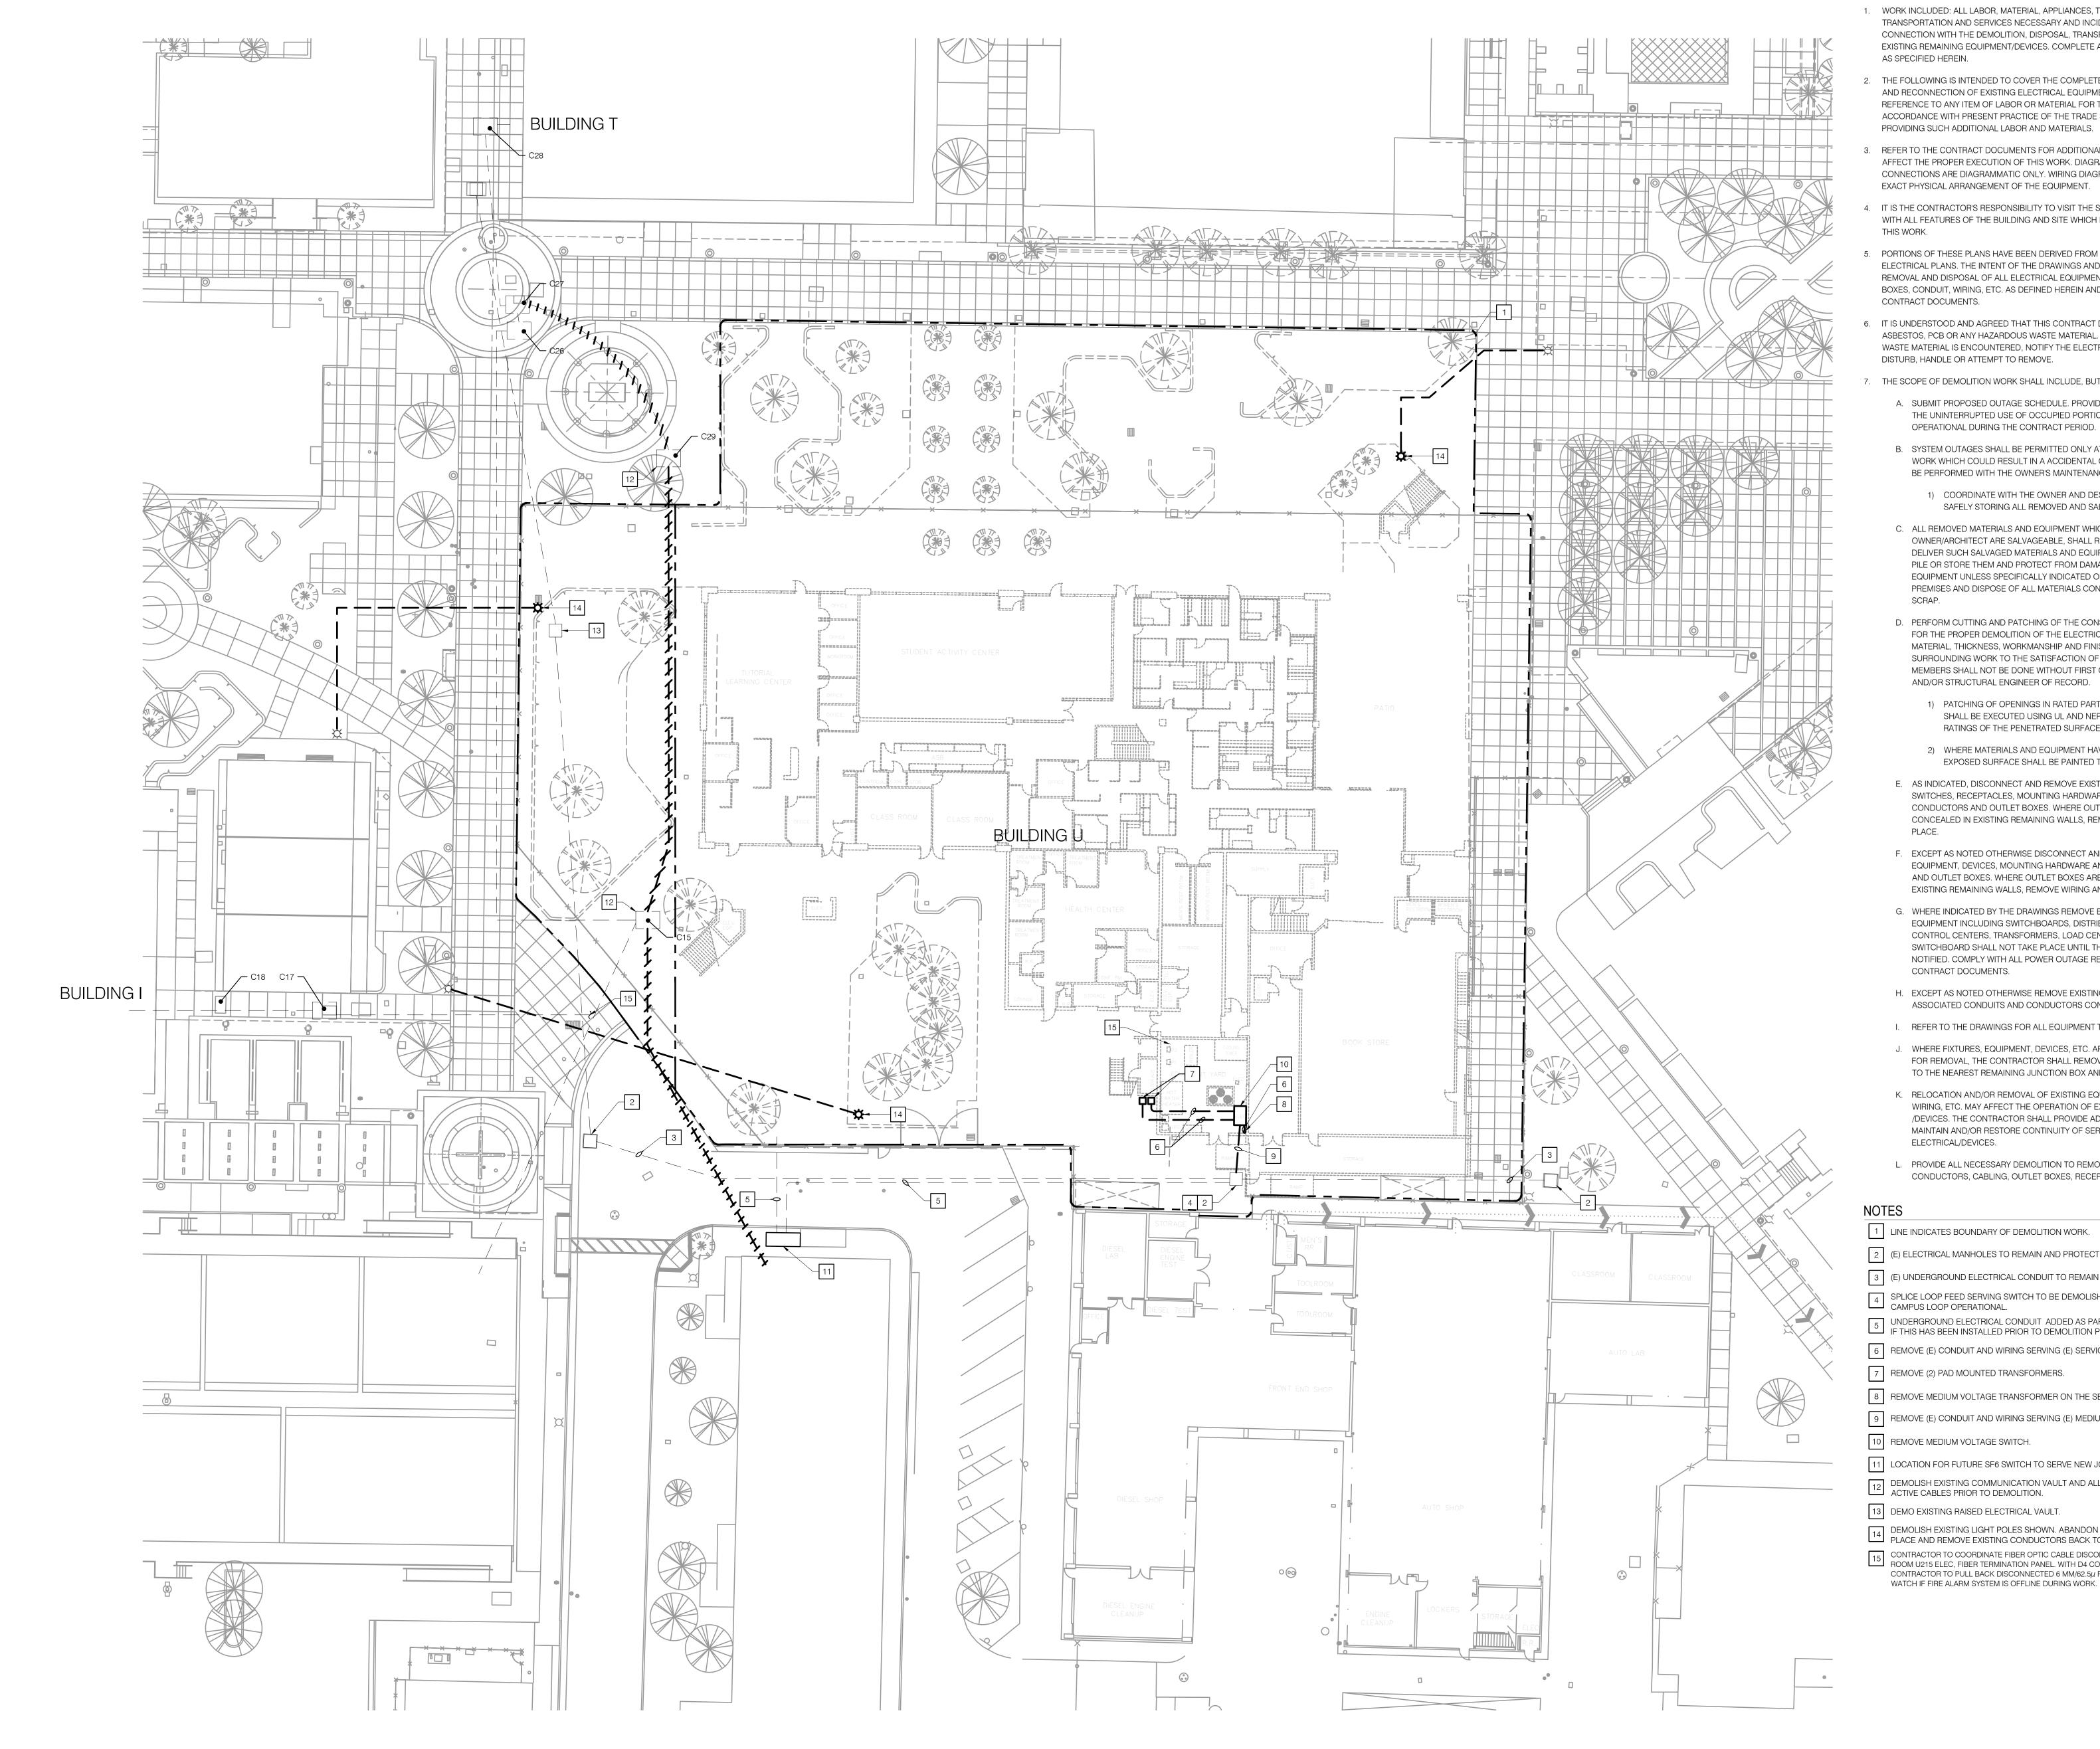
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SITE DEMOLITION PLAN

SHEET NUMBER

PD1.01

BID PACKAGE



DEMOLITION NOTES

- 1. WORK INCLUDED: ALL LABOR, MATERIAL, APPLIANCES, TOOLS, EQUIPMENT, FACILITIES, TRANSPORTATION AND SERVICES NECESSARY AND INCIDENTAL TO PERFORMING ALL OPERATIONS IN CONNECTION WITH THE DEMOLITION, DISPOSAL, TRANSPORTATION AND RECONNECTION OF EXISTING REMAINING EQUIPMENT/DEVICES. COMPLETE AS INDICATED IN THE CONTRACT DOCUMENTS AS SPECIFIED HEREIN.
- THE FOLLOWING IS INTENDED TO COVER THE COMPLETE DEMOLITION, DISPOSAL, TRANSPORTATION AND RECONNECTION OF EXISTING ELECTRICAL EQUIPMENT. THE OMISSION OF EXPRESSED REFERENCE TO ANY ITEM OF LABOR OR MATERIAL FOR THE PROPER EXECUTION OF THE WORK IN ACCORDANCE WITH PRESENT PRACTICE OF THE TRADE SHALL NOT RELIEVE THE CONTRACTOR FROM PROVIDING SUCH ADDITIONAL LABOR AND MATERIALS.
- REFER TO THE CONTRACT DOCUMENTS FOR ADDITIONAL DEMOLITION REQUIREMENTS WHICH AFFECT THE PROPER EXECUTION OF THIS WORK. DIAGRAMS AND SYMBOLS SHOWING ELECTRICAL CONNECTIONS ARE DIAGRAMMATIC ONLY. WIRING DIAGRAMS DO NOT NECESSARILY SHOW THE EXACT PHYSICAL ARRANGEMENT OF THE EQUIPMENT.
- 4. IT IS THE CONTRACTOR'S RESPONSIBILITY TO VISIT THE SITE AND BECOME THOROUGHLY FAMILIAR WITH ALL FEATURES OF THE BUILDING AND SITE WHICH MAY AFFECT THE PROPER PERFORMANCE OF
- PORTIONS OF THESE PLANS HAVE BEEN DERIVED FROM INFORMATION TAKEN FROM ORIGINAL ELECTRICAL PLANS. THE INTENT OF THE DRAWINGS AND SPECIFICATIONS IS TO PROVIDE FOR THE REMOVAL AND DISPOSAL OF ALL ELECTRICAL EQUIPMENT, LIGHTING FIXTURES, DEVICES, OUTLET BOXES, CONDUIT, WIRING, ETC. AS DEFINED HEREIN AND AS INDICATED ELSEWHERE IN THE CONTRACT DOCUMENTS.
- IT IS UNDERSTOOD AND AGREED THAT THIS CONTRACT DOES NOT CONTEMPLATE THE HANDLING OF ASBESTOS, PCB OR ANY HAZARDOUS WASTE MATERIAL. IF ASBESTOS, PCB OR ANY HAZARDOUS WASTE MATERIAL IS ENCOUNTERED, NOTIFY THE ELECTRICAL ENGINEER IMMEDIATELY. DO NOT DISTURB, HANDLE OR ATTEMPT TO REMOVE.
- THE SCOPE OF DEMOLITION WORK SHALL INCLUDE, BUT IS NOT LIMITED TO THE FOLLOWING:
- A. SUBMIT PROPOSED OUTAGE SCHEDULE. PROVIDE A SEQUENCE OF DEMOLITION TO INSURE THE UNINTERRUPTED USE OF OCCUPIED PORTIONS OF THE FACILITY WHICH ARE TO REMAIN OPERATIONAL DURING THE CONTRACT PERIOD.
- B. SYSTEM OUTAGES SHALL BE PERMITTED ONLY AT TIMES APPROVED BY OWNER, IN WRITING. WORK WHICH COULD RESULT IN A ACCIDENTAL OUTAGE (BEYOND BRANCH CIRCUITS) SHALL BE PERFORMED WITH THE OWNER'S MAINTENANCE PERSONNEL ADVISED OF SUCH WORK.
 - 1) COORDINATE WITH THE OWNER AND DESIGNATE A PORTION OF THE FACILITY FOR SAFELY STORING ALL REMOVED AND SALVAGED MATERIALS.
- C. ALL REMOVED MATERIALS AND EQUIPMENT WHICH IN THE OPINION OF THE OWNER/ARCHITECT ARE SALVAGEABLE, SHALL REMAIN THE PROPERTY OF THE OWNER. DELIVER SUCH SALVAGED MATERIALS AND EQUIPMENT ON PREMISES AS DIRECTED, NEATLY PILE OR STORE THEM AND PROTECT FROM DAMAGE. DO NOT REUSE MATERIALS AND EQUIPMENT UNLESS SPECIFICALLY INDICATED ON PLANS OR SPECIFIED. REMOVE FROM PREMISES AND DISPOSE OF ALL MATERIALS CONSIDERED BY THE OWNER/ARCHITECT TO BE
- D. PERFORM CUTTING AND PATCHING OF THE CONSTRUCTION WORK WHICH MAY BE REQUIRED FOR THE PROPER DEMOLITION OF THE ELECTRICAL WORK. PATCHING SHALL BE OF THE SAME MATERIAL, THICKNESS, WORKMANSHIP AND FINISH AS EXISTING AND ACCURATELY MATCH SURROUNDING WORK TO THE SATISFACTION OF THE OWNER. CUTTING OF STRUCTURAL MEMBERS SHALL NOT BE DONE WITHOUT FIRST OBTAINING APPROVAL FROM THE OWNER AND/OR STRUCTURAL ENGINEER OF RECORD.
 - 1) PATCHING OF OPENINGS IN RATED PARTITIONS, BARRIERS, FLOORS, CEILINGS, ETC. SHALL BE EXECUTED USING UL AND NEPA FIRE STOP MATERIAL EQUAL TO THE FIRE RATINGS OF THE PENETRATED SURFACE.
 - 2) WHERE MATERIALS AND EQUIPMENT HAVE BEEN REMOVED AND NOT REPLACED THE EXPOSED SURFACE SHALL BE PAINTED TO MATCH SURROUNDING SURFACE COLOR.
- E. AS INDICATED, DISCONNECT AND REMOVE EXISTING ELECTRICAL EQUIPMENT, DISCONNECT SWITCHES, RECEPTACLES, MOUNTING HARDWARE AND ASSOCIATED RACEWAYS, CONDUCTORS AND OUTLET BOXES. WHERE OUTLET BOXES ARE FLUSH AND CONDUITS ARE CONCEALED IN EXISTING REMAINING WALLS, REMOVE WIRING AND ABANDON CONDUIT IN
- F. EXCEPT AS NOTED OTHERWISE DISCONNECT AND REMOVE EXISTING FIRE ALARM SYSTEM EQUIPMENT, DEVICES, MOUNTING HARDWARE AND ASSOCIATED RACEWAYS, CONDUCTORS AND OUTLET BOXES. WHERE OUTLET BOXES ARE FLUSH AND CONDUITS ARE CONCEALED IN EXISTING REMAINING WALLS, REMOVE WIRING AND ABANDON CONDUITS IN PLACE.
- G. WHERE INDICATED BY THE DRAWINGS REMOVE EXISTING ELECTRICAL DISTRIBUTION EQUIPMENT INCLUDING SWITCHBOARDS, DISTRIBUTION BOARDS, PANELBOARDS, MOTOR CONTROL CENTERS, TRANSFORMERS, LOAD CENTERS, ETC. MODIFICATIONS TO THE MAIN SWITCHBOARD SHALL NOT TAKE PLACE UNTIL THE SERVING UTILITY POWER COMPANY IS NOTIFIED. COMPLY WITH ALL POWER OUTAGE RESTRICTIONS INDICATED ELSEWHERE IN THE CONTRACT DOCUMENTS.
- H. EXCEPT AS NOTED OTHERWISE REMOVE EXISTING TIMESWITCHES CONTACTORS, RELAYS AND ASSOCIATED CONDUITS AND CONDUCTORS CONTROLLING HVAC SYSTEMS.
- I. REFER TO THE DRAWINGS FOR ALL EQUIPMENT TO BE RELOCATED AND REUSED.
- J. WHERE FIXTURES, EQUIPMENT, DEVICES, ETC. ARE SPECIFIED BY THE CONTRACT DOCUMENTS FOR REMOVAL, THE CONTRACTOR SHALL REMOVE ALL CIRCUIT CONDUCTORS/CABLING BACK TO THE NEAREST REMAINING JUNCTION BOX AND/OR POINT OF TERMINATION.
- K. RELOCATION AND/OR REMOVAL OF EXISTING EQUIPMENT, DEVICES, OUTLET BOXES, CONDUIT, WIRING, ETC. MAY AFFECT THE OPERATION OF EXISTING, REMAINING ELECTRICAL EQUIPMENT /DEVICES. THE CONTRACTOR SHALL PROVIDE ADDITIONAL MATERIALS AS REQUIRED TO MAINTAIN AND/OR RESTORE CONTINUITY OF SERVICE TO EXISTING, REMAINING ELECTRICAL/DEVICES.
- L. PROVIDE ALL NECESSARY DEMOLITION TO REMOVE EXISTING UNUSED RACEWAYS, CONDUCTORS, CABLING, OUTLET BOXES, RECEPTACLES, SWITCHES, EQUIPMENT, ETC.

1 LINE INDICATES BOUNDARY OF DEMOLITION WORK.

2 (E) ELECTRICAL MANHOLES TO REMAIN AND PROTECTED IN-PLACE.

3 (E) UNDERGROUND ELECTRICAL CONDUIT TO REMAIN AND BE PROTECT IN-PLACE.

SPLICE LOOP FEED SERVING SWITCH TO BE DEMOLISHED TO BYPASS SWITCH AND KEEP EXISTING

UNDERGROUND ELECTRICAL CONDUIT ADDED AS PART OF CAMPUS INFRASTRUCTURE PROJECT. IF THIS HAS BEEN INSTALLED PRIOR TO DEMOLITION PHASE, PROTECT IN-PLACE.

6 REMOVE (E) CONDUIT AND WIRING SERVING (E) SERVICE TRANSFORMERS.

7 REMOVE (2) PAD MOUNTED TRANSFORMERS.

8 REMOVE MEDIUM VOLTAGE TRANSFORMER ON THE SECOND FLOOR.

9 REMOVE (E) CONDUIT AND WIRING SERVING (E) MEDIUM VOLTAGE SWITCH...

10 REMOVE MEDIUM VOLTAGE SWITCH.

11 LOCATION FOR FUTURE SF6 SWITCH TO SERVE NEW JOHNSON CENTER BUILDING.

DEMOLISH EXISTING COMMUNICATION VAULT AND ALL THAT IT FEEDS. CONFIRM THERE ARE NO ACTIVE CABLES PRIOR TO DEMOLITION.

13 DEMO EXISTING RAISED ELECTRICAL VAULT.

DEMOLISH EXISTING LIGHT POLES SHOWN. ABANDON EXISTING CONDUIT FEEDING LIGHT POLES IN PLACE AND REMOVE EXISTING CONDUCTORS BACK TO UPSTREAM LIGHT POLE.

CONTRACTOR TO COORDINATE FIBER OPTIC CABLE DISCONNECTION IN BUILDING "U" SECOND FLOOR, ROOM U215 ELEC, FIBER TERMINATION PANEL. WITH D4 CONTRACTORS PRIOR TO PERFORMING WORK. CONTRACTOR TO PULL BACK DISCONNECTED 6 MM/62.5 μ FIBER OPTIC CABLE TO VAULT C15. PROVIDE FIRE

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SITE DEMOLITION PLAN **ELECTRICAL**

SHEET NUMBER

ED1.01

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